

U.S. Army Corps of Engineers
New York District

FIRE ISLAND INLET TO MONTAUK POINT GENERAL REFORMULATION REPORT

APPENDIX H REAL ESTATE PLAN

JULY 2016

**FIRE ISLAND TO MONTAUK POINT
GENERAL REFORMULATION REPORT**

JULY 2016 REAL ESTATE PLAN

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1. Preamble

Project Authorization: The Fire Island Inlet to Montauk Point, NY, Combined Beach Erosion Control and Hurricane Protection Project (“FIMP”) was authorized by the River and Harbor Act of 14 July 1960. The authorization provides for beach erosion control and hurricane protection along five reaches of the Atlantic Coast of New York from Fire Island Inlet to Montauk Point, a distance of about 83 miles, by widening the beaches along the developed areas to a minimum width of 100 feet, with an elevation of 14 feet above mean sea level, and by raising dunes to an elevation of 20 feet above mean sea level, from Fire Island Inlet to Hither Hills State Park, at Montauk and opposite Lake Montauk Harbor.

The original authorization also provides for the construction of up to 50 groins, grass planting on the dunes, interior drainage structures at Mecox Bay, Sagaponack Lake and Georgica Pond, and beach re-nourishment for a period of ten years after initial construction. The authorized plan is shown Figure 3, which shows the five reaches that were to be developed and implemented:

Reach 1 – Fire Island Inlet to Moriches Inlet

Reach 2 – Moriches Inlet to Shinnecock Inlet

Reach 3 – Shinnecock Inlet to Southampton

Reach 4 – Southampton to Beach Hampton

Reach 5 – Beach Hampton to Montauk Point

This authorization has been modified by Section 31 of the Water Resources Development Act (WRDA) of 1974, and Sections 103, 502, and 934 of the WRDA of 1986 (P.L. 99-662), which modified the cost-sharing percentages and the period of renourishment. As mentioned previously the reformulated FIMP project is also eligible for funding under PL 113-2, which would be at “full federal expense.”

Official Project Designation: Fire Island Inlet to Montauk Point Reformulation Study, or the “Project.”

Project Location: The Project is located within Suffolk County, New York along the south shore of Long Island between Fire Island Inlet and Montauk Point, and lies within the towns of Babylon, Islip, Brookhaven, Southampton and East Hampton.

Non-Federal Sponsor: The Non-Federal Sponsor for this Project is the State of New York through its Department of Environmental Conservation (the “Sponsor” or “NYSDEC”). Through separate agreement, NYSDEC has engaged the County of Suffolk as the Local Sponsor (the “Local Sponsor”).

2. Statement of Purpose

This Real Estate Plan (“REP”) is prepared in support of the Fire Island to Montauk Point General Reformulation Report. As such, this REP will replace the following prior REPs: Fire Island Inlet to Moriches Inlet Stabilization Project, approved June 2014; Downtown Montauk Stabilization Project, approved October 2014; Westhampton Interim Project, approved January 1998, West of Shinnecock Interim Project, approved November 1995.

3. Project Purpose and Features

a. Project Purpose:

The Fire Island Inlet to Montauk Point, New York Combined Beach Erosion Control and Hurricane Protection Project (FIMP) was authorized by the River and Harbor Act of 1960. The project is being reformulated to identify a long-term solution to manage the risk of coastal storm damages along the densely populated and economically valuable south shore of Long Island, New York in a manner which balances the risks to human life and property, while maintaining, enhancing, and restoring ecosystem integrity and coastal biodiversity.

There is a long history of damaging storms along the south shore of Long Island, as well as many efforts to mitigate the damages, including construction of several features of the authorized FIMP project that are described later in this chapter. The study area also includes critical coastal habitat and environmentally sensitive areas, such as the Fire Island National Seashore and the Smith Point County Park.

This current study is called a Reformulation, because it reexamines the project that was originally formulated in the 1950’s. This Reformulation came about in part due to a referral to the Council on Environmental Quality in response to the 1978 Environmental Impact Statement (EIS) that was prepared for the project subsequent to passage of the National Environmental Policy Act of 1969. As a result of the referral the Corps of Engineers agreed to reformulate the project with particular emphasis on identifying and evaluating a broad array of alternatives in the context of cumulative impacts on the overall coastal system. The goal of the Reformulation study is to identify an economically viable, environmentally acceptable plan that addresses the storm damage reduction needs of the study area and is acceptable to the key federal, state, and local stakeholders. Included within the study area is the Fire Island National Seashore FIIS. The authorizing law for FIIS specified that any plan for shore protection within the boundary of the national Seashore be mutually agreeable with the Secretary of the Interior and Secretary of the Army.

Given the complex system and the large number of stakeholders, a collaborative planning approach has been utilized to involve the key stakeholders and the public. An Interagency Reformulation Group (IRG) was established that provided executive level leadership for the study from the key federal and State agencies. The IRG developed and signed a vision statement that identified the broad objectives for the study. The IRG also established various Technical Management Groups that included agency members, as well as non-governmental organizations and academia.

In May 2009, a draft report was provided to the key government partners and stakeholders that identified the problems, opportunities, objectives and constraints, provided a detailed analysis of the alternatives, and identified several alternative plans for consideration. Based on the comments received and subsequent discussions among the key stakeholders, a Tentative Federally Supported Plan (TFSP) was developed in 2012. Appendix E - Plan Formulation provides the detailed formulation process that led to the 2009 draft report and the subsequent coordination and modifications that led to the TFSP. This Main report presents the subsequent amendments to the TFSP to develop the Tentatively Selected Plan, and to demonstrate that the plan is an economically justified coastal risk management action.

On October 29, 2012, Hurricane Sandy made landfall approximately five (5) miles south of Atlantic City, NJ, where it collided with a blast of arctic air from the north, creating conditions for an extraordinary historic ‘super storm’ along the East Coast with the worst coastal impacts centered on the northern New Jersey, New York City, and the Long Island coastline. Hurricane Sandy’s unusual track and extraordinary size generated record storms surges and offshore wave heights in the New York Bight. The maximum water level at The Battery, NY peaked at 12.4 feet NGVD, exceeding the previous record by over 4 feet. Coastal erosion and damages within the FIMP study area as a result of Hurricane Sandy were severe and substantial. For example, post-Sandy measurements of volume loss of the beach and dunes on Fire Island indicated that the subaerial beach lost 55 percent of its pre-storm volume equating to a loss of 4.5 million cubic yards. A majority of the dunes either were flattened or experienced severe erosion and scarping. Following Hurricane Sandy, New York State and its sub agreement partners responded to the USACE request for concurrence with the TFSP. The subsequent refinements to the TFSP were an additional phase in the iterative planning approach, and are described in Chapter 5, Plan Formulation.

This report will serve as a decision document for implementation of the reformulated FIMP project, which includes portions of the project that have been previously constructed and also portions that are planned for construction as “emergency stabilization projects”, in accordance with the Disaster Relief Appropriations Act of 2013 (P.L. 113-2). As an “authorized, but unconstructed” project, the reformulated FIMP project is eligible for funding under PL 113-2 at full federal expense.

b. Plan of Improvement:

Based on post Hurricane Sandy conditions the modifications described above have been incorporated into the TSP. The updated TSP is summarized below and presented in detail on the project plates provided in Appendix A1.

Inlet Modifications

- Continuation of authorized navigation projects, and scheduled O&M dredging with beneficial reuse of sediment at Fire Island, Moriches and Shinnecock Inlets:

- Additional dredging of equivalent of 100,000 cy from the ebb shoals of each inlet, outside of navigation channel, with downdrift placement undertaken in conjunction with scheduled O&M dredging of the inlets.
- Placement of a +13 ft. dune and berm, as needed in identified placement areas.
- Monitoring to facilitate adaptive management changes in the future.

Mainland Non-Structural

- Addresses approximately 4,400 structures within 10 year flood plain using non-structural measures, primarily through building retrofits, with limited buy-outs, based upon structure type and condition.
- Also includes road raising in four locations, totaling 5.91 miles in length, that protects 1,020 houses.

Barrier Islands

- Breach Response
 - Proactive Breach Response - is triggered when the breach and dune are lowered below a 25 year design level of risk reduction and provides for restoration to the design condition (+13 ft. dune and 90 ft. berm). It will be utilized on Fire Island in vicinity of Lighthouse, Smith Point County Park East (to supplement when needed the sand bypassing), and Smith Point County Park West (after short-term beachfill to allow relocation of infrastructure) and also on the Westhampton barrier island fronting Shinnecock Bay.
 - Reactive Breach Response - is triggered when a breach has occurred, e.g. the condition where there is an exchange of ocean and bay water during normal tidal conditions. It will be utilized as needed when a breach occurs.
 - Conditional Breach Response - applies to the large, federally-owned tracts within Fire Island National Seashore, where the National Park Service determines whether a breach should be closed. Conditional Breach closure provides for a 90 ft wide berm at elevation 9.5 ft. only.
- Beach and Dune Fill
 - Provides for a continuous 90 ft. width berm and +15 ft. dune along the developed shorefront areas fronting Great South Bay and Moriches Bay on Fire Island and Westhampton barrier islands.
 - On Fire Island the alignment follows the post-Sandy optimized alignment that includes overfill in the developed locations and minimizes tapers into Federal tracts.
 - Renourishment: up to 30 years approximately every 4 years.

Sediment Management at Downtown Montauk and Potato Road

- Provides for placing about 120,000 CY on front face of existing berm at each location approximately every 4 years as advance fill to offset erosion.
- The Potato Road feeder beach is contingent upon implementation of a local pond opening management plan for Georgica Pond.

Groin Modifications

- Shorten existing Westhampton groins (1-13) between 70 — 100 ft., to increase sediment transport (0.5M to 2M CY) to the west and reduce re-nourishment requirements.

- Modify existing Ocean Beach groins.

Coastal Processes

- 13 Restoration measures were included that contribute to the restoration of the coastal processes consistent with the Reformulation objectives. These measures are necessary to sustain the physical integrity of the natural systems.

Adaptive Management

- Will provide for monitoring and the ability to adjust specific project features to improve effectiveness.
- Climate change will be accounted for with the monitoring of climate change parameters, identification of the effect of climate change on the project design, and identification of adaptation measures that are necessary to accommodate climate changes as it relates to all the project elements.

Integration of Local Land Use Regulations and Management

- Local land management regulations to include enforcement of federal and state zoning requirements, as a necessary component for long-term risk reduction. These measures are described in detail in Appendix X.

c. Project Phases

The Project utilizes a combination of features over its broad geographic scope on the south shore of Long Island. A summary of the Project phases is as follows:

Contract 1 – Inlet Dredging: Fire Island
 Contract 2 – Inlet Dredging: Moriches, Shinnecock
 Contract 3 – Tiana Beach, Downtown Montauk, Potato Road Beachfill
 Contract 4 – Smith’s Point/Westhampton Beachfill
 Contract 5 – Fire Island at Developed Locations (communities)
 Contract 6 – Ocean Beach
 Contract 7 – Westhampton

Mainland Nonstructural

Contract 8 – Road Raising
 Contract 9 – Year 1 Non-Structural Inventory
 Contract 10 – Year 2 Non-Structural Inventory
 Contract 11 – Year 3 Non-Structural Inventory
 Contract 12 – Year 4 Non-Structural Inventory
 Contract 13 – Year 5 Non-Structural Inventory

d. Required Lands, Easements, and Rights-of-Way (LER):

This report will detail the real estate needs for the construction of the new proposed elements for the Project. Due to the breadth of real estate already acquired for the previously constructed projects subsumed into FIMP, those real estate interests will only be summarized.

I. Fee (Standard Estate No. 1) – The nonstructural component of this project includes the fee acquisition of four nonresidential structures encompassing approximately 0.49 acres of land, **4 parcels**, and **4 private owners**. As the fee acquisition of the properties is mandatory, P.L. 91-646 benefits may be available to property owners. See paragraph 12 below for further detail.

II. Perpetual Beach Storm Damage Reduction Easement (Standard Estate No. 26) – Perpetual Beach Storm Damage Reduction Easements must be acquired over approximately **502.87** acres of land, impacting **424 parcels**, and **366 private owners** and **5 public** owners. The location of the Permanent Easements is identified in Exhibit B. Due to State of New York restrictions on the alienation of public land, requisite access to public lands will be authorized through Access Agreements. See paragraph 20(a) below for further detail.

III. Nonstructural Floodproofing Agreement – A Nonstructural Floodproofing Agreement (the “Agreement”) must be executed between the Sponsor and the property owner wherever nonstructural floodproofing treatments will be implemented, and attached hereto in Exhibit C. The purpose of the Agreement is twofold: to serve as a contract between property owner and the local sponsor, and to restrict future development of the site below a stated elevation. Nonstructural floodproofing measures will be offered to owners of eligible structures on a voluntary basis. Structures identified as eligible will, in addition, have to meet the following criteria:

- Owner is willing to participate in the nonstructural program and execute a Floodproofing Agreement containing a restrictive covenant limiting development of the property below the determined elevation.
- Structure is safe, decent and sanitary condition
- Owner possesses clear title to the property
- Structure and appurtenant land is not contaminated with hazardous, toxic or radioactive waste or materials
- Owner does not owe taxes or other debts to any state or local government entity or to the Federal Government
- Owner has not previously received any disaster assistance for the elevation of the structure
- Property owner is willing to expend costs that may be necessary in connection with the elevation of the structure which are not eligible costs covered by the program (i.e. temporary housing during construction)

Structures categorized within the voluntary program will be elevated or flood proofed only with the owner’s consent. Where owners are willing to participate, but structures do not meet the program criteria, if cure is possible, owners will be afforded the opportunity to cure any defect in the structure, otherwise applications for ineligible structures will be denied.

Eminent domain authority will not be used to require landowners in this category to participate in the program; however, tenants who reside in structures to be elevated may be eligible for certain benefits in the accordance with Uniform Relocation Assistance and Real Property Acquisition Policies for Federal and Federally Assisted Programs of 1970. See 49 C.F.R. 24.101(a)(2) for additional detail.

Where owners of eligible properties elect to participate in the Project, the following process shall be implemented:

- Property owner deliver a completed application for structure elevation to the Project Partner. The application must be signed by all owners and lien-holders of the property and structure;
- Project Partner shall ensure property meets all eligibility criteria;
- Property owner shall submit to Project Partner proof of ownership and a current Elevation Certificate;
- Project Partner shall conduct a title search to verify clear title;
- Project Partner shall conduct a Phase I HTRW/asbestos investigation. All asbestos must be abated and disposed of properly.
- Floodproofing Agreement is executed by property owner and Project Partner and recorded with the Monmouth County clerk.
- Elevation of structure is completed.

IV. Temporary Work Area Easement (Standard Estate No. 15) - Temporary work areas may be necessary for this project, but have not yet been identified. The need for temporary work areas will be identified during the Plans and Specs phase. The proposed temporary work areas are typically adjacent to land to be acquired for Project construction.

V. Borrow Area – The Project proposes to nourish the beach using sand from various Offshore Borrow Areas located New York State waters. NYSDEC will provide the Corps with authorization to use the Borrow Areas as a sand source through a New York Environmental Conservation Law Section 401 Water Quality Certificate (“WQC”). The WQC functions as a permit allowing borrow of the necessary volume of sand to complete the Project. The Corp of Engineers has obtained water quality certificates from NYS DEC in support of other projects.

VI. LER Summary - The impacted parcels and LER to be acquired are provided in Exhibit B and the recommended standard estate language in Exhibit C herein. The following chart summarizes the required LER for the Project:

Required Interest	Required Acres	Acres Below the MHWM	Number of Parcels		Number of Owners		Acquisition Cost
			Private	Public	Private	Public	
Beachfill and Breach Contingency Plan							

Perpetual Beach Storm Damage Reduction Easement	±502.87	±18.83	377	47	366	5	\$5,997,233
Nonstructural							
Non-Structural Floodproofing Agreement	±216.44	0.00	4138	TBD	TBD	TBD	\$0.00
Fee	±0.49	0.00	4	0	4	0	\$2,615,090
Coastal Processes*							
TBD							

* Real estate requirements for Coastal Process Features will be determined after publication of this report during the plans and specs phase. All Coastal Process Features are to be constructed on public lands and should not incur additional acquisition costs. Maps of the Coastal Process Features developed for planning purposes are included in Appendix A1.

e. Appraisal Information:

Consistent with USACE Real Estate Policy Guidance Letter No. 31 – Real Estate Support to Civil Works Planning Paradigm (3x3x3), the New York District valued the real estate requirements through a cost estimate as the real estate costs will total less than 10% of the total project costs. A 20% contingency is included in the estimated value of the LER. As of 23-MAR-2016, an appraiser in the New York District Real Estate Division has reviewed and approved of the cost estimate.

Appraised of the required LER.....\$9,332,323
Date of Value.....23-MAR-2016

4. LERRD Owned by the Non-Federal Sponsor

The Non-Federal Sponsor, The State of New York via the NYSDEC owns 438.86 acres of land required for the Project, including lands below the mean high water line. In addition, the NYSDEC served as the NFS on the previously constructed Federal projects in this area. The lands acquired for the previously constructed projects are held by NYSDEC's local sponsor, the County of Suffolk. The real estate required to construct the four previously constructed Federal projects in the area:

Real Estate Requirements of Previously Constructed Projects				
	Easement Acquisitions	Fee Acquisitions	Required Acres	Total Tracts

• Fire Island Inlet to Moriches Inlet Stabilization Project*	623	41	546.50	664
• Downtown Montauk Stabilization Project	18	0	12.63	18
• Westhampton Interim Project	308	0	172.03	308
• West of Shinnecock Inlet Interim Project	4	0	56.26	4
Total:	953	41	<u>787.42</u>	994

* Acquisition of real estate required for the Fire Island Inlet to Moriches Inlet Stabilization Project is ongoing.

The NFS shall not receive credit for lands acquired for previously constructed projects. Similarly, the NFS shall not receive credit for publicly owned lands required for the Project.

5. Non-Standard Estates

No non-standard estates are proposed for use in real estate acquisition for the Project.

6. Existing Federal Projects

The Project will subsume four previously constructed Federal projects: Westhampton Interim Project, West of Shinnecock Interim Project, Fire Island Inlet to Moriches Inlet Stabilization Project, and the Downtown Montauk Stabilization Project.

a. Westhampton Interim Project – A plan to provide interim protection to the Westhampton Beach area west of Groin 15 and the affected mainland communities north of Moriches Bay was completed in July 1995. The plan provides for a protective beach berm 90 feet wide and a dune of +15 ft NGVD¹, tapering of the western two existing groins (groins 14 and 15) and construction of an intermediate groin (groin 14a) between these two. The project also includes periodic nourishment, as necessary to ensure the integrity of the project design, for up to 30 years (2027). Beachfill for this interim project also includes placement within the existing groin field to fill the groin compartments and encourage sand transport to the areas west of groin 15. The interim plan was determined to be in the Federal interest to provide protection until the findings of the reformulation effort are available. Initial construction of the project was completed in December 1997.

b. West of Shinnecock Interim Project – The West of Shinnecock Interim Project provides for beach re-nourishment for the area immediately west of Shinnecock Inlet and a protective beach berm and dune, fronted by advance fill for the area 4,000 feet immediately west of Shinnecock Inlet.

¹ National Geodetic Vertical Datum of 1929 (NGVD29 or NGVD) is approximately 1.06 feet higher than North American Vertical Datum of 1988 (NAVD88 or NAVD) within the FIMP study area.

c. Fire Island Inlet to Moriches Inlet Stabilization Project – The Fire Island Inlet to Moriches Inlet Stabilization Project (“FIMI”) is designed to provide coastal storm risk management from coastal erosion and tidal inundation through construction of a beach berm and dune, at Fire Island Inlet to Moriches Inlet, New York. The project area stretches from Robert Moses State Park in the west to Smith Point County Park in the east for a total of 19 miles. The purpose of the project is to provide a level of storm damage protection to mainland development protected by the barrier island.

d. Downtown Montauk Stabilization Project - The Downtown Montauk Stabilization project is designed to provide coastal storm risk management from coastal erosion through construction of 3,100ft of reinforced dune within the hamlet of Montauk, New York. The proposed dune extends west to east from South Emery Street to Atlantic Terrace Motel and tapers into high dunes at both ends of the project area, which will provide protection to the shorefront existing commercial buildings in downtown Montauk.

Each of these projects is a Coastal Storm Risk Management project and exists entirely within the Project Area. NYSDEC is the Non-Federal Sponsor for each of these projects and acquired necessary real estate. The Perpetual Beach Storm Damage Reduction Easement (Standard Estate No. 26) was used where easement acquisitions were necessary. The owners of the lands, easements and rights-of-way are in support of the Project. The lands, easements and rights-of-way acquired for the previously constructed projects will support FIMP and are summarized as follows:

7. Federally-Owned Land

51.78 acres of Federally-owned land, under the management of Fire Island National Seashore, a unit of the National Park Service, is included within the lands required for the Project. Access to these lands is required for beachfill purposes. Superintendent of Fire Island National Seashore is an engaged partner and supports this plan of improvement. A special use permit providing access coextensive with the Perpetual Beach Storm Damage Reduction Easement will be obtained from the National Park Service to grant the necessary access.

8. Navigational Servitude

Approximately **18.83** of land required for the Perpetual Beach Storm Damage Reduction Easement lies below the Mean High Water Line (“MHWL”). Although it is the general policy of the Corps to utilize the navigational servitude in all situations where available, whether or not the Project is cost-shared or full Federal, this Project does not directly serve a purpose which is in the aid of commerce. Therefore, rights in the Federal navigational servitude will not be exercised for the Project. This is consistent with CECC-R memorandum dated 19 March 2014, subject: Availability of the Navigational Servitude for Coastal Storm Damage Reduction Projects.

9. Maps

The Project real estate maps are provided in Exhibits “A” herein.

10. Induced Flooding

Construction, operation or maintenance of the Project is not anticipated to induce any flooding.

11. Baseline Cost Estimate for Real Estate (“BCERE”)

An itemized BCERE is provided in Exhibit “D” in Micro-Computer Aided Cost Estimating System (“MCACES”) format with estimated real estate costs. The following is a summary of the costs for the Lands, Easements, Rights-of-Way, Relocations, and Disposals (“LERRD”) required for new elements of the Project:

<u>Cost Type</u>	<u>Total</u>
Land Payments.....	\$9,332,323
Incidental Expenses.....	<u>\$39,316,071</u>
Total 01-Lands and Damages.....	\$48,648,395
Total 02-Relocations.....	<u>\$30,098,600</u>
Total LERRD Cost.....	\$78,746,995
 Federal Review and Assistance Costs...	 \$3,350,963
Total 30-Project Management.....	\$3,350,963

The 20% contingency is added to the overall real estate costs excluding the Land Payments amount \$6,643,990 shown in line item 01B1 of each contract’s the BCERE, because a contingency for Land Payments is separately provided in the appraisal cost estimate. If approved, the Project will be 100% federally funded utilizing funds provided by P.L. 113-2. The Sponsor will be entitled to LERRD reimbursement subject to the terms of the Project Partnership Agreement. As of this report, no reimbursable LERRD related expenses have been incurred by the Sponsor.

Non-Federal Sponsor Costs

<u>Incidental Cost</u>	<u>Cost</u>	<u>Total</u>
Non-Federal-----	\$32,643,393	
Federal-----	<u>\$0</u>	
Subtotal:		<u>\$32,643,393</u>
 <u>Acquisition Cost</u>		
Non-Federal-----	\$9,332,323	

Federal-----	\$0
Subtotal:	<u>\$9,332,323</u>
20 % Contingency (less Land Payments) ² -----	<u>\$6,672,679</u>
Total Lands and Damages-----	<u>\$48,648,395</u>

12. Public Law 91-646, Uniform Relocation Assistance

Relocation assistance benefits in accordance with Public Law 91-646, Uniform Relocation Assistance and Real Property Acquisition Policies Act of 1970, (hereinafter “P.L. 91-646”), may be required for the Project. The nonstructural component of the Project requires acquisition of four nonresidential properties in fee. The acquisition of the following parcels and improvements thereupon may result in displaced businesses qualified for relocation benefits in the amounts estimated below. The below values for relocation assistance are estimates only, and are not a guarantee of reimbursement.

Structure ID	Moving Expenses	Related Expenses	Reestablishment Expenses	Estimated Assistance Total
154-27	\$50,000	\$20,000	\$10,000	\$80,000
154-28	\$50,000	\$20,000	\$10,000	\$80,000
198-117	\$50,000	\$20,000	\$10,000	\$80,000
248-99	\$50,000	\$20,000	\$10,000	<u>\$80,000</u>
			Total:	<u>\$320,000</u>

Along with the cost to acquire the property of a displaced person, there are three basic types of financial relocation assistance payments provided to nonresidential occupants: 1) a moving expense payment; 2) a related expense payment; and 3) a reestablishment expenses payment. These costs are intended to compensate a displaced person for the additional costs he/she will incur in relocating her or his business.

a. Moving Cost Reimbursement

I. *Moving Expense Payment:* Owners or tenants may be paid on the basis of actual, reasonable moving costs and related expenses. Actual, reasonable moving expenses may be paid when the move is performed by a professional mover or if performed by the displaced person. Related expenses, such as personal property losses, expenses in finding a replacement site, and reestablishment expenses may also be reimbursable. All moving costs must be supported by paid receipts or other evidence of expenses incurred. In addition to the transportation costs of personal property, certain other expenses may be reimbursable, such as

² The overall 20% contingency is not applied to the value of land payments. The estimated value of land payments has a built in contingency provided in the cost estimate. A 20% contingency is applied to the remaining Lands and Damages costs as detailed in Appendix D.

packing, crating, unpacking and uncrating, and the disconnecting, dismantling, removing, reassembling, and reinstalling relocated machinery, equipment and other personal property.

II. *Direct Loss of Personal Tangible Property:* Displaced businesses may be eligible for a payment for the actual direct loss of tangible personal property which is incurred as a result of the move or discontinuance of the operation. This payment is based on the lesser of the value of the item for continued use at the displacement site less the proceeds from its sale, or the estimated cost of moving the item.

III. *Searching Expenses for Replacement Property:* Displaced businesses, farms, and nonprofit organizations are entitled to reimbursement for actual, reasonable expenses incurred in searching for a replacement property, not to exceed \$2,500. Expenses may include transportation, meals, and lodging when away from home; the reasonable value of the time spent during the search; and other expenses determined to be reasonable and necessary by the Agency. Fees paid to real estate agents or brokers to locate a replacement site may be reimbursed, exclusive of any commissions or fees related to the purchase of the site. Commissions and fees related to the purchase of a replacement site are not eligible relocation expenses and will not be reimbursed.

b. **Related Eligible Expenses** - In addition to the moving expenses listed above, costs for these items may be reimbursed if the Agency determines they are actual, reasonable, and necessary:

- I. Connection to available nearby utilities from the right-of-way to improvements at the replacement site.
- II. Professional services to determine a sites' suitability for the displaced person's operation.
- III. Impact fees or one time assessments for heavy utility usage as determined necessary by the Agency.

c. **Business Reestablishment Expenses** - A small business may be eligible for a payment, not to exceed \$10,000, for expenses actually incurred in relocating and reestablishing the enterprise at a replacement site. To qualify, the business must have not more than 500 employees working at the site who will be displaced by a program or project. Reestablishment expenses may include, but are not limited to:

- I. Repairs or improvements to the replacement real property required by Federal, State, and local laws, codes or ordinances.
- II. Modifications to the replacement real property to make the structure(s) suitable for the operation.
- III. Construction and installation costs of exterior advertising signs.
- IV. Redecoration or replacement such as painting, wallpapering, paneling, and carpeting when required by the condition of the replacement site.
- V. Advertising the replacement location.
- VI. Estimated increased costs of operation at the replacement site during the first two years for items such as: lease or rental charges; personal or real

property taxes; insurance premiums; utility charges (excluding impact fees).

VII. Other items that the Agency considers essential for reestablishment.

The total estimated relocation assistance benefits paid in support of the Project is approximately **\$320,000**. The estimated cost to acquire the properties has been factored in as part of the LER acquisition cost for the Project.

13. Minerals and Timber Activity

No known present or anticipated mineral activities or timber harvesting in the vicinity of the Project.

14. Land Acquisition Experience and Capability of the Non-Federal Sponsor

The Sponsor maintains the legal and professional capability and experience to acquire the LERRD in support of the Project. The Sponsor, through its Local Sponsor County of Suffolk, has condemnation authority and other applicable authorities that may apply if necessary to support acquisition measures. The Sponsor has successfully acquired the real estate for the Downtown Montauk Stabilization Project, Coney Island FCCE Project, and is currently the non-Federal Sponsor for the Fire Island Inlet to Moriches Inlet Stabilization Project and the Asharoken Coastal Storm Risk Management Feasibility Study, among others. The Sponsor has also been advised of P.L. 91-646 requirements and the requirement to document expenses for crediting purposes.

The Non-Federal Sponsor Capability Assessment Checklist is provided in Exhibit “E”. The assessment checklist has been coordinated with the Sponsor. It has been completed based on the Sponsor’s past and current performance on other Corps of Engineers cost-shared civil works projects. The completed and executed checklist will be added to the final report as Exhibit E.

15. Zoning

The Project will not require enactment of land use ordinances prior to construction; however, land use policies recommended to minimize the risk of damage from coastal storms are contained in Appendix H Land Management Appendix. These land use policies are recommended for implementation at the local level.

16. Schedule of Acquisition

The proposed schedule of acquisition is outlined below.

	<u>Milestone</u>	<u>Date</u>
BEACHFILL DREDGING	PPA Execution-----	JAN-2018
	Sponsor's Notice to Proceed with Acquisition-----	JAN-2018
	Contract 1 Authorization for Entry for Construction-----	SEP-2018
	Contract 1 Certification of Real Estate-----	SEP-2018
	Contract 1 Ready to Advertise for Construction-----	SEP-2018
	Contract 3 Authorization for Entry for Construction-----	JAN-2020
	Contract 3 Certification of Real Estate-----	JAN-2020
	Contract 3 Ready to Advertise for Construction-----	JAN-2020
	Contract 4 Authorization for Entry for Construction-----	JAN-2021
	Contract 4 Certification of Real Estate-----	JAN-2021
NONSTRUCTURAL	Contract 4 Ready to Advertise for Construction-----	JAN-2021
	Contract 8 Authorization for Entry for Construction-----	JUN-2019
	Contract 8 Certification of Real Estate-----	JUN-2019
	Contract 8 Ready to Advertise for Construction-----	JUN-2019
	Contract 9 Authorization for Entry for Construction-----	SEP-2020
	Contract 9 Certification of Real Estate-----	SEP-2020
	Contract 9 Ready to Advertise for Construction-----	SEP-2020
	Contract 10 Authorization for Entry for Construction-----	SEP-2021
	Contract 10 Certification of Real Estate-----	SEP-2021
	Contract 10 Ready to Advertise for Construction-----	SEP-2021
	Contract 11 Authorization for Entry for Construction-----	SEP-2022
	Contract 11 Certification of Real Estate-----	SEP-2022
	Contract 11 Ready to Advertise for Construction-----	SEP-2022
	Contract 12 Authorization for Entry for Construction-----	SEP-2023
	Contract 12 Certification of Real Estate-----	SEP-2023
	Contract 12 Ready to Advertise for Construction-----	SEP-2023
	Contract 13 Authorization for Entry for Construction-----	SEP-2024
	Contract 13 Certification of Real Estate-----	SEP-2024
	Contract 13 Ready to Advertise for Construction-----	SEP-2024

17. Facility / Utility Relocations

Non Structural Road Raisings

Included in the non-structural plan are road raisings as a means to achieve storm damage reduction for a greater number of buildings at a reduced cost compared to individual-building nonstructural protection plans for a given area. In addition to reducing damage to structures, road raising would reduce outside physical costs such as the flooding of cars, and non-physical costs such as clean up and evacuation. Raised roads would also offer enhancements to local evacuation plans and public safety by reducing the risk of inundation of local roads within the protected area, and providing safer evacuation routes out of the area. Road raising may also be more acceptable to residents in some communities since it reduces the need for alterations to individual buildings that may disrupt the owners' lives. Four locations have been identified for road raising, totaling 5.9 miles in length. The cost of the four planned road raising is estimated at \$30,098,600.

The optimization process examined crest elevations ranging from +5.25' to +7.5' (NGVD 29) for the various areas, and determined that road-raising is not cost effective for area 9b. The process identified +7' as the optimum road crest elevation for four remaining areas. This elevation would provide greater than a 100-year level of protection against still water flooding in the future condition. In each of the four areas, crest elevations lower than +7' would also result in positive net benefits and could be implemented as components of a federal project. Theoretically, there are additional benefits to be gained from a slightly higher crest elevation in some areas; however, +7' has been judged to be the highest acceptable elevation for all four sites, since higher elevations would cause problems with the roadway side slopes encroaching further onto adjacent properties, and would necessitate excessive gradients on many adjoining residential driveways.

The inclusion of substitute facilities costs in this Report are for planning and budgeting purposes only and does not constitute a preliminary or final determination of compensability by the agency regardless of whether the cost of substitute facilities are reflected in the feasibility study documents. If necessary, a final attorney's opinion of compensability will be obtained prior to execution of the Project Partnership Agreement.

Site	Town	Community	Length of Raised Road	Structures Protected
4a	Babylon	Amityville	6,600	97
8c	Babylon	Lindenhurst	5,300	240
8d 8e	Babylon	Lindenhurst	9,000	362
52a	Brookhaven	Mastic Beach	10,500	355

Further detail of these road raisings is included in Appendix A of this Report.

18. Hazardous, Toxic, and Radioactive Waste ("HTRW")

There are no known contaminants or HTRW concerns in, on, under or adjacent to the LER required for the Project.

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19. Project Support

Generally, impacted landowners on Fire Island support construction of the Project. Opposition to the Project comes from a minority of landowners whose privacy is impacted by public access to the Project required by Corps regulation.

20. Notification to Non-Federal Sponsor

By letter dated April 20, 2016, the non-Federal Sponsor, NYS DEC, has been notified in writing of the risks associated with acquiring land prior to the execution of the Project Partnership Agreement, and the Government's formal notice to proceed with acquisition. A copy of the letter, enclosures omitted, is attached hereto as Exhibit "F".

21. Other Issues

- a. Westhampton real estate – Prior to construction of the Westhampton project, the non-Federal Sponsor acquired the easements necessary to construct the project. The plan of improvement in this Project calls for reactive breach response in this reach. Due to the changed plan of improvement, the acquisition of approximately 157 additional easements will be required.
- b. Access Agreements - Required access to the public parcels will be acquired through an Access Agreement executed between the Sponsor and the relevant governing entity. These Access Agreements will incorporate the full body of text from the Perpetual Beach Storm Damage Reduction Easement. The Access Agreements will authorize sand placement over public lands, and where required, construction of groins.
- c. A number of parks exist within the Project area including Federal and State parks. Parks include: Robert Moses State Park, Fire Island National Seashore, Smith Point County Park, Cupsoque County Park, Shinnecock County Park, Napeague State Park, Hither Hills State Park, and Camp Hero State Park. The Corps and NFS regularly coordinated this plan with the National Park Service and stakeholders within the State of New York. The location of these parks will not impact construction of the Project.
- d. There are no known historical sites within and or adjacent to the LER required for the project.
- e. There are no known existing encumbrances (i.e. easements, rights-of-way, etc.) that would impact Project construction.

22. Point of Contacts

The points of contact for this rep is the Real Estate Project Delivery Team member Mr. Robert A. Vohden at (917)790-8093 (email: Robert.A.Vohden@usace.army.mil) or the undersigned at (917)790-8430 (email: Noreen.D.Dresser@usace.army.mil).

23. Recommendations

This REP has been prepared in accordance with Chapter 12, ER 405-1-12, Real Estate Handbook, 20 Nov 85, as amended. It is recommended that this report be approved.

NOREEN DEAN DRESSER
Chief, Real Estate Division
Real Estate Contracting Office

EXHIBIT “A”

REAL ESTATE MAPS

EXHIBIT “B”

REQUIRED LER

LER SUMMARY TABLE

		CONTRACT NUMBER			
		1	3	4	10-14 (Nonstructural)
Number of Parcels	Privately-Owned	0	241	136	TBD
	Publicly-Owned (Non-Fed)	3	23	21	TBD
	Federally-Owned	0	0	0	TBD
	Total Impacted Parcels	3	264	157	4,138
Fee	Fee Acquisitions	0	0	0	±0.49
Permanent Easements	Perpetual Beach Storm Damage Reduction Easement (or on public property, an Access Agreement)	±64.90	±341.8	±161.07	0
	Nonstructural Floodproofing Agreement	0	0	0	±215.95
	Total Project Acres	±64.90	±341.8	±161.07	±216.44
LERRD Costs	01 – Lands and Damages	\$40,320	\$10,025,711	\$5,055,030	\$33,527,334
	02 – Relocations				\$30,099,000
	Total LERRD Costs	\$40,320	\$10,025,711	\$5,055,030	\$63,626,334

EXHIBIT “C”
STANDARD ESTATES

FEE (Standard Estate No. 1)

The fee simple title to (the land described in Schedule A) (Tracts Nos. _____, _____ and _____), Subject, however, to existing easements for public roads and highways, public utilities, railroads and pipelines.

TEMPORARY WORK AREA EASEMENT (Standard Estate No. 15)

A temporary easement and right-of-way in, on, over and across (the land described in Schedule A) (Tracts Nos. _____, _____ and _____), for a period not to exceed _____, beginning with date possession of the land is granted to the United States, for use by the United States, its representatives, agents, and contractors as a (borrow area) (work area), including the right to (borrow and/or deposit fill, spoil and waste material thereon) (move, store and remove equipment and supplies, and erect and remove temporary structures on the land and to perform any other work necessary and incident to the construction of the _____ Project, together with the right to trim, cut, fell and remove therefrom all trees, underbrush, obstructions, and any other vegetation, structures, or obstacles within the limits of the right-of-way; reserving, however, to the landowners, their heirs and assigns, all such rights and privileges as may be used without interfering with or abridging the rights and easement hereby acquired; subject, however, to existing easements for public roads and highways, public utilities, railroads and pipelines.

PERPETUAL BEACH STORM DAMAGE REDUCTION EASEMENT (Standard Estate No. 26)

A perpetual and assignable easement and right-of-way in, on, over and across (the land described in Schedule A) (Tract No. __) for use by the (Project Sponsor), its representatives, agents, contractors, and assigns, to construct; preserve; patrol; operate; maintain; repair; rehabilitate; and replace; a public beach [a dune system] and other erosion control and storm damage reduction measures together with appurtenances thereto, including the right to deposit sand; to accomplish any alterations of contours on said land; to construct berms [and dunes]; to nourish and renourish periodically; to move, store and remove equipment and supplies; to erect and remove temporary structures; and to perform any other work necessary and incident to the construction, periodic renourishment and maintenance of the (Project Name), together with the right of public use and access; [to plant vegetation on said dunes and berms; to erect, maintain and remove silt screens and sand fences; to facilitate preservation of dunes and vegetation through the limitation of access to dune areas;] to trim, cut, fell, and remove from said land all trees, underbrush, debris, obstructions, and any other vegetation, structures and obstacles within the limits of the easement (except____); [reserving, however, to the grantor(s), (his) (her) (its) (their) (heirs), successors and assigns, the right to construct dune overwalk structures in accordance with any applicable Federal, State or local laws or regulations, provided that such structures shall not violate the integrity of the dune in shape, dimension or function, and that prior approval of the plans and specifications for such structures is obtained from the (designated representative of the Project Sponsor) and provided further that such structures are subordinate to the construction, operation, maintenance, repair, rehabilitation and replacement of the project; and further] reserving to the grantor(s), (his) (her) (its) (their) (heirs), successors and assigns all such rights and privileges as may be used and enjoyed without interfering with or abridging the rights and easements hereby acquired; subject however to existing easements for public roads and highways, public utilities, railroads and pipelines.

Nonstructural Floodproofing Agreement

TRACT NO. [TRACT] FIRE ISLAND INLET TO MONTAUK POINT HURRICANE SANDY GENERAL REFORMULATION REPORT

WHEREAS, pursuant to Public Law 96-367 (Title II, Section 202, of the Energy and Water Development Appropriation Act, 1981), as amended, and pursuant to the provisions of the Project Partnership Agreement (hereinafter referred to as the "PPA") dated [DATE] between the United States of America (hereinafter sometimes referred to as the "Government") and the New York Department of Environmental Conservation (hereinafter sometimes referred to as the "NYSDEC"), NYSDEC has undertaken the implementation of the Fire Island to Montauk Point Project (hereinafter sometimes referred to as the "Project");

WHEREAS, implementation of the Project includes, inter alia, the floodproofing of certain structures so that the habitable floors thereof are raised to levels or protected by other means in such a manner which will protect the structures from certain flooding to the greater extent practicable by allowing the free movement of floodwater beneath and around the structures;

WHEREAS, pursuant to the PPA, the has undertaken floodproofing and acquisitions of interests in land for and on behalf of the County;

WHEREAS, [PROPERTY OWNER]; (hereinafter sometimes referred to as the "Owner"), is the Owners of a certain parcel of land identified by the NYSDEC as Tract No. [TRACT], and being the same land as that described in a deed from [ACQUIRING TRANSACTION DESCRIPTION], which existing structure can and shall be floodproofed in compliance with this agreement and;

WHEREAS, it is the desire of the Owner to participate in and receive the benefits of the Project;

NOW, THEREFORE, THIS AGREEMENT AND GRANT made and entered into by and between [OWNER]; and the NYSDEC, as aforesaid;

WITNESSETH, that for and in consideration of the premises and the mutual agreements and covenants hereinafter set forth;

1. The NYSDEC, in conjunction with the Government, hereby agrees floodproof the subject structure through elevation of the structure. The Owner shall permit entry upon the property by an authorized Government contractor, and permit said contractor to modify the structure consistent with contractor design to be developed. The Owner shall further permit an inspection or inspections of the floodproofing work by the NYSDEC, its contractors, assigns or representatives upon completion of the work, and/or at any time during the work's progress, to ensure that the work is acceptable to the NYSDEC and has been satisfactorily performed to meet the Project's criteria as to design, construction, and protection. Provided, further, that the floodproofed structure shall not be located within the regulatory floodway. Provided, further, that, should the Owner

incur any cost in excess of said amount, that cost shall be borne by the Owner unless such additional amount is expressly approved in writing by the Government as necessary for the purposes of flood damage reduction.

3. The Owner hereby agrees that the Owner shall not convey to any third party any interest in and to said land and the structures or create any liens thereon prior to completion of said floodproofing work and recordation of this Agreement by the Government in the land records of Suffolk County, New York, without the prior written approval of the Government.

4. The Owner hereby acknowledges that the Government has made no warranties or guarantees whatsoever in connection with the Contractor or with the Contractor's ability to satisfactorily perform the work; and, that, as between the Government and the Owner, the Owner is solely responsible to arrange for the Contractor's satisfactory completion of the work in accordance herewith.

5. Further, that for and in the consideration aforesaid, the receipt and sufficiency of which are hereby acknowledged, the Owner, for herself and her heirs and assigns, do hereby GRANT, unto the NYSDEC, and its assigns, the perpetual right, power, and privilege of access to said land and any structures thereon at all reasonable times considered necessary by the NYSDEC, its contractors, assigns or representatives to ensure that this Agreement, its covenants and restrictions, and the intents and purposes of the project are being complied with by the Owner, for herself and her heirs and assigns.

6. The Owner, for herself and her heirs and assigns, hereby covenant and warrant to the NYSDEC, and to its assigns forever, and agree, that no construction, alteration, or placement of structures of any kind or nature whatsoever on said land shall take place unless the lowest floor thereof to be used for human habitation, commercial or business purposes is elevated above [DETERMINED ELEVATION] feet mean sea level, and this restriction also prohibits the placement of water damageable material of any kind below the stated elevation of [DETERMINED ELEVATION] mean sea level, and any use of materials below this elevation must meet the requirement of "Flood Resistant Material" as defined in the Federal Emergency Management Agency's (FEMA) FIA-TB-2(4/93)(Technical Bulletin 2-93) this restriction and requirement shall be specifically included in every instrument subsequent hereto conveying title to any interest in said land or structures thereon.

7. The Owner, for herself and her heirs and assigns, hereby covenant, warrant, and agree she will forever hold and save harmless and blameless the Government and the NYSDEC, and its assigns, from any damages or injuries resulting either directly or indirectly from any floodproofing work and any flooding of said land or of the floodproofed structure.

8. The Owner, for herself and her heirs and assigns, recognize and agree that the grant hereby made to the NYSDEC, and the covenants and restrictions herein, in connection with the Project, are necessary and appropriate to ensure the purposes of said Project, namely, as authorized by Section 202 of the Water Resources and Development Act of 1981, Public Law 96-367, as amended, to afford a level of protection against flooding at least sufficient to prevent any future losses from the likelihood of flooding as [LEVEL OF PROTECTION], whichever is greater; and,

that for those purposes the NYSDEC, and its assigns, shall forever have the right unchallenged by the Owner, and by the Owner's heirs and assigns, to seek legal enforcement of all of the provisions contained herein, it being the intentions of the parties that said provisions shall attach to and run with the land forever.

9. It is further provided that the obligations of the Government herein are contingent upon the Owner obtaining, as may be acceptable to the Government, the consent of any lienholder or tenants to the terms of this Agreement and obtaining from any lienholder or tenants waivers, releases, and/or subordinations of her rights in the premises to the extent necessary to accomplish the work and covenants and restrictions herein, as may be required by the Government.

IN WITNESS WHEREOF, the parties have executed this Agreement and Deed effective as of the date of acceptance hereof by the New York Department of Environmental Conservation.

[OWNER NAME] Owner

[OWNER NAME], Owner

ACKNOWLEDGEMENT

STATE OF _____

COUNTY OF _____

The foregoing instrument was acknowledged before me this ____ day of _____, 2015, by [OWNER NAME] and [OWNER NAME].

NOTARY PUBLIC

My Commission Expires:

ACCEPTED:

NEW YORK DEPARTMENT OF ENVIRONMENTAL CONSERVATION

By: _____
[TITLE]

DATE

ACKNOWLEDGEMENT

STATE OF NEW YORK

COUNTY OF SUFFOLK

On this ____ day of _____, [YEAR], the undersigned officer, personally appeared _____, [TITLE], New York Department of Environmental Conservation, known to me to be the person described in the foregoing Agreement and Deed, and acknowledged that he executed the same in the capacity therein stated and for the purposes therein contained.

IN WITNESS WHEREOF, I hereunto set my hand and official seal.

(Seal)

NOTARY PUBLIC

My Commission Expires:

THIS INSTRUMENT WAS PREPARED BY:

[NAME], Attorney
[ADDRESS 1]
[ADDRESS 2]

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EXHIBIT “D”

BASELINE COST ESTIMATE FOR REAL ESTATE

BASELINE COST ESTIMATE FOR REAL ESTATE SUMMARY		
	TOTAL PROJECT REAL ESTATE COSTS	Cost
	Contract 1 - Inlet Dredging: Fire Island	
	Lands and Damages, Less Land Payments	\$33,600
	20% Contingency	\$6,720
	Subtotal	\$40,320
	Land Payments	\$0
01	LANDS AND DAMAGES	\$40,320
	Relocations	\$0
02	RELOCATIONS	\$0
	Project Management	\$2,625
	20% Contingency	\$525
30	PROJECT MANAGEMENT	\$3,150
	CONTRACT 1 TOTAL	\$43,470
	Contract 3 - Tiana Beach, Downtown Montauk, Potato Road Beachfill	
	Lands and Damages, Less Land Payments	\$4,576,172
	20% Contingency	\$915,234
	Subtotal	\$5,491,407
	Land Payments	\$4,534,304
01	LANDS AND DAMAGES	\$10,025,711
	Relocations	\$0
02	RELOCATIONS	\$0
	Project Management	\$600,600
	20% Contingency	\$120,120
30	PROJECT MANAGEMENT	\$720,720
	CONTRACT 3 TOTAL	\$10,746,431
	Contract 4 - Smith's Point to West Hampton Beachfill	
	Lands and Damages, Less Land Payments	\$2,993,417
	20% Contingency	\$598,683
	Subtotal	\$3,592,101
	Land Payments	\$1,462,929
01	LANDS AND DAMAGES	\$5,055,030
	Relocations	\$0
02	RELOCATIONS	\$0
	Project Management	\$376,800
	20% Contingency	\$75,360
30	PROJECT MANAGEMENT	\$452,160
	CONTRACT 4 TOTAL	\$5,507,190

BASELINE COST ESTIMATE FOR REAL ESTATE SUMMARY		
	TOTAL PROJECT REAL ESTATE COSTS	Cost
	Contract 8-13 - Nonstructural	
	Lands and Damages, Less Land Payments	\$25,760,204
	20% Contingency	\$5,152,041
	Subtotal	\$30,912,244
	Land Payments	\$2,615,090
01	LANDS AND DAMAGES	\$33,527,334
	Relocations	\$23,396,000
	28.7% Contingency	\$6,703,000
02	RELOCATIONS	\$30,099,000
	Project Management	\$1,812,444
	20% Contingency	\$362,489
30	PROJECT MANAGEMENT	\$2,174,933
	CONTRACT 8-13 TOTAL	\$65,801,267

CONTRACT 1 - INLET DREDGING: FIRE ISLAND				
	TOTAL PROJECT REAL ESTATE COSTS	Non-Federal	Federal	Total Cost
	Cost Summary:			
	Incidental Costs (01A)	\$33,600		
	Real Estate Acquisition Costs (01B)	\$0		
	Subtotal:	\$33,600		
	20% Contingency, Less Land Payments (01B1)	\$6,720		
01	LANDS AND DAMAGES	\$40,320	\$0	\$40,320
02	RELOCATIONS	\$0	\$0	\$0
	Project Management Costs		\$2,625	
	20% Contingency		\$525	
30	PROJECT MANAGEMENT		\$3,150	\$3,150
	Cost Breakdown:			
01A	INCIDENTAL COSTS	\$33,600	\$2,625	\$36,225
01A1	Acquisition (Admin Costs)	\$15,000	\$1,500	\$16,500
01A1A	By Government (Gov't)			
01A1B	By Non-Federal Sponsor (NFS)	\$15,000		
01A1C	By Gov't on behalf of NFS		\$1,500	
01A2	Survey	\$0	\$0	\$0
01A3	Appraisal	\$0	\$0	\$0
01A4	Title Services	\$15,000	\$375	\$15,375
01A4A	By Gov't (Contract)			
01A4B	By NFS	\$15,000		
01A4C	By Gov't on behalf of NFS			
01A4D	Review of NFS		\$375	
01A5	Other Professional Services	\$3,600	\$375	\$3,975
01A5A	By the Gov't			
01A5B	By the NFS	\$3,600		
01A5C	By Gov't on behalf of NFS			
01A5D	Review of NFS		\$375	
01A6	Closing Cost (4% of Land Payments-01C1)	\$0	\$0	\$0
01A7	PL 91-646 Assistance	\$0	\$0	\$0
01A8	Audit	\$0	\$750	\$750
01A8A	By Gov't		\$750	
01A9B	By NFS			

CONTRACT 1 - INLET DREDGING: FIRE ISLAND				
	TOTAL PROJECT REAL ESTATE COSTS	Non-Federal	Federal	Total Cost
01B	REAL ESTATE ACQUISITION COSTS	\$0	\$0	\$0
01B1	Land Payments	\$0	\$0	\$0
01B2	Damage Payments	\$0	\$0	\$0
01B3	PL 91-646 Payment	\$0	\$0	\$0
01B4	Condemnation	\$0	\$0	\$0
01B5	Facility / Utility Relocations	\$0	\$0	\$0
01B6	Disposals	\$0	\$0	\$0
02A	RELOCATION COSTS	\$0	\$0	\$0
02A1	Relocation Costs	\$0	\$0	\$0

CONTRACT 3 - TIANA BEACH, DOWNTOWN MONTAUK, POTATO ROAD BEACHFILL				
	TOTAL PROJECT REAL ESTATE COSTS	Non-Federal	Federal	Total Cost
	Cost Summary:			
	Incidental Costs (01A)	\$4,326,172		
	Real Estate Acquisition Costs (01B)	\$4,784,304		
	Subtotal:	\$9,110,476		
	20% Contingency, Less Land Payments (01B1)	\$915,234		
01	LANDS AND DAMAGES	\$10,025,711	\$0	\$10,025,711
02	RELOCATIONS	\$0	\$0	\$0
	Project Management Costs (30)		\$600,600	
	20% Contingency		\$120,120	
30	PROJECT MANAGEMENT	\$0	\$720,720	\$720,720
	Cost Breakdown:			
01A	INCIDENTAL COSTS	\$4,326,172	\$600,600	\$4,926,772
01A1	Acquisition (Admin Costs)	\$1,320,000	\$132,000	\$1,452,000
01A1A	By Government (Gov't)			
01A1B	By Non-Federal Sponsor (NFS)	\$1,320,000		
01A1C	By Gov't on behalf of NFS		\$132,000	
01A2	Survey	\$132,000	\$33,000	\$165,000
01A2A	By Gov't (In-house)			
01A2B	By Gov't (Contract)			
01A2C	By NFS	\$132,000		
01A2D	By Gov't on behalf of NFS			
01A2E	Review of NFS		\$33,000	
01A3	Appraisal	\$1,056,000	\$369,600	\$1,425,600
01A3A	By Gov't (In-house)			
01A3B	By Gov't (Contract)			
01A3C	By NFS	\$1,056,000		
01A3D	By Gov't on behalf of NFS			
01A3E	Review of NFS		\$369,600	
01A4	Title Services	\$1,320,000	\$33,000	\$1,353,000
01A4A	By Gov't (Contract)			
01A4B	By NFS	\$1,320,000		
01A4C	By Gov't on behalf of NFS			
01A4D	Review of NFS		\$33,000	
01A5	Other Professional Services	\$316,800	\$33,000	\$349,800
01A5A	By the Gov't			
01A5B	By the NFS	\$316,800		
01A5C	By Gov't on behalf of NFS			
01A5D	Review of NFS		\$33,000	

CONTRACT 3 - TIANA BEACH, DOWNTOWN MONTAUK, POTATO ROAD BEACHFILL				
	TOTAL PROJECT REAL ESTATE COSTS	Non-Federal	Federal	Total Cost
01A6	Closing Cost (4% of Land Payments-01C1)	\$181,372	\$0	\$181,372
01A6A	By Gov't			
01A6B	By NFS	\$181,372		
01A6C	By Gov't on behalf of NFS			
01A7	PL 91-646 Assistance	\$0	\$0	\$0
01A8	Audit	\$0	\$33,000	\$33,000
01A8A	By Gov't		\$33,000	
01A9B	By NFS			
01B	REAL ESTATE ACQUISITION COSTS	\$4,784,304	\$0	\$4,784,304
01B1	Land Payments	\$4,534,304	\$0	\$4,534,304
01B1A	By Government			
01B1B	By NFS	\$4,534,304		
01B1C	By Gov't on behalf of NFS			
01B2	Damage Payments	\$0	\$0	\$0
01B3	PL 91-646 Payment	\$0	\$0	\$0
01B4	Condemnation	\$250,000	\$0	\$250,000
01B4A	By NFS	\$250,000		
01B5	Facility / Utility Relocations	\$0	\$0	\$0
01B5A	By NFS			
01B6	Disposals	\$0	\$0	\$0
02A	RELOCATION COSTS	\$0	\$0	\$0
02A1	Relocation Costs	\$0	\$0	\$0

CONTRACT 4 - SMITH'S POINT TO WESTHAMPTON BEACHFILL				
	TOTAL PROJECT REAL ESTATE COSTS	Non-Federal	Federal	Total Cost
	Cost Summary:			
	Incidental Costs (01A)	\$2,523,417		
	Real Estate Acquisition Costs (01B)	\$1,932,929		
	Subtotal:	\$4,456,346		
	20% Contingency, Less Land Payments (01B1)	\$598,683		
01	LANDS AND DAMAGES	\$5,055,030	\$0	\$5,055,030
02	RELOCATIONS	\$0	\$0	\$0
	Project Management Costs (30)		\$376,800	
	20% Contingency		\$75,360	
30	PROJECT MANAGEMENT	\$0	\$452,160	\$452,160
	Cost Breakdown:			
01A	INCIDENTAL COSTS	\$2,523,417	\$376,800	\$2,900,217
01A1	Acquisition (Admin Costs)	\$785,000	\$78,500	\$863,500
01A1A	By Government (Gov't)			
01A1B	By Non-Federal Sponsor (NFS)	\$785,000		
01A1C	By Gov't on behalf of NFS		\$78,500	
01A2	Survey	\$78,500	\$19,625	\$98,125
01A2A	By Gov't (In-house)			
01A2B	By Gov't (Contract)			
01A2C	By NFS	\$78,500		
01A2D	By Gov't on behalf of NFS			
01A2E	Review of NFS		\$19,625	
01A3	Appraisal	\$628,000	\$219,800	\$847,800
01A3A	By Gov't (In-house)			
01A3B	By Gov't (Contract)			
01A3C	By NFS	\$628,000		
01A3D	By Gov't on behalf of NFS			
01A3E	Review of NFS		\$219,800	
01A4	Title Services	\$785,000	\$19,625	\$804,625
01A4A	By Gov't (Contract)			
01A4B	By NFS	\$785,000		
01A4C	By Gov't on behalf of NFS			
01A4D	Review of NFS		\$19,625	
01A5	Other Professional Services	\$188,400	\$19,625	\$208,025
01A5A	By the Gov't			
01A5B	By the NFS	\$188,400		
01A5C	By Gov't on behalf of NFS			
01A5D	Review of NFS		\$19,625	

CONTRACT 4 - SMITH'S POINT TO WESTHAMPTON BEACHFILL				
	TOTAL PROJECT REAL ESTATE COSTS	Non-Federal	Federal	Total Cost
01A6	Closing Cost (4% of Land Payments-01C1)	\$58,517	\$0	\$58,517
01A6A	By Gov't			
01A6B	By NFS	\$58,517		
01A6C	By Gov't on behalf of NFS			
01A7	PL 91-646 Assistance	\$0	\$0	\$0
01A8	Audit	\$0	\$39,250	\$39,250
01A8A	By Gov't		\$39,250	
01A9B	By NFS			
01B	REAL ESTATE ACQUISITION COSTS	\$1,932,929	\$0	\$1,932,929
01B1	Land Payments	\$1,462,929	\$0	\$1,462,929
01B1A	By Government			
01B1B	By NFS	\$1,462,929		
01B1C	By Gov't on behalf of NFS			
01B2	Damage Payments	\$200,000	\$0	\$200,000
01B2A	By Government			
01C2B	By NFS	\$200,000		
01C2C	By Gov't on behalf of NFS			
01B3	PL 91-646 Payment	\$20,000	\$0	\$20,000
01B3A	By Government			
01B3B	By NFS	\$20,000		
01B3C	By Gov't on behalf of NFS			
01B4	Condemnation	\$250,000	\$0	\$250,000
01B4A	By NFS	\$250,000		
02A	RELOCATION COSTS	\$0	\$0	\$0
02A1	Relocation Costs	\$0	\$0	\$0

CONTRACTS 8 THROUGH 13 - NONSTRUCTURAL				
	TOTAL PROJECT REAL ESTATE COSTS	Non-Federal	Federal	Project Cost
	Cost Summary:			
	Incidental Costs (01A)	\$25,760,204		
	Real Estate Acquisition Costs (01B)	\$2,615,090		
	Subtotal:	\$28,375,294		
	20% Contingency, Less Land Payments (01B1)	\$5,152,041		
01	LANDS AND DAMAGES	\$33,527,334	\$0	\$33,527,334
	Relocations		\$23,396,000	
	28.7% Contingency		\$6,703,000	
02	RELOCATIONS	\$0	\$30,099,000	\$30,099,000
	Project Management Costs		\$1,812,444	
	20% Contingency		\$362,489	
30	PROJECT MANAGEMENT	\$0	\$2,174,933	\$2,174,933
	Cost Breakdown:			
01A	INCIDENTAL COSTS	\$25,760,204	\$1,812,444	\$27,572,648
01A1	Acquisition (Admin Costs)	\$12,414,000	\$1,034,500	\$13,448,500
01A1A	By Government (Gov't)			
01A1B	By Non-Federal Sponsor (NFS)	\$12,414,000		
01A1C	By Gov't on behalf of NFS		\$1,034,500	
01A2	Survey	\$0	\$0	\$0
01A3	Appraisal	\$0	\$0	\$0
01A4	Title Services	\$8,276,000	\$260,694	\$8,536,694
01A4A	By Gov't (Contract)			
01A4B	By NFS	\$8,276,000		
01A4C	By Gov't on behalf of NFS			
01A4D	Review of NFS		\$260,694	
01A5	Other Professional Services	\$4,965,600	\$260,694	\$5,226,294
01A5A	By the Gov't			
01A5B	By the NFS	\$4,965,600		
01A5C	By Gov't on behalf of NFS			
01A5D	Review of NFS		\$260,694	
01A6	Closing Cost (4% of Land Payments-01C1)	\$104,604	\$0	\$104,604
01A6A	By Gov't			
01A6B	By NFS	\$104,604		
01A6C	By Gov't on behalf of NFS			
01A7	PL 91-646 Assistance	\$0	\$0	\$0

CONTRACTS 8 THROUGH 13 - NONSTRUCTURAL				
	TOTAL PROJECT REAL ESTATE COSTS	Non-Federal	Federal	Project Cost
01A8	Audit	\$0	\$517,250	\$517,250
01A8A	By Gov't		\$517,250	
01A9B	By NFS			
01B	REAL ESTATE ACQUISITION COSTS	\$2,615,090	\$0	\$2,615,090
01B1	Land Payments	\$2,295,090	\$0	\$2,295,090
01B1A	By Government			
01B1B	By NFS	\$2,295,090		
01B1C	By Gov't on behalf of NFS			
01B2	Damage Payments	\$0	\$0	\$0
01B3	PL 91-646 Payment	\$320,000	\$0	\$320,000
01B4	Condemnation	\$0	\$0	\$0
02A	RELOCATION COSTS	\$0	\$23,396,000	\$23,396,000
02A1	Relocation Costs	\$0	\$23,396,000	\$23,396,000
02A1A	By Government		\$23,396,000	
02A1B	By NFS			

EXHIBIT “E”

NON-FEDERAL SPONSOR CAPABILITY ASSESSMENT CHECKLIST

**ASSESSMENT OF NON-FEDERAL SPONSOR'S
REAL ESTATE ACQUISITION CAPABILITY**

**FIRE ISLAND INLET TO MONTAUK POINT
GENERAL REFORMULATION REPORT**

I. Legal Authority.

- a. Does the sponsor have legal authority to acquire and hold title to real property for project purposes? Yes, through local sponsor
- b. Does the sponsor have the power of eminent domain for this project? Yes
- c. Does the sponsor have “quick-take” authority for this project? Yes
- d. Are any of the lands/interests in land required for the project located outside the sponsor's political boundary? No
- e. Are any of the lands/interests in land required for the project owned by an entity whose property the sponsor cannot condemn? No

II. Human Resource Requirements.

- a. Will the sponsor's in-house staff require training to become familiar with the real estate requirements of Federal projects including P.L. 91-646, as amended? No
- b. If the answer to II.a is “yes,” has a reasonable plan been developed to provide such training?
- c. Does the sponsor's in-house staff have sufficient real estate acquisition experience to meet its responsibilities for the project? Yes
- d. Is the sponsor's projected in-house staffing level sufficient considering its other workload, if any, and the project schedule? Yes
- e. Can the sponsor obtain contractor support, if required in a timely fashion? Yes
- f. Will the sponsor likely request USACE assistance in acquiring real estate? No

III. Other Project Variables.

- a. Will the sponsor's staff be located within reasonable proximity to the project site? Yes, local sponsor offices located in Hauppauge, NY.
- b. Has the sponsor approved the project/real estate schedule/milestones? Yes

IV. Overall Assessment.

- a. Has the sponsor performed satisfactorily on other USACE projects? Yes
- b. With regard to this project, the sponsor is anticipated to be: highly capable/fully capable/moderately capable/marginally capable/insufficiently capable. If sponsor is believed to be “insufficiently capable,” provide explanation. Highly capable

V. Coordination.

- a. Has this assessment been coordinated with the sponsor? Yes
- b. Does the sponsor concur with this assessment? Yes

Concur:

Susan D. McCormick, P.E.
Chief, Coastal Erosion Management Program
New York State Department of Environmental Conservation

Reviewed and approved by:

Noreen Dean Dresser
Chief of Real Estate Division
Real Estate Contracting Officer
New York District Corps of Engineers

EXHIBIT “F”

NOTIFICATION TO NON-FEDERAL SPONSOR

DRAFT



DEPARTMENT OF THE ARMY
US ARMY CORPS OF ENGINEERS, NEW YORK DISTRICT
JACOB K JAVITS FEDERAL BUILDING
26 FEDERAL PLAZA
NEW YORK, NY 10278

April 20, 2016

Sue McCormick
New York State Department of Environmental Conservation
Chief, Coastal Erosion Management Program
625 Broadway, 4th Floor
Albany, NY 12233-3504

Dear Ms. McCormick:

This letter is in reference to the Fire Island Inlet to Montauk Point Hurricane Sandy General Reformulation Report (hereinafter, the "Project"). Enclosed are maps (Enclosure-1) showing the Project area and the locations of the required real estate interests to be obtained by the New York State of Department of Environmental Conservation (the "State") as the non-Federal Sponsor for the Project. Enclosure-2 identifies the parcels, and the real estate interests and size required therein. Be advised, the enclosed is a feasibility level analysis, and the underlying real estate data is subject to change.

Together, the maps depict all the necessary Lands, Easements, and Rights-of-Way ("LER") the Federal Government has determined the State must provide to support the construction, operation and maintenance of the Project. The minimum required real estate interest to be obtained are Perpetual Beach Storm Damage Reduction Easements, Temporary Work Area Easements, Fee acquisitions, and Non-Structural Floodproofing Agreements. Enclosure-3 contains the standard language for the aforementioned estates, and a draft template of the Non-Structural Floodproofing Agreement. This agreement as well as the non-structural implementation plan will be refined during the plans and specs phase. The standard estates are required to be incorporated, as written, into the body of their respective agreements when acquiring the LER for the Project.

The Project will be implemented in thirteen contracts as follows:

- Contract 1 – Inlet Dredging: Fire Island
- Contract 2 – Inlet Dredging: Moriches, Shinnecock
- Contract 3 – Tiana Beach, Downtown Montauk, Potato Road Beachfill
- Contract 4 – Smith's Point/Westhampton Beachfill
- Contract 5 – Fire Island at Developed Locations (communities)
- Contract 6 – Ocean Beach
- Contract 7 – Westhampton

Mainland Nonstructural

- Contract 8 – Road Raising

Contract 9 – Year 1 Non-Structural Inventory
Contract 10 – Year 2 Non-Structural Inventory
Contract 11 – Year 3 Non-Structural Inventory
Contract 12 – Year 4 Non-Structural Inventory
Contract 13 – Year 5 Non-Structural Inventory

The priority of LER acquisition should correspond with the Project contracts.

Prior to the Government's issuance of advertisements for bids for Project construction, as the non-Federal Sponsor, it will be the State's responsibility to obtain all the necessary LER for this Project and to assume full and sole responsibility for any and all costs, responsibility, or liability arising out of the acquisition effort.

It is, however, strongly recommended that the State *not* acquire any real estate interests for the Project *before* the Project Partnership Agreement (the "PPA") between the Government and the State is signed *and* you have received from the New York District U.S. Army Corps of Engineers (the "District") the formal Notice to Proceed with LER acquisition. Furthermore, as we are required to do under the provisions of Paragraph 12-31 of Chapter 12 of Corps of Engineers regulation ER 405-1-12, by this letter the District is formally advising the State of the risks associated with acquiring the LER prior to the signing of the PPA. These risks include, but may not be limited to, the following:

- a. Congress may not appropriate funds to construct the proposed project;
- b. the proposed project may otherwise not be funded or approved for construction;
- c. a PPA mutually agreeable to the non-Federal sponsor and the Government may not be executed and implemented;
- d. the non-Federal sponsor may incur liability and expense by virtue of its ownership of contaminated lands, or interests, whether such liability should arise out of local, state, or Federal laws or regulations, including liability arising out of CERCLA;
- e. the non-Federal sponsor may acquire interests or estates that are later determined by the Government to be inappropriate, insufficient, or otherwise not required for the project;
- f. the non-Federal sponsor may initially acquire insufficient or excessive real property acreage which may result in additional negotiations and/or benefit payments under Public Law 91-646 as well as the payment of additional fair market value to the affected landowners which could have been avoided by delaying acquisition until after PPA execution and the Government's notice to commence acquisition;
- g. the non-Federal sponsor may incur costs or expenses in connection with its decision to acquire in advance of the executed PPA and the Government's notice to proceed which may not be creditable under the provisions of Public Law 99-662 or the PPA.

Although the probability of any of the aforementioned events occurring is low, the District is required to notify the non-Federal sponsor, in writing, of such possibilities. The District will provide the State with the formal Notice to Proceed with the acquisition of the required LER shortly after the PPA has been fully executed.

A copy of this letter, with enclosures, has been provided to Mr. Daniel Falt, U.S. Army Corps of Engineers Project Manager, for his informational awareness.

Please feel free to contact me at (917) 790-8430 (email: Noreen.D.Dresser@usace.army.mil) if you have any questions concerning the foregoing. Mr. Robert A. Vohden, the Project Realty Specialist, may be reached at 917-790-8093 (email: Robert.A.Vohden@usace.army.mil). Mr. Vohden and I look forward to working with you and your staff in bringing this Project to fruition.

Sincerely,

A handwritten signature in black ink, appearing to read "Noreen Dean Dresser". The signature is fluid and cursive, with a large initial "N" and "D".

Noreen Dean Dresser
New York District Chief of Real Estate Division
Real Estate Contracting Officer



TITLE: DRAFT Fire Island Inlet to Montauk Point, NY Reformulation Study	Designed by: RWI		Checked by:
	Drawn by: RWI		Reviewed by:
	Date: Nov. 18, 2015		Submitted by:
	Proj. Status: P/S NOTED		Comm. No.: XXXXX
	Drawing No.: RE-00		Cover Sheet




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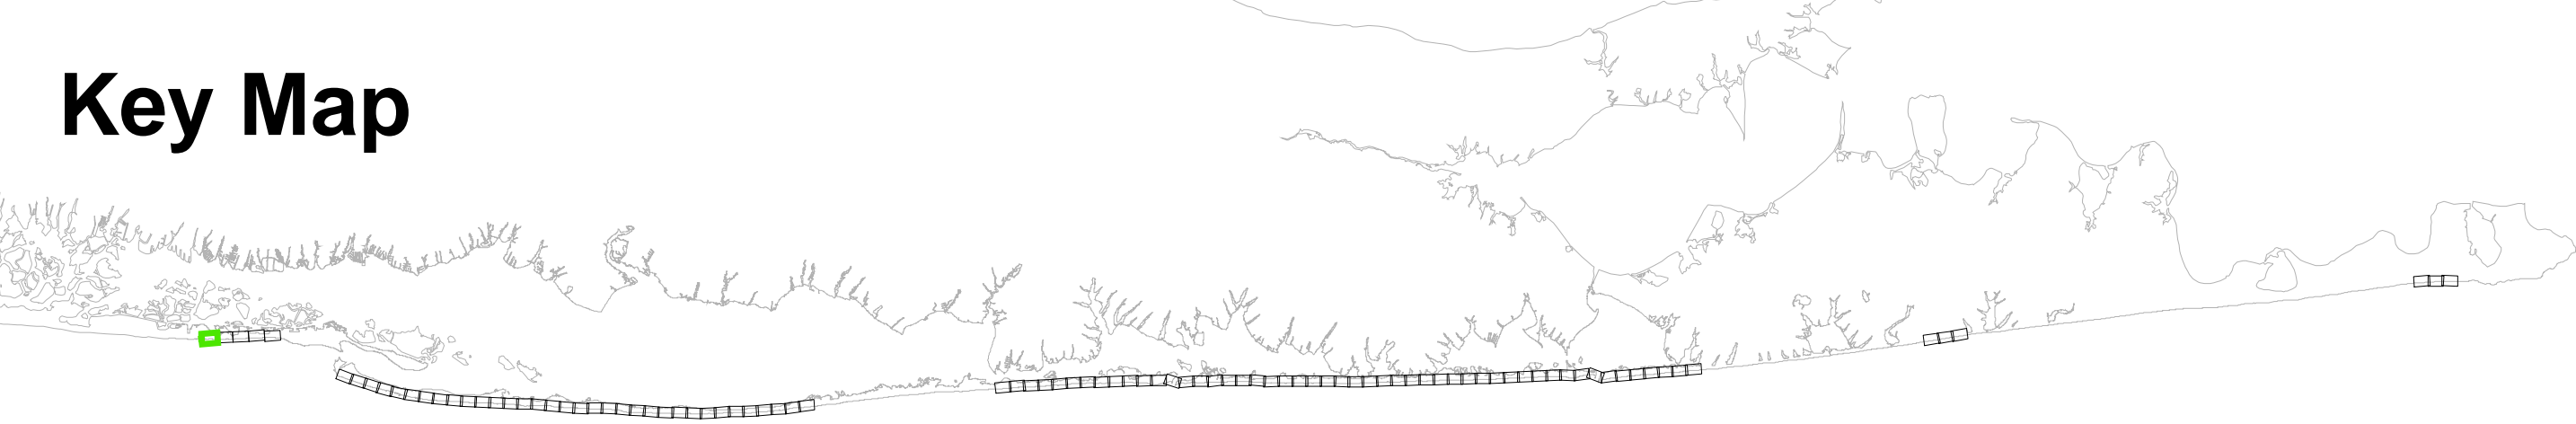
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Block - Lot
2. GRR Parcel Number: **11**
3. FIMI Parcel Number: **11**
4. Montauk Parcel Number: **11**
5. Westhampton Parcel Number: **11**

Legend:

- CEHA
MIDU_Baseline_20151022
Parcels
Easement Area
Impacted Parcels
- GRR Plan Features
Landward Toe of Dune
Seaward Toe of Dune
Seaward Berm Crest
Design MHW (2 ft NGVD)
Dune - 1st Construction
Berm - 1st Construction

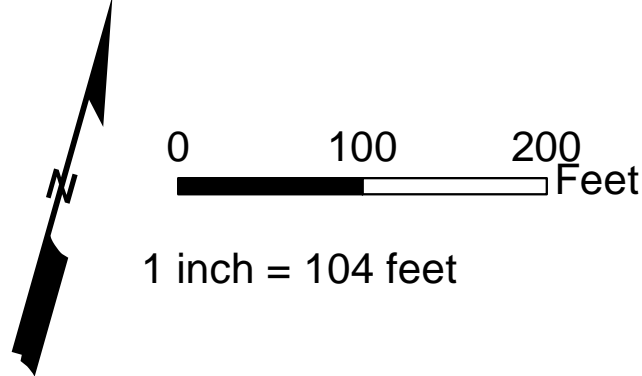

Key Map



DRAFT				TITLE: Fire Island Inlet to Montauk Point, NY Reformulation Study			
DRAWING NO. RE-1				SHEET 1 OF 95			
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Drawn by:		Reviewed by:		No.		Date	
Date:		Submitted by:		No.		Date	
Proj. Scale:		Comm. No.:		No.		Date	
AS NOTED		XXXXX		No.		Date	




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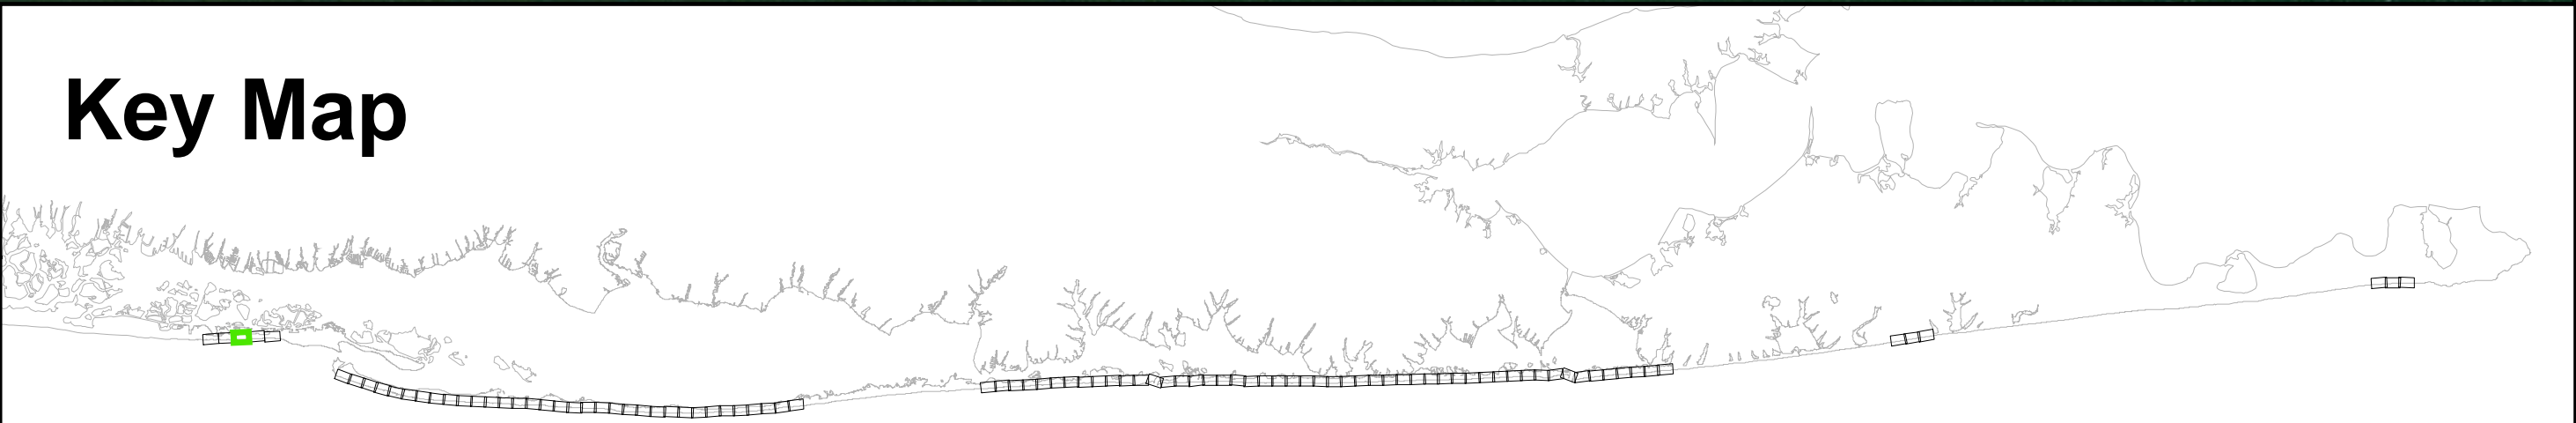
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Key Map



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Reference Files:		Designed by:		Checked by:	
		Drawn by:		Reviewed by:	
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AS NOTED		XXXXX		XXXXX	
SHEET 3 OF 95		No.		Date	

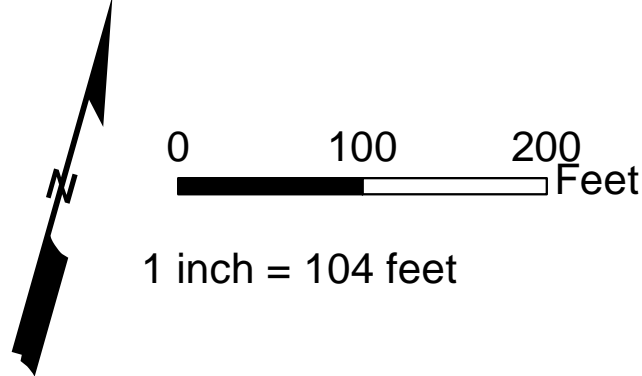


Notes:

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Key Map



DRAFT		TITLE:		Fire Island Inlet to Montauk Point, NY Reformulation Study	
Reference Files:		Designed by:		RW H	
Checked by:		Drawn by:		RW H	
Reviewed by:		Date:		Nov. 18, 2015	
Submitted by:		Proj. Scale:		AS NOTED	
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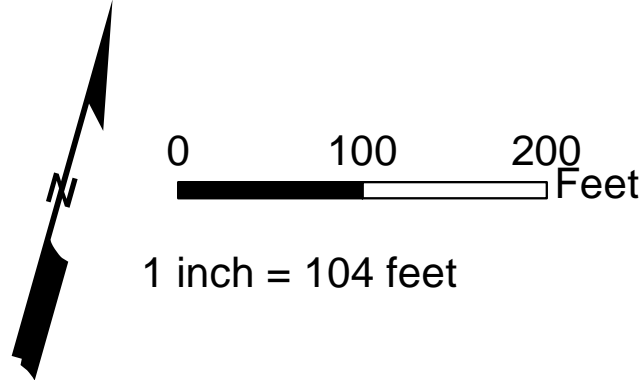

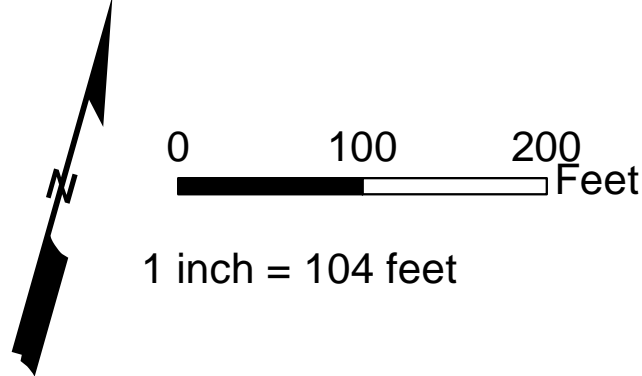
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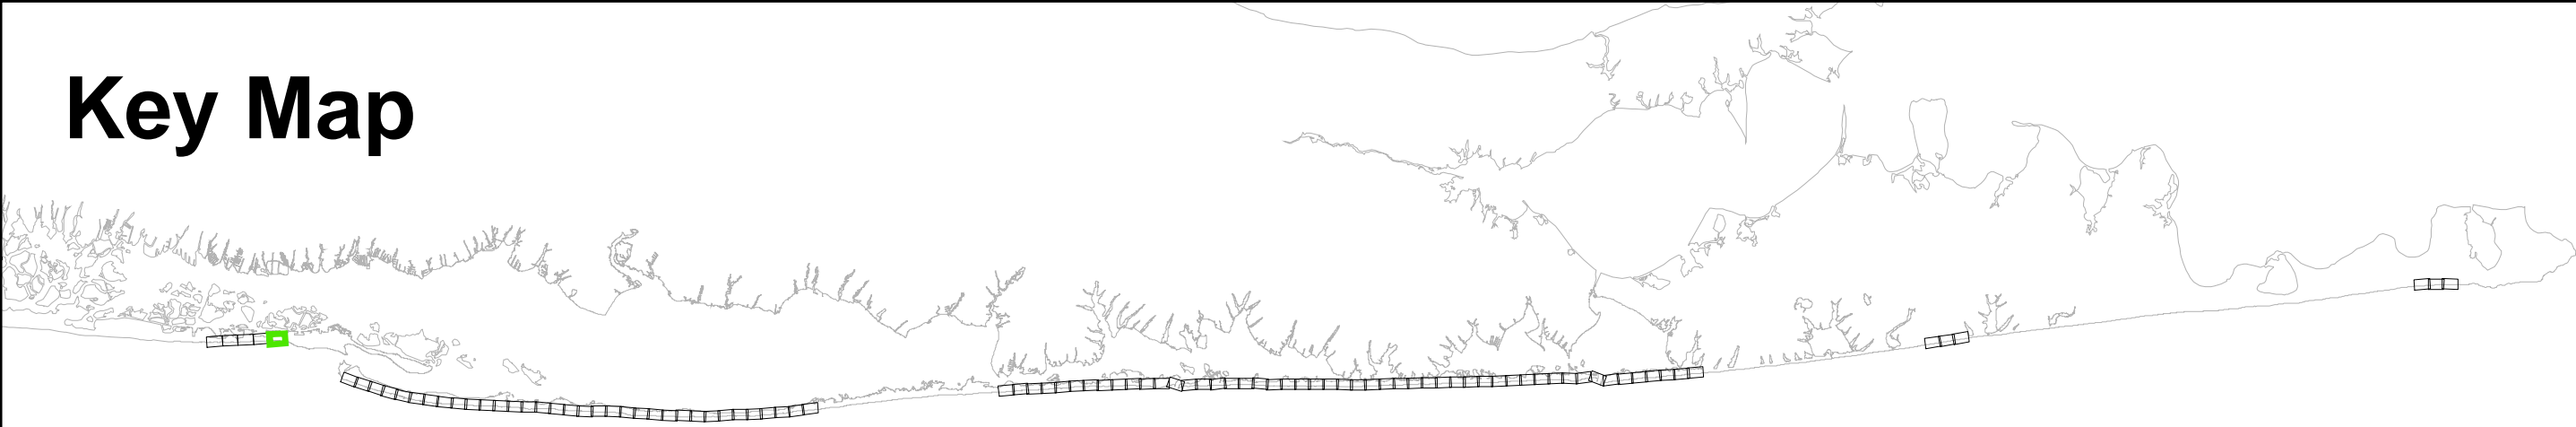
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Key Map



<div>RE-5</div> <div>SHEET 5 OF 95</div>		DRAWING NO.	TITLE: <div>DRAFT</div> <div>Fire IslandInlet to Montauk Point, NY Reformulation Study</div>		Reference Files:									
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					Drawn by:	RWH	Reviewed by:							
					Date:	Nov 18, 2015	Submitted by:							
					Plot Scale:	AS NOTED	Comm. No.:							
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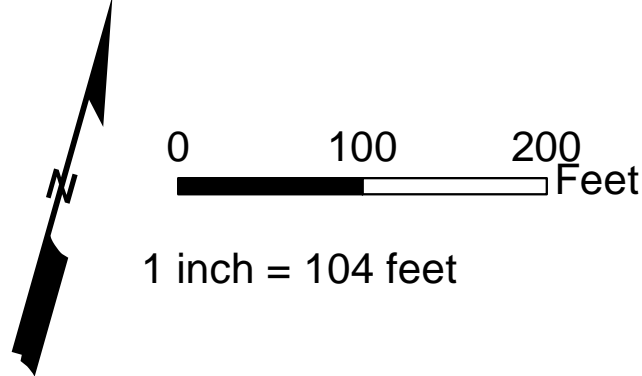


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DRAFT		Reference Files:		Checked by:		Reviewed by:		Submitted by:		Comm.		No. :		XXXXX	
Designed by:		RW H		Drawn by:		RW H		Date:		Nov 18, 2015		Plot Scale:		AS NOTED	
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DRAWING NO.		RE-6													
SHEET 6 OF 95															




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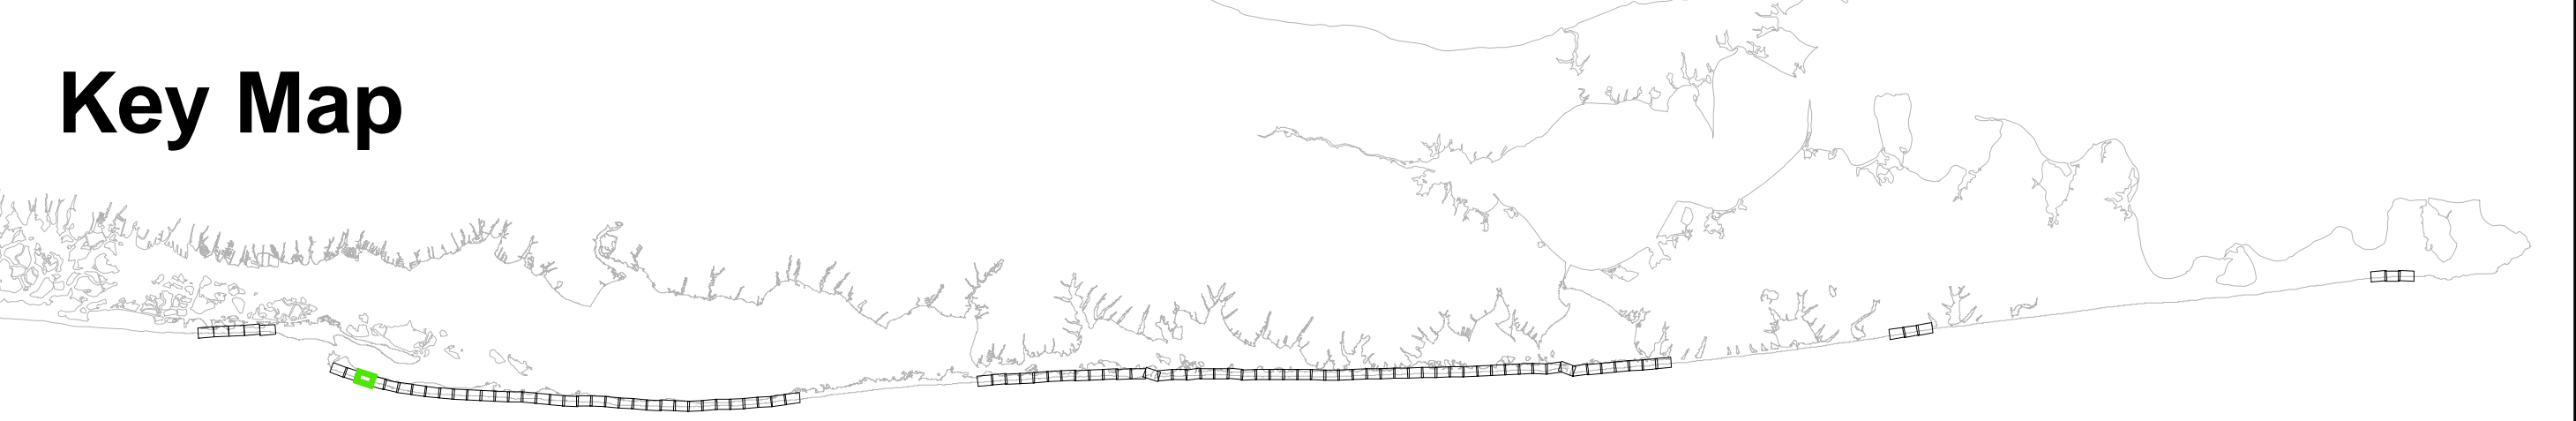
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TITLE:		DRAFT		Fire Island Inlet to Montauk Point, NY Reformulation Study	
DRAWING NO.		RE-8		SHEET 8 OF 95	
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Date: Nov. 18, 2015		Submitted by:		Date:	
Proj. Scale: AS NOTED		Comm. No.: XXXXX		No.	




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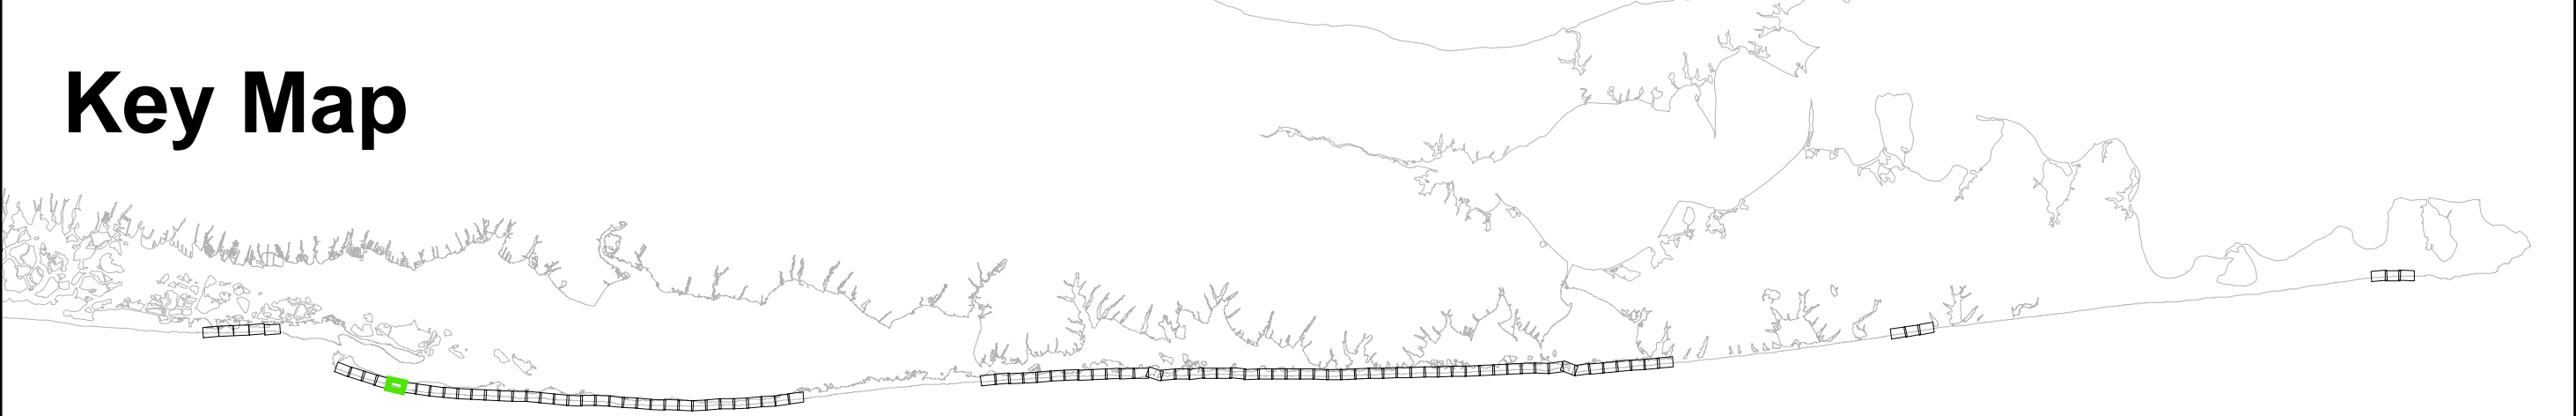
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Checked by:		Reviewed by:		Submitted by:		Comm. No.:	
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Designed by:		Drawn by:		Date:		Proj. Scale:	
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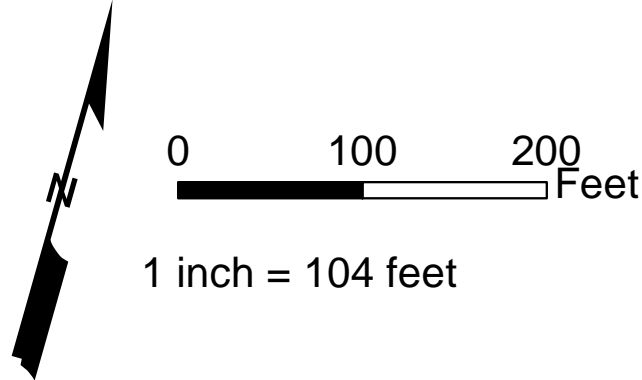


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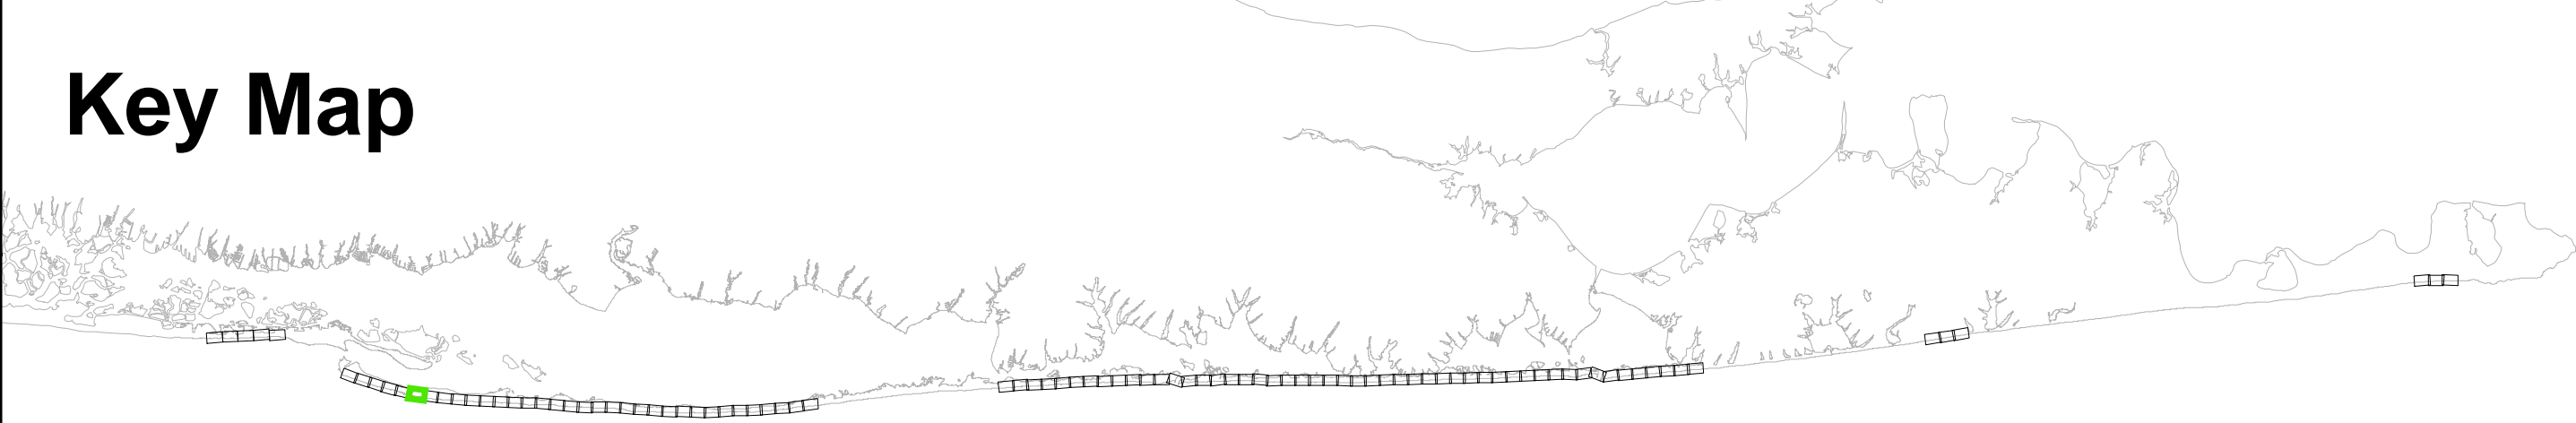
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Designed by:		Drawn by:		Date:		Proj. Scale:	
RW		RW		Nov. 18, 2015		AS NOTED	
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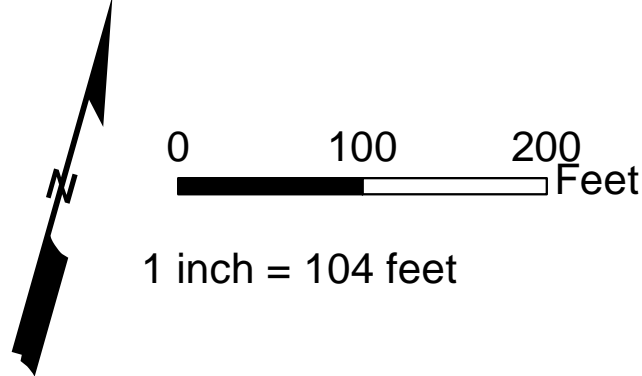

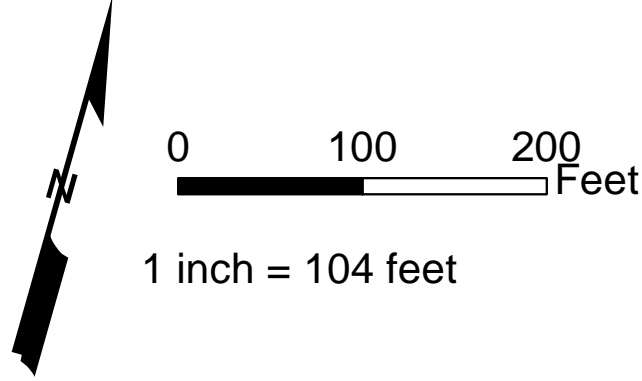
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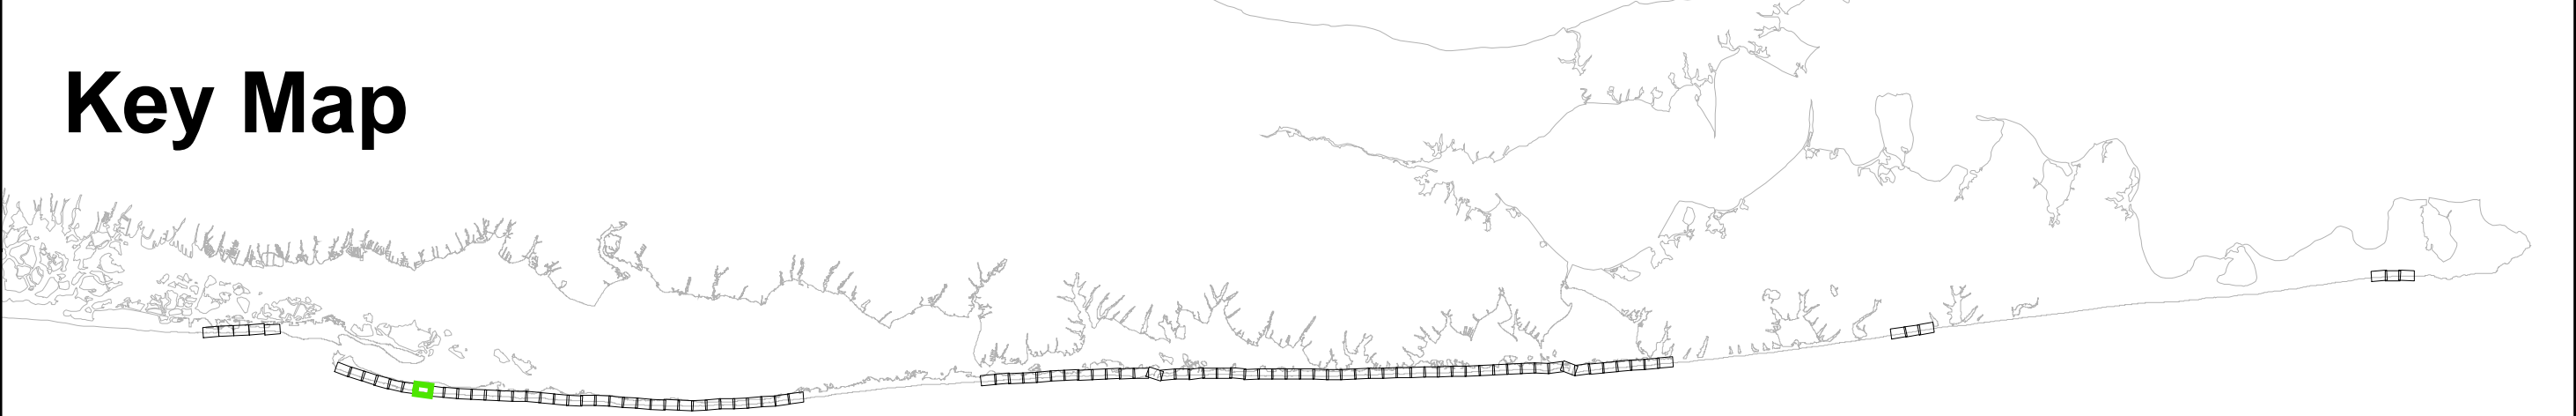
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5. Westhampton Parcel Number: 11

Legend:

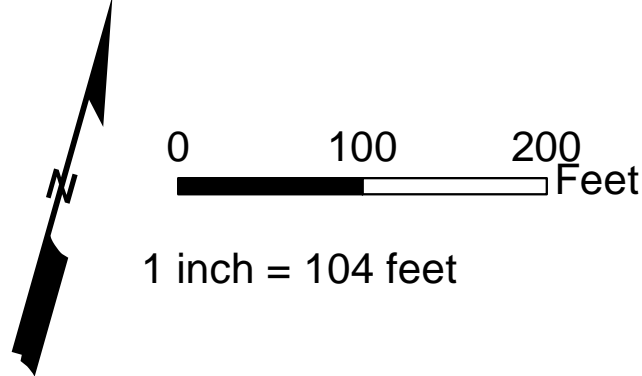
- CEHA
MIDU_Baseline_20151022
Parcels
Easement Area
Impacted Parcels
- GRR Plan Features
Landward Toe of Dune
Seaward Toe of Dune
Seaward Berm Crest
Design MHW (2 ft NGVD)
Dune - 1st Construction
Berm - 1st Construction



Key Map



<div>TITLE: DRAFT Fire Island Inlet to Montauk Point, NY Reformulation Study</div> <div>DRAWING NO. RE-12</div> <div>SHEET 12 OF 95</div>		Reference Files:							
		Designed by:	RWH	Checked by:					
		Drawn by:	RWH	Reviewed by:					
		Date:	Nov 18, 2015	Submitted by:					
		Plot Scale:	AS NOTED	Comm. No.:					
				XXXXX		No.	Date		

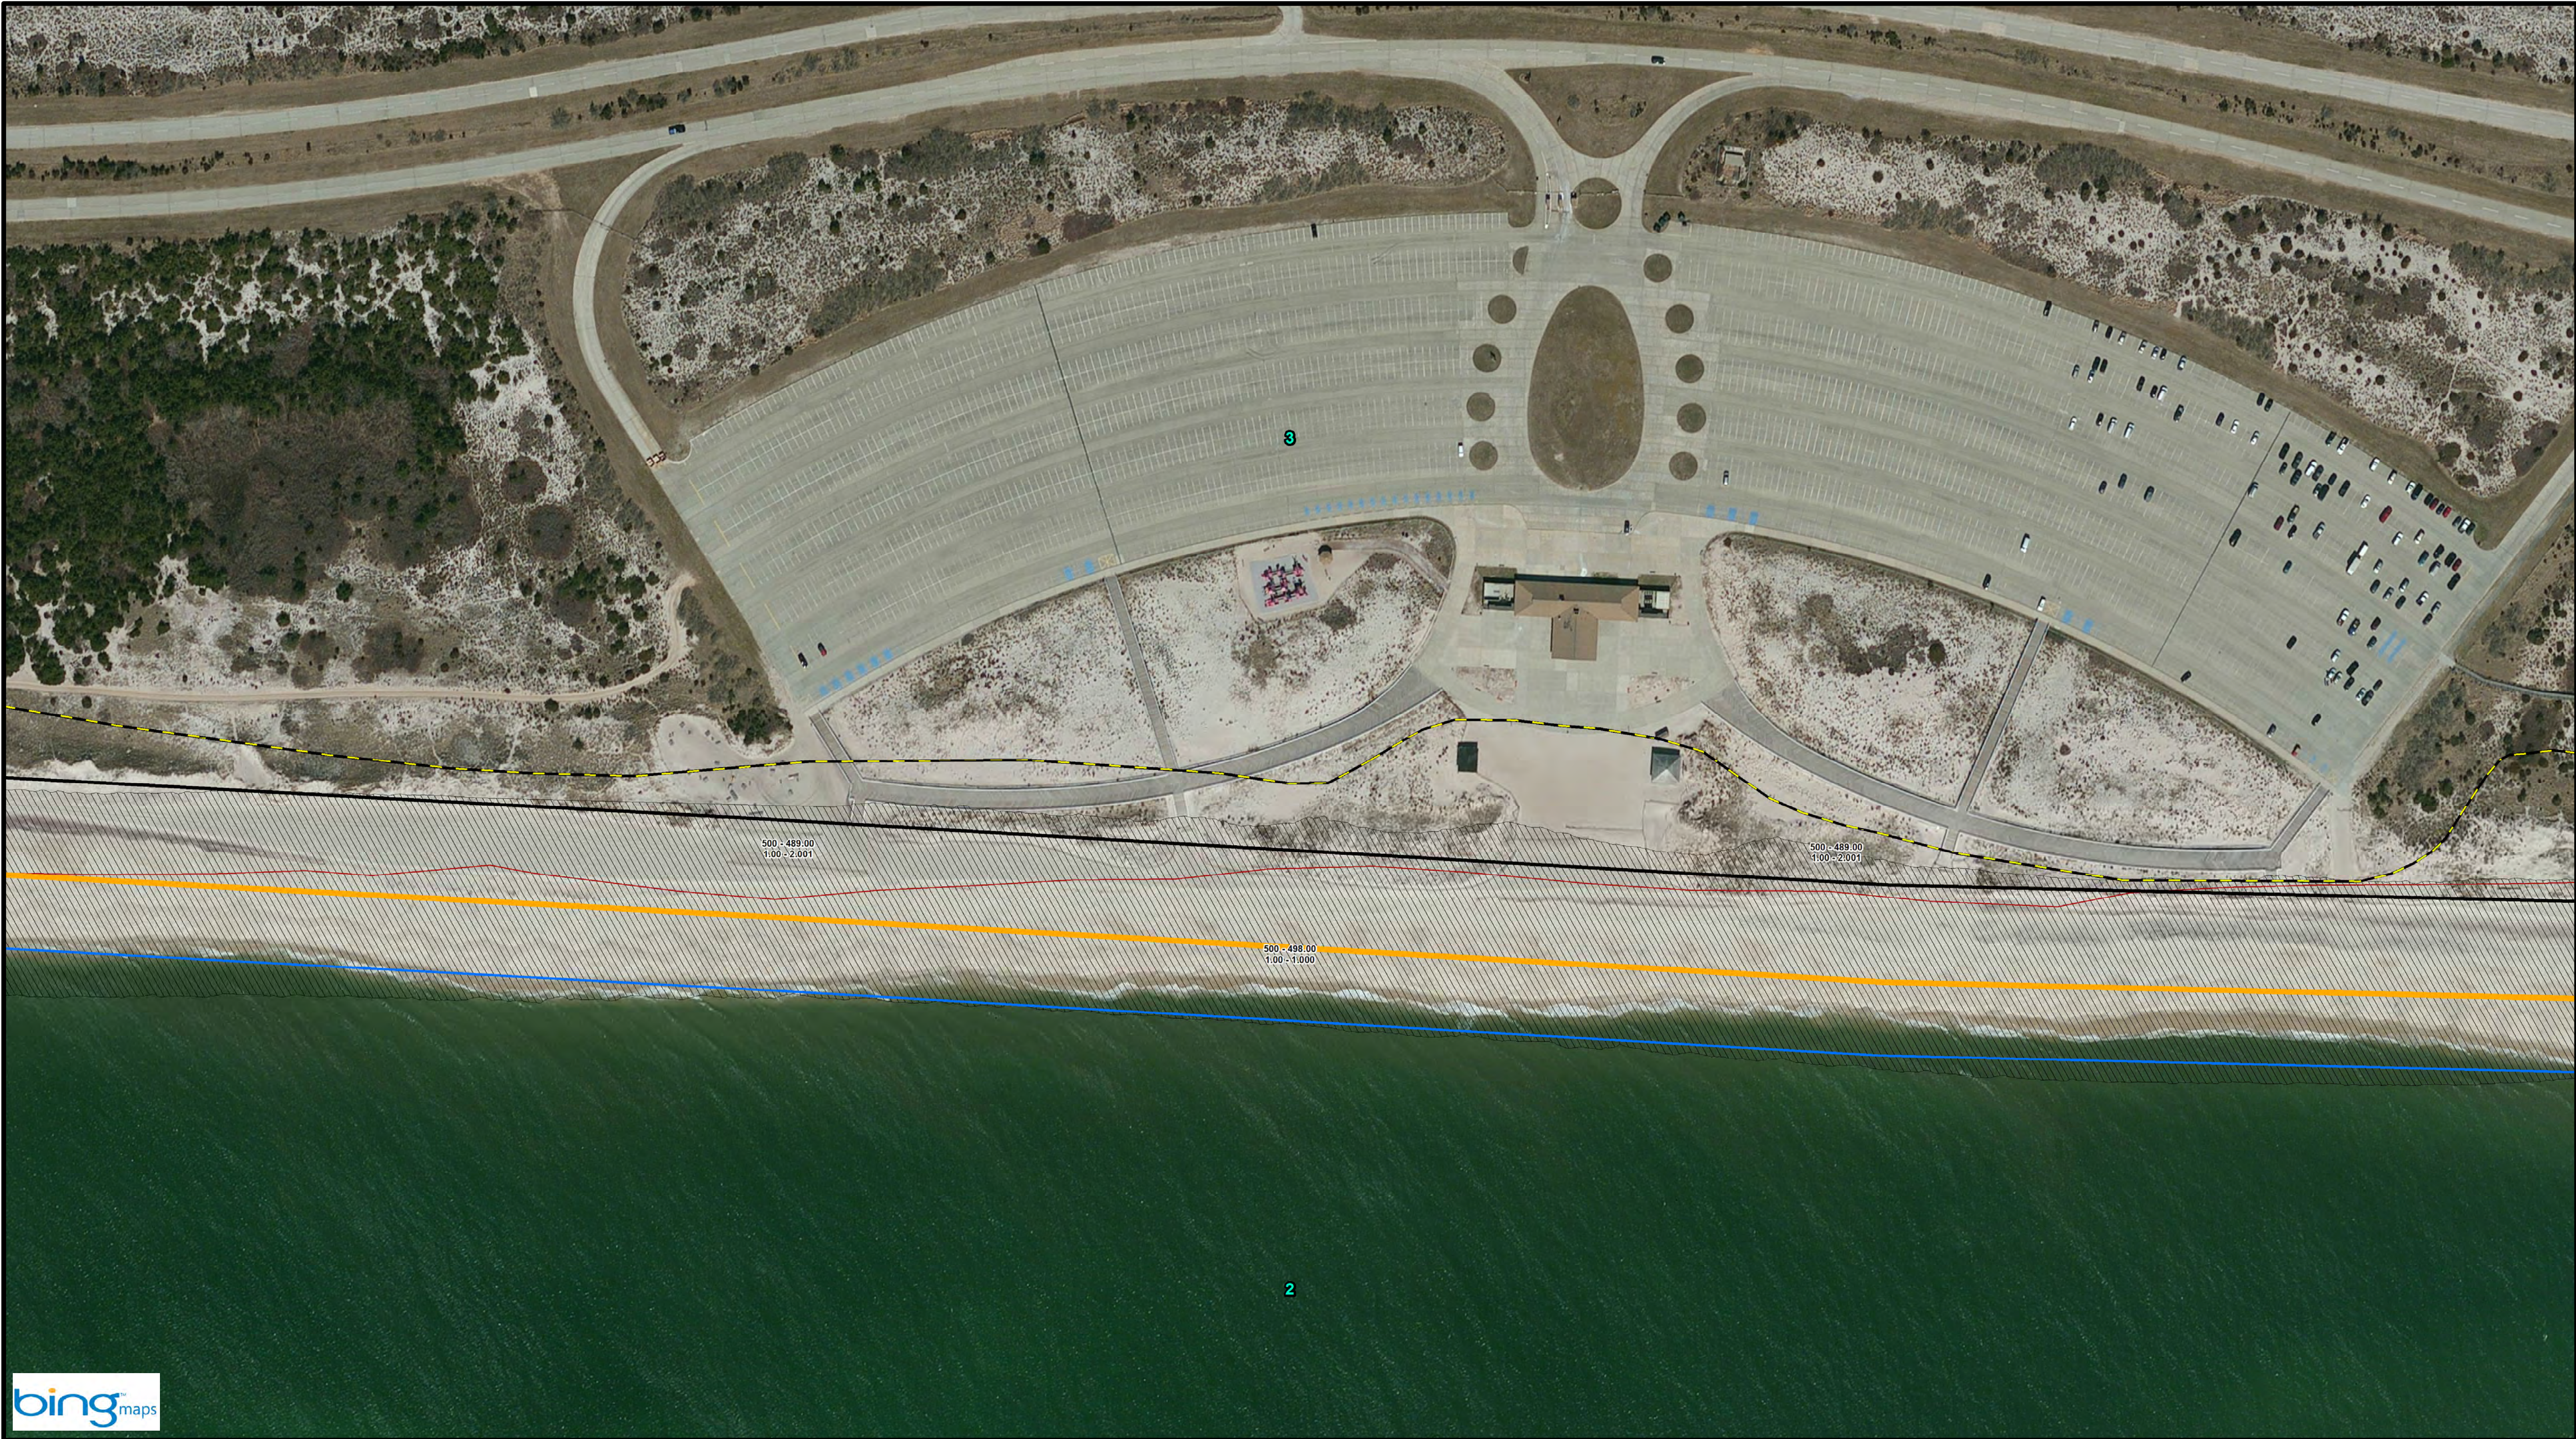


Notes:

1. Parcel data: District - Section
Block - Lot
2. GRR Parcel Number: 11
3. FIMI Parcel Number: 11
4. Montauk Parcel Number: 11
5. Westhampton Parcel Number: 11

Legend:

- CEHA
- MIDU_Baseline_20151022
- Parcels
- Easement Area
- Impacted Parcels
- GRR Plan Features
- Landward Toe of Dune
- Seaward Toe of Dune
- Seaward Berm Crest
- Design MHW (2 ft NGVD)
- Dune - 1st Construction
- Berm - 1st Construction

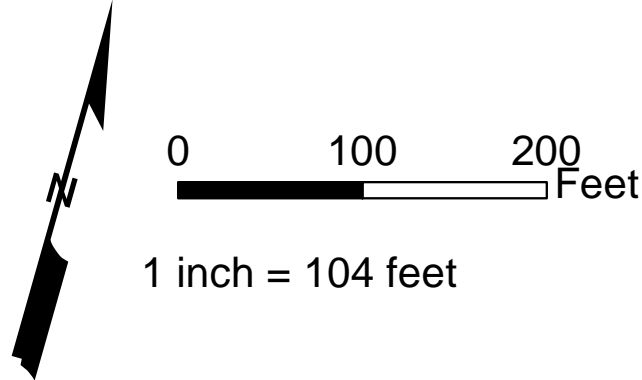

Key Map



TITLE:		DRAFT		Fire Island Inlet to Montauk Point, NY Reformulation Study	
DRAWING NO.		RE-13		SHEET 13 OF 95	
Reference Files:		Designed by: RWH		Checked by:	
		Drawn by: RWH		Reviewed by:	
		Date: Nov. 18, 2015		Submitted by:	
		Proj. Scale: AS NOTED		Comm. No.: XXXXX	
				No. 100	




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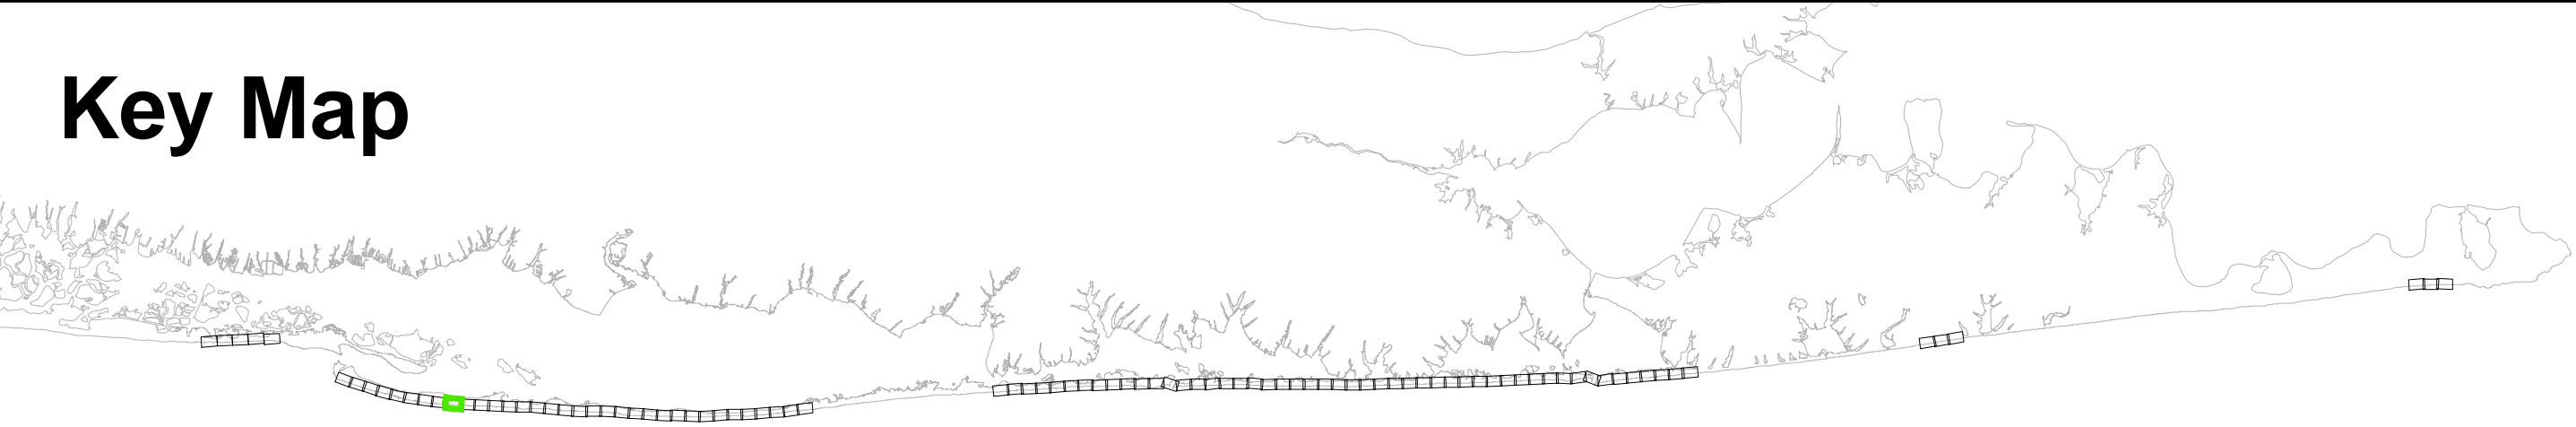
1. Parcel data: District - Section
Block - Lot
2. GRR Parcel Number: 11
3. FIMI Parcel Number: 11
4. Montauk Parcel Number: 11
5. Westhampton Parcel Number: 11

Legend:

- CEHA
MIDU_Baseline_20151022
Parcels
Easement Area
Impacted Parcels
- GRR Plan Features
Landward Toe of Dune
Seaward Toe of Dune
Seaward Berm Crest
Design MHW (2 ft NGVD)
Dune - 1st Construction
Berm - 1st Construction

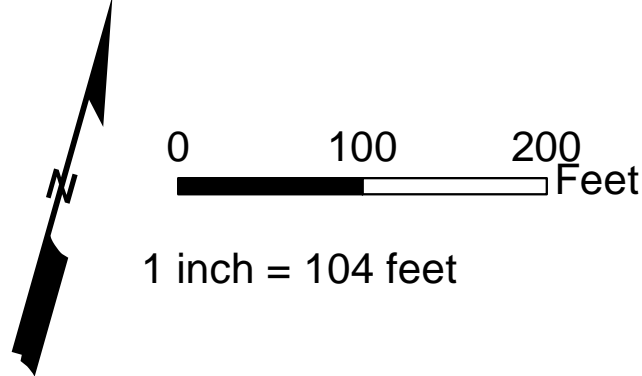

Key Map



TITLE: DRAFT Fire Island Inlet to Montauk Point, NY Reformulation Study		Reference Files:		Designed by:	Checked by:	No.	
		Drawn by:	Reviewed by:	RWH	RWH		
DRAWING NO. RE-14		Date:	Submitted by:	Nov. 18, 2015	Submitted by:	SHEET 14 OF 95	
		Proj. Scale:	Comm. No.:	AS NOTED	XXXXX		



Notes:

1. Parcel data: District - Section
Block - Lot
2. GRR Parcel Number: 11
3. FIMI Parcel Number: 11
4. Montauk Parcel Number: 11
5. Westhampton Parcel Number: 11

Legend:

- CEHA

MIDU_Baseline_20151022

Parcels

Easement Area

Impacted Parcels
- GRR Plan Features

Landward Toe of Dune


Seaward Toe of Dune

Seaward Berm Crest


Design MHW (2 ft NGVD)

Dune - 1st Construction

Berm - 1st Construction

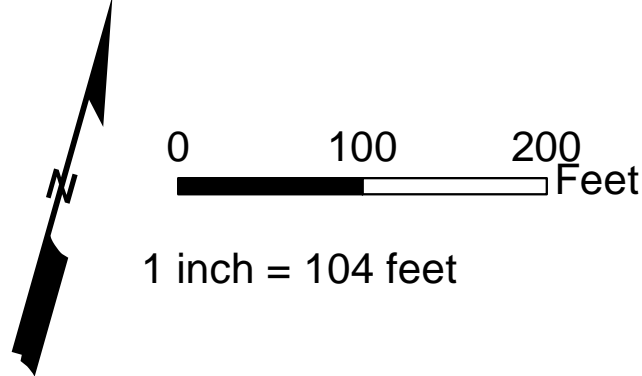


Key Map

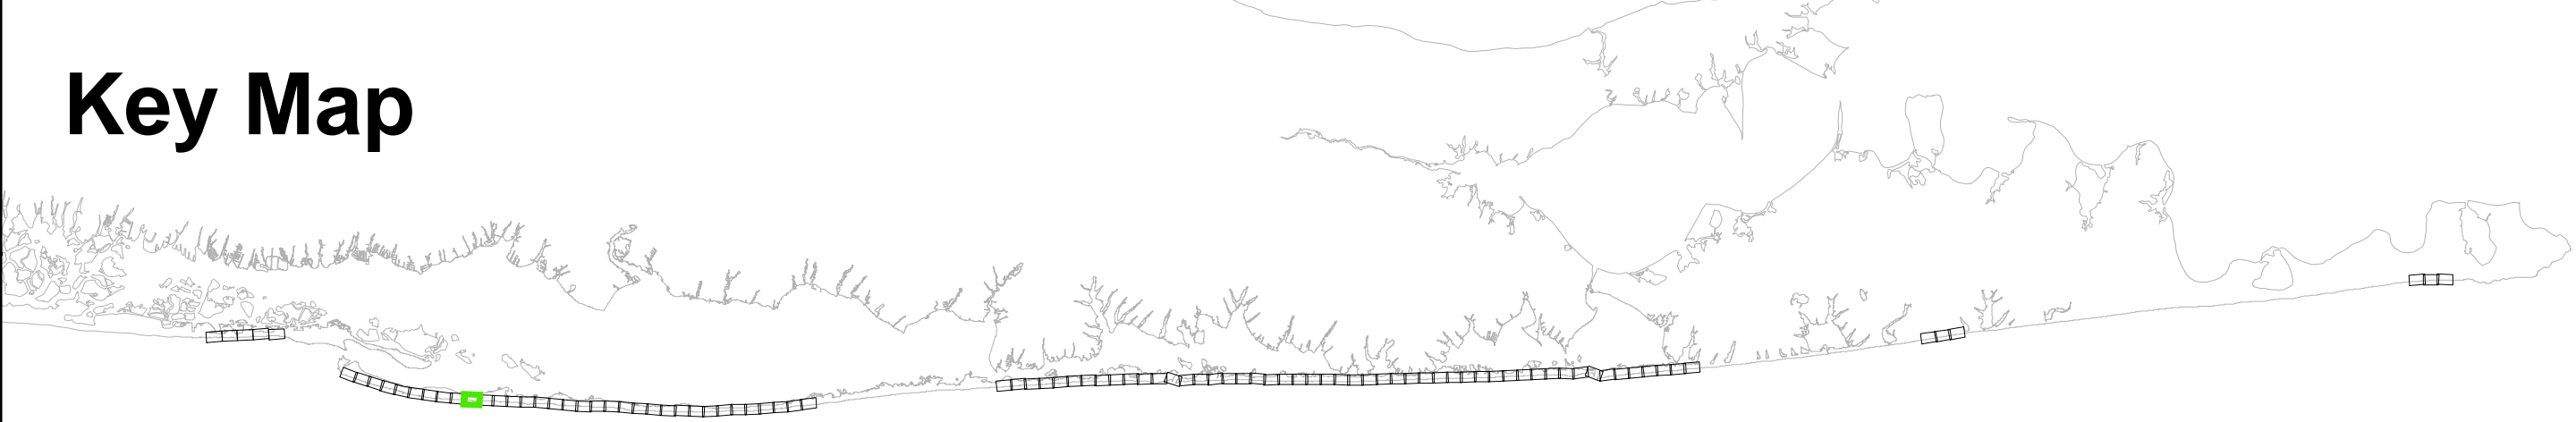


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	RW		RW		Nov. 18, 2015		XXXXX									
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	RW		RW		Nov. 18, 2015		AS NOTED									
	Reference Files:		Reference Files:		Reference Files:		Reference Files:									
TITLE:																
Fire Island Inlet to Montauk Point, NY																
Reformulation Study																
DRAWING NO.																
RE-15																
SHEET 15 OF 95																



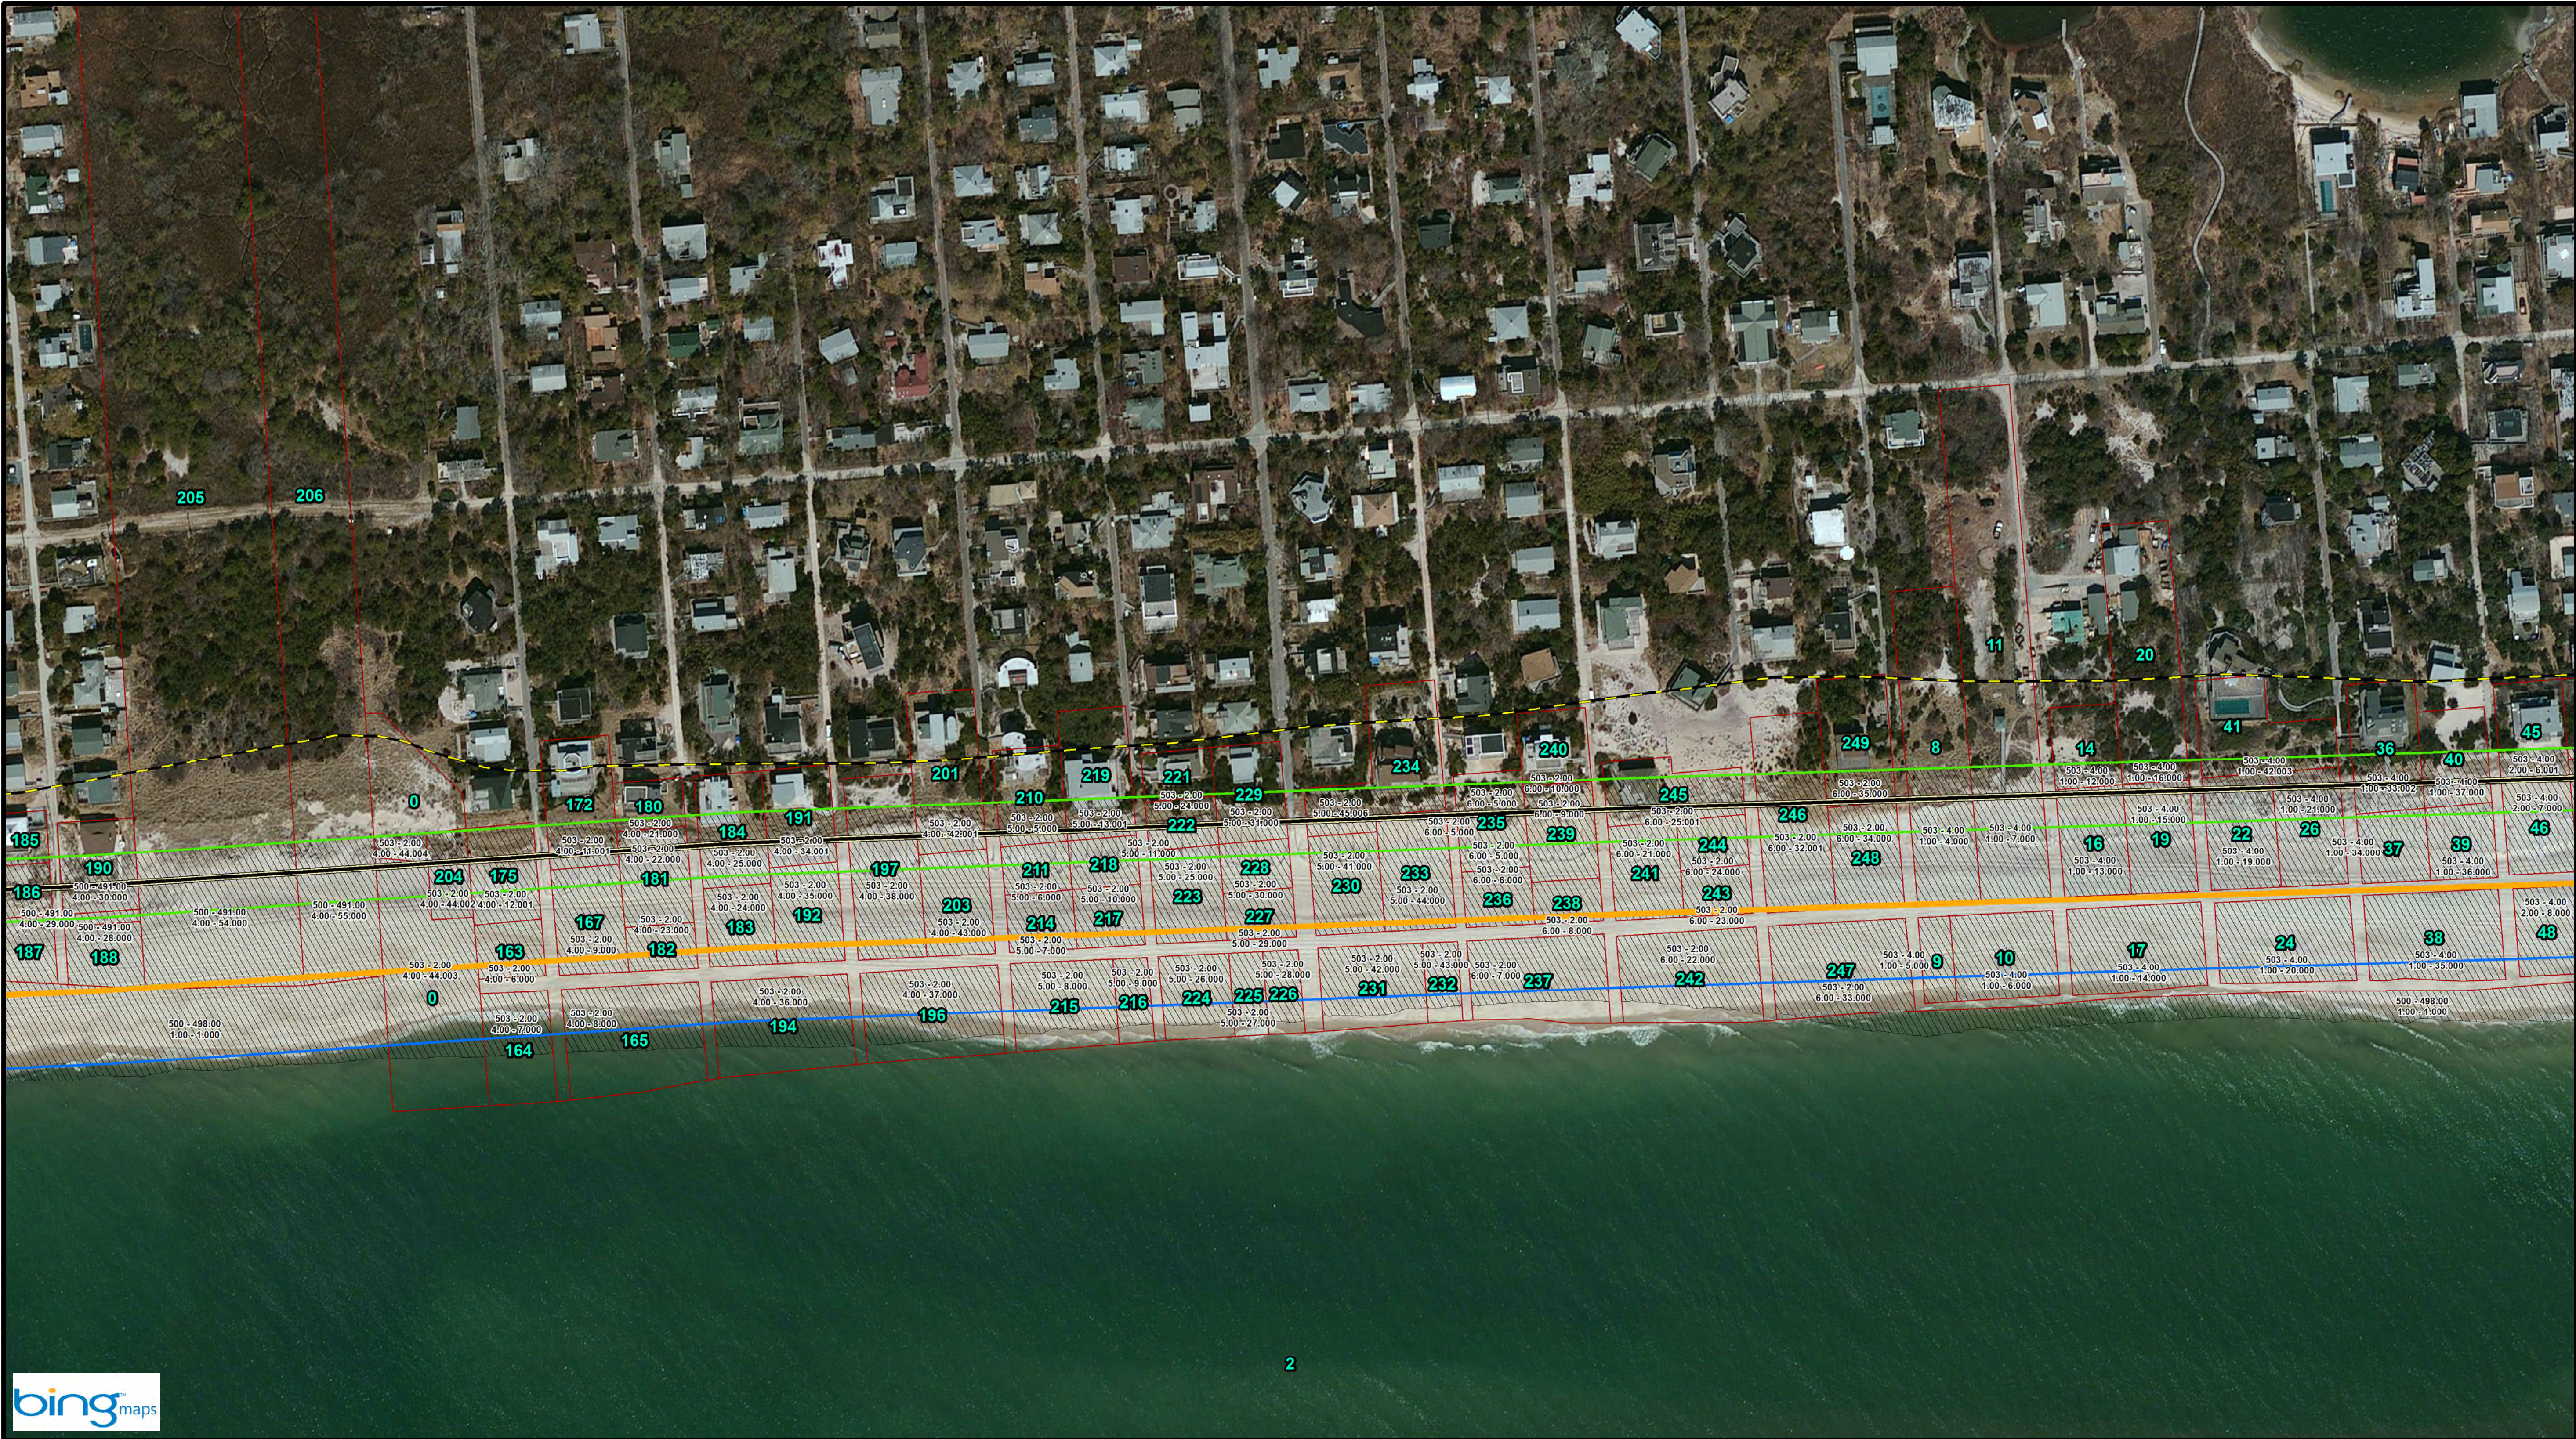

- Notes:**
1. Parcel data: District - Section
Block - Lot
2. GRR Parcel Number: **11**
3. FIMI Parcel Number: **11**
4. Montauk Parcel Number: **11**
5. Westhampton Parcel Number: **11**


- Legend:**
- CEHA
 - MIDU_Baseline_20151022
 - Parcels
 - Easement Area
 - Impacted Parcels
 - GRR Plan Features
 - Landward Toe of Dune
 - Seaward Toe of Dune
 - Seaward Berm Crest
 - Design MHW (2 ft NGVD)
 - Dune - 1st Construction
 - Berm - 1st Construction

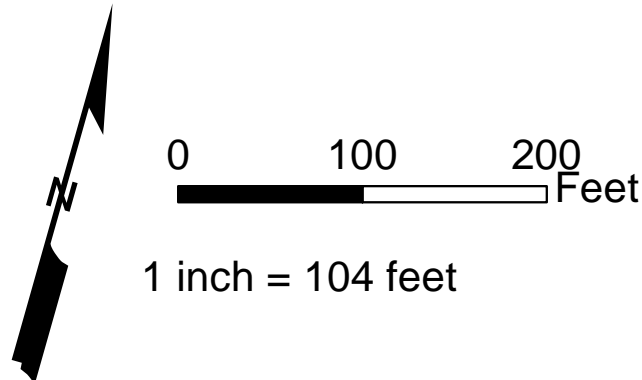

Key Map



Reference Files:		Designed by:	RWH	Checked by:	
		Drawn by:	RWH	Reviewed by:	
		Date:	Nov. 18, 2015	Submitted by:	
		Proj. Scale:	AS NOTED	Comm. No.:	XXXXX
TITLE:		Fire Island Inlet to Montauk Point, NY Reformulation Study			
		DRAWING NO.			
		RE-17			
		SHEET 17 OF 95			

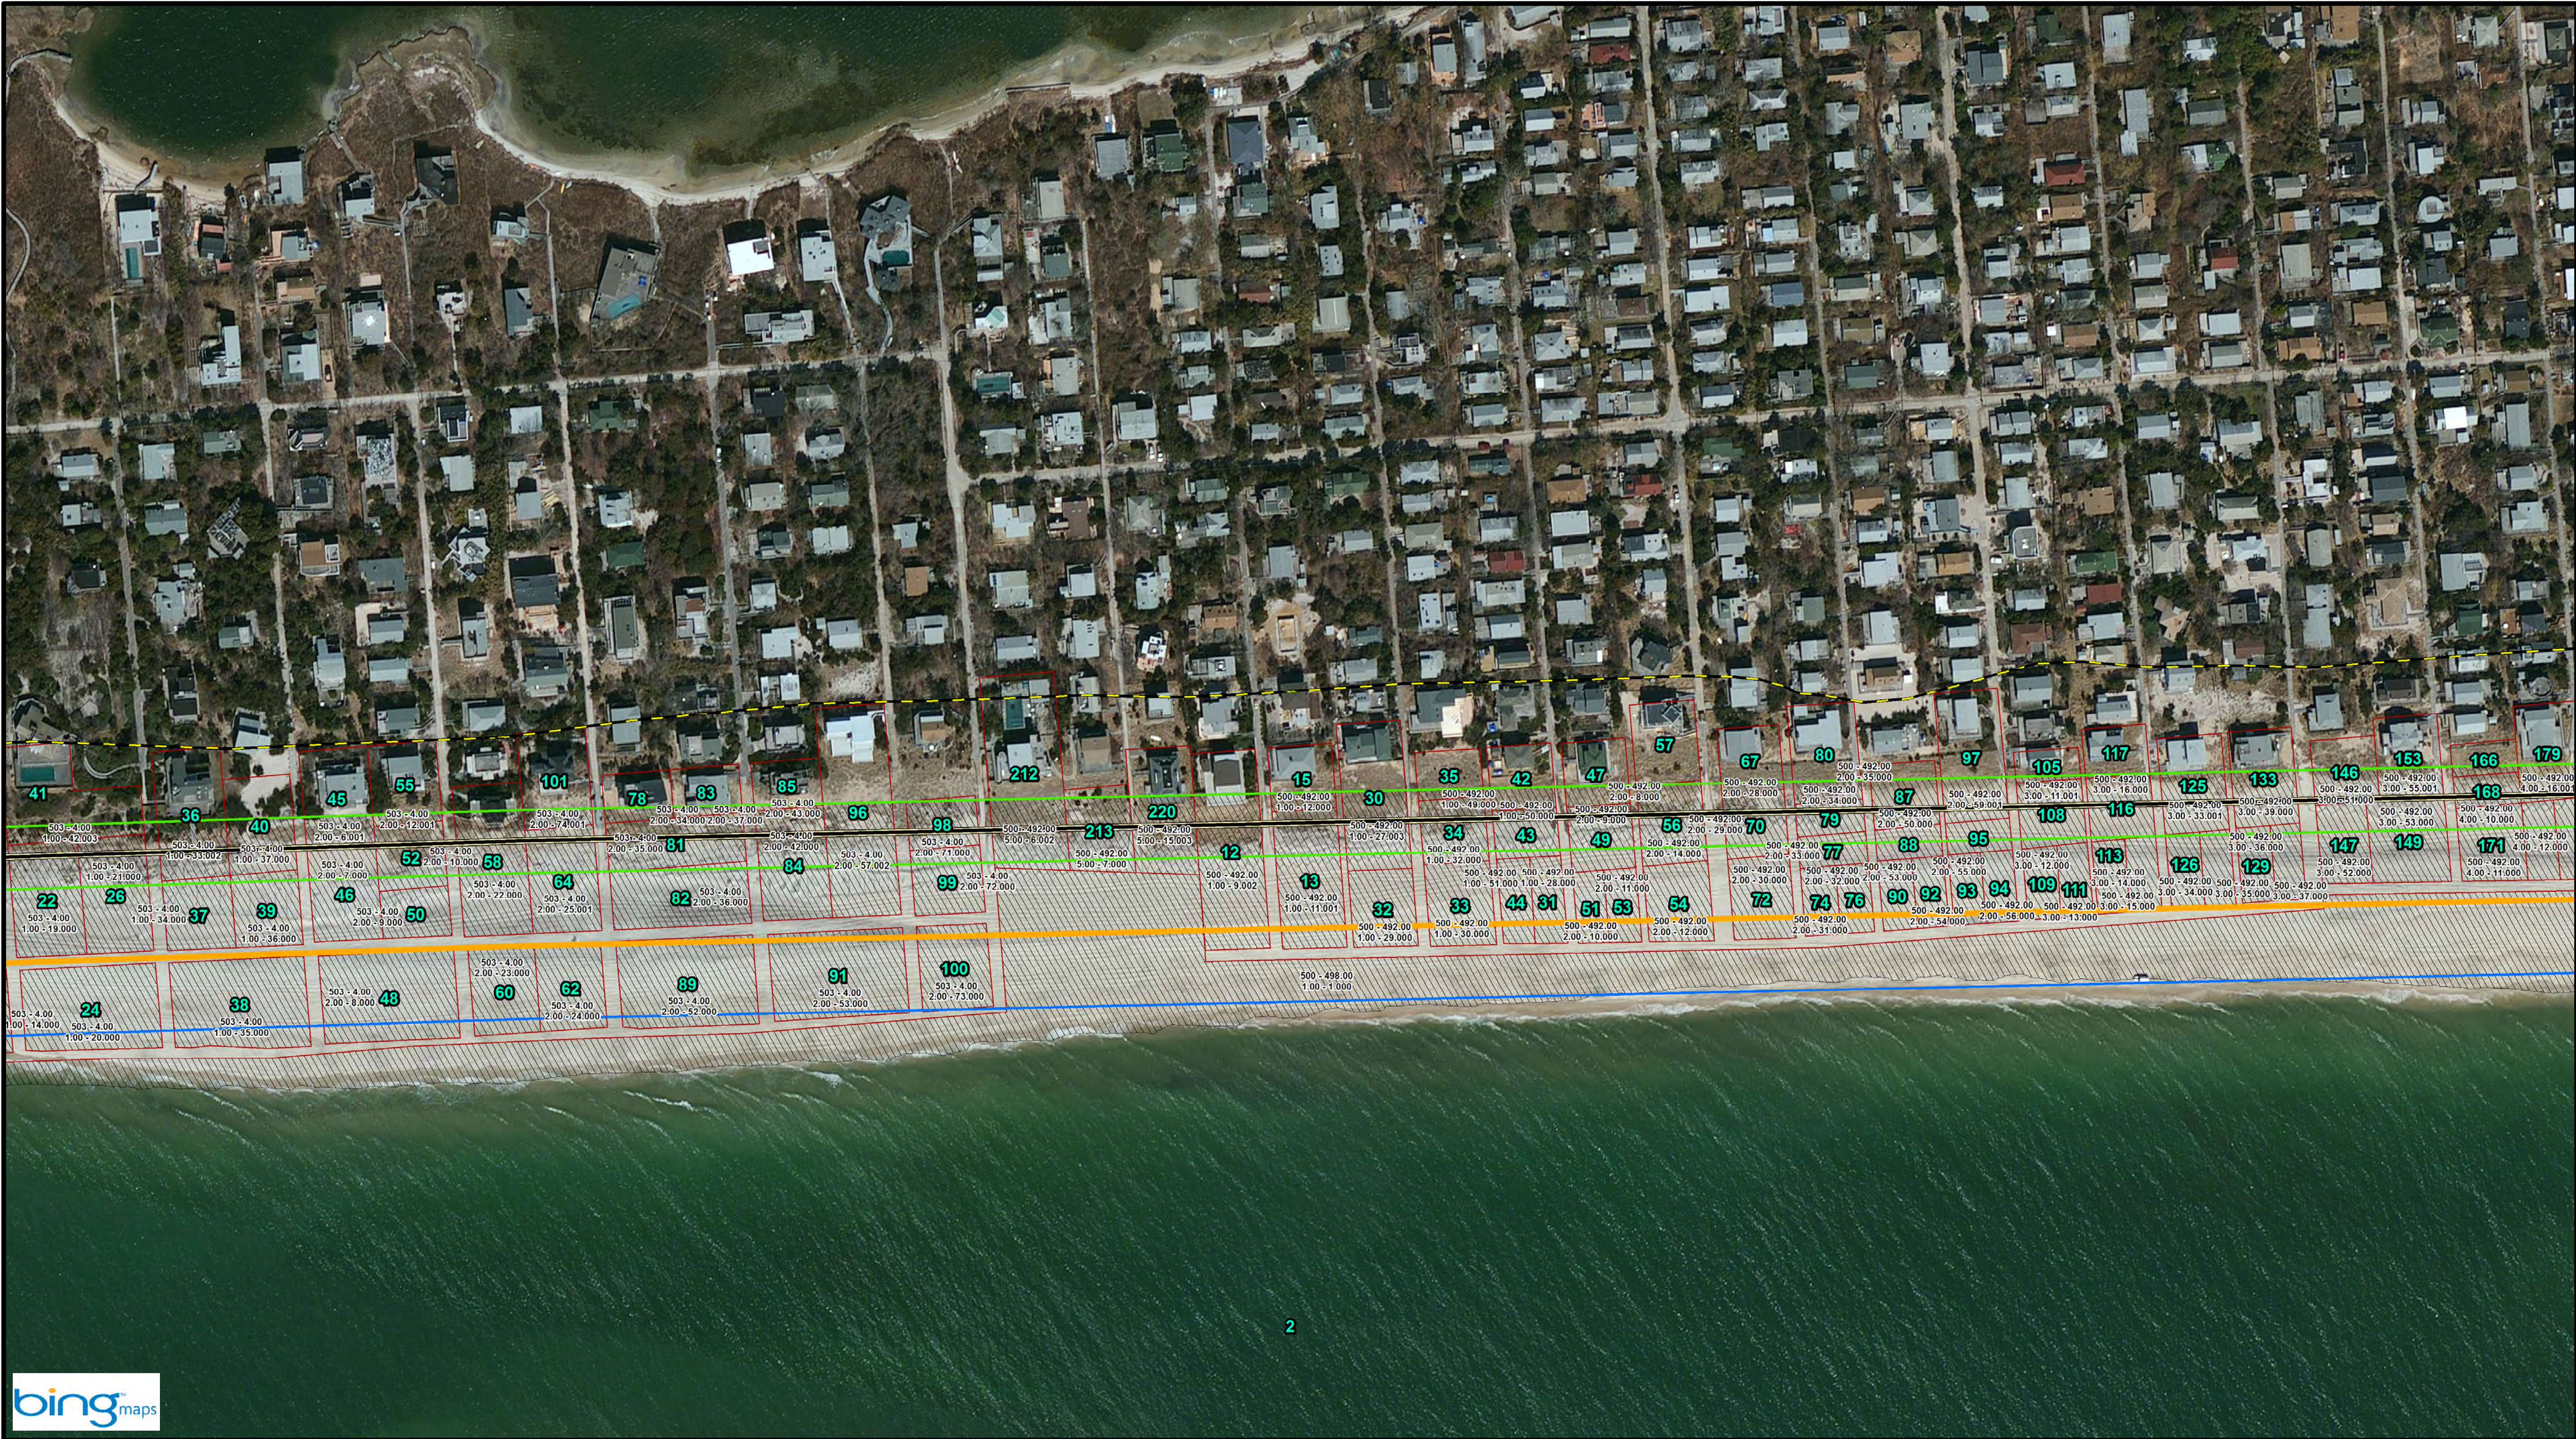


Notes:

- Parcel data: District - Section
Block - Lot
- GRR Parcel Number: 11
- FIMI Parcel Number: 11
- Montauk Parcel Number: 11
- Westhampton Parcel Number: 11

Legend:


- CEHA
- MIDU_Baseline_20151022
- Parcels
- Easement Area
- Impacted Parcels
- GRR Plan Features
- Landward Toe of Dune
- Seaward Toe of Dune
- Seaward Berm Crest
- Design MHW (2 ft NGVD)
- Dune - 1st Construction
- Berm - 1st Construction

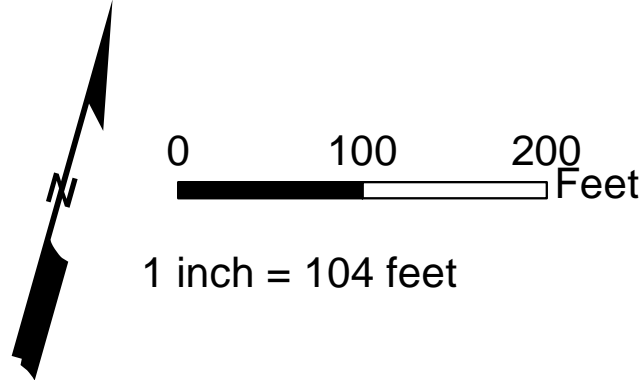

Key Map




TITLE: DRAFT Fire Island Inlet to Montauk Point, NY Reformulation Study	Reference Files:		Designed by:	Checked by:
	Drawn by:		RWH	
	Date:		Nov. 18, 2015	
	Proj. Scale:		AS NOTED	
DRAWING NO. RE-18 SHEET 18 OF 95	Comm. No.:		XXXXX	
	Submitted by:			
	Reviewed by:			
	Date:			

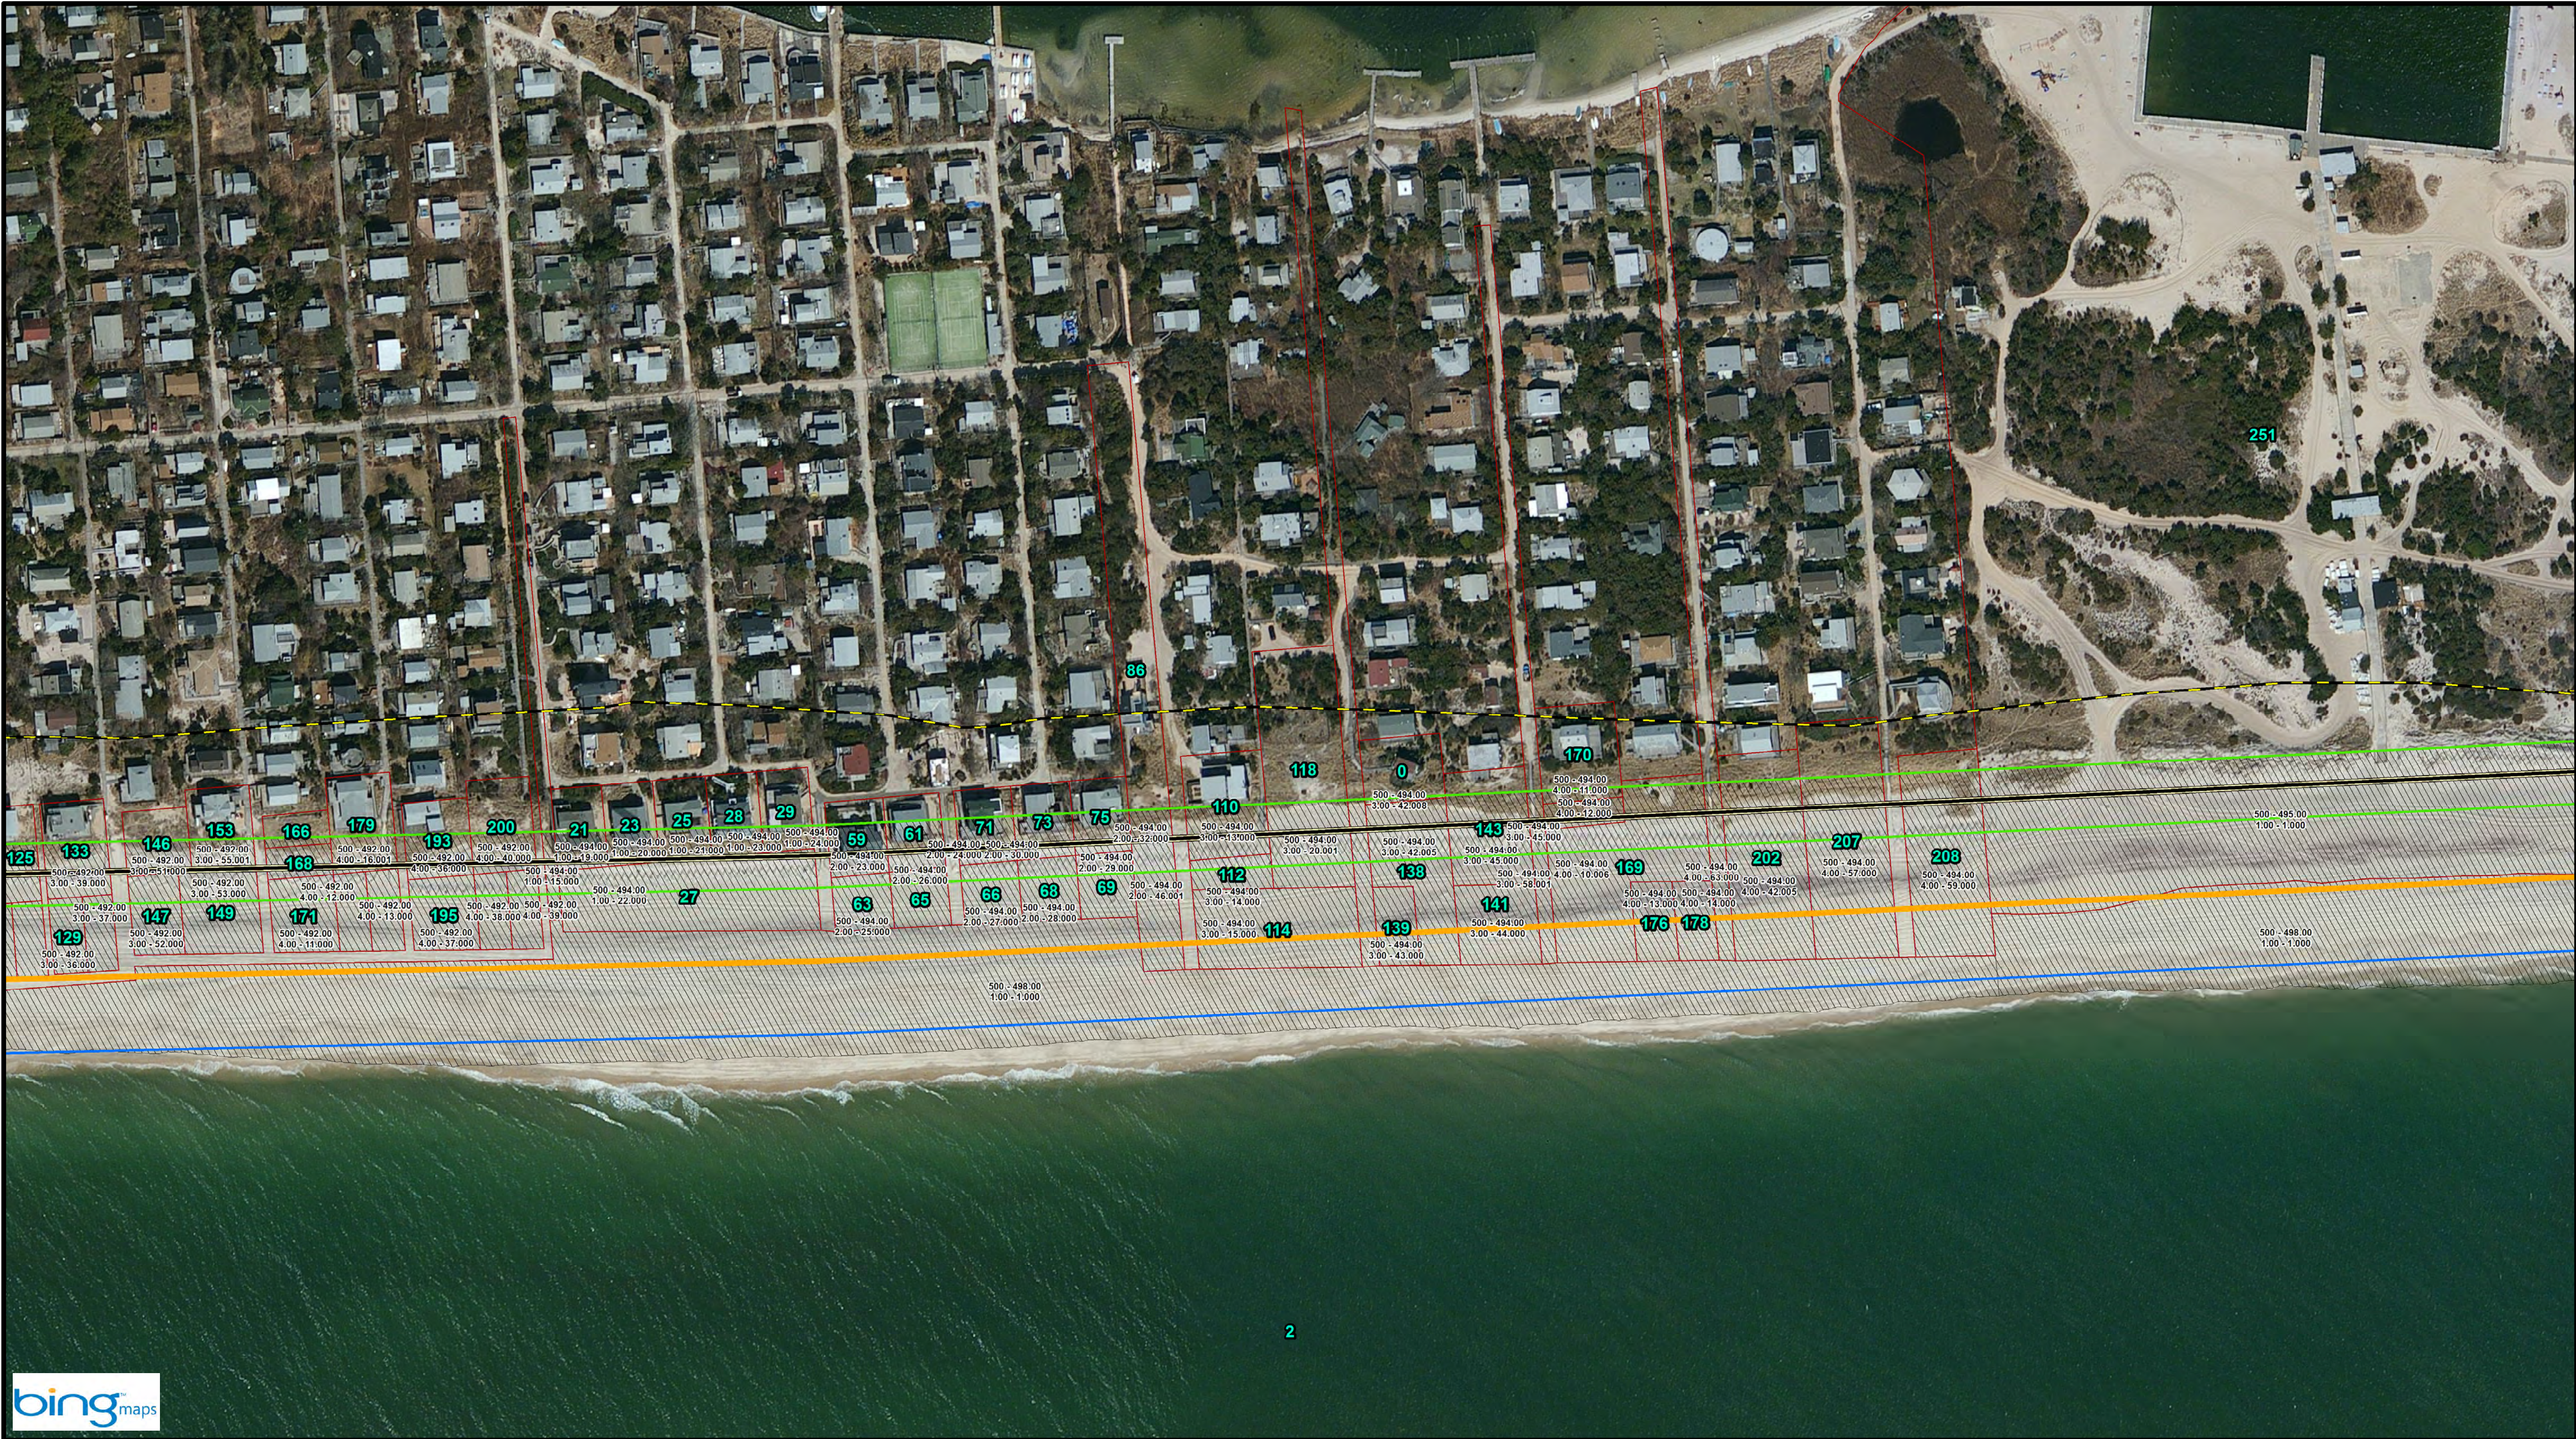

- Notes:**
1. Parcel data: District - Section
Block - Lot
 2. GRR Parcel Number: 11
 3. FIMI Parcel Number: 11
 4. Montauk Parcel Number: 11
 5. Westhampton Parcel Number: 11

- Legend:**
- CEHA
 - MIDU_Baseline_20151022
 - Parcels
 - Easement Area
 - Impacted Parcels
 - GRR Plan Features
 - Landward Toe of Dune
 - Seaward Toe of Dune
 - Seaward Berm Crest
 - Design MHW (2 ft NGVD)
 - Dune - 1st Construction
 - Berm - 1st Construction

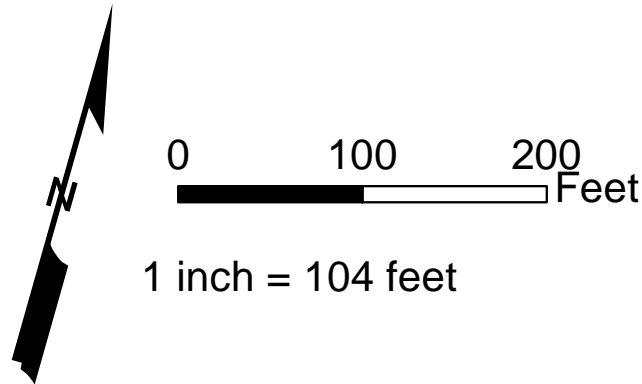

Key Map



Checked by:		Reviewed by:		Submitted by:		Comm. No.:	
Designed by:		Drawn by:		Date:		Proj. Scale:	
RWI		RWI		Nov. 18, 2015		P/S NOTED	
Reference Files:		TITLE:		DRAFT		RE-19	
		Fire Island Inlet to Montauk Point, NY		Reformulation Study		DRAWING NO.	
						SHEET 19 OF 95	




Notes:

1. Parcel data: District - Section
Block - Lot
2. GRR Parcel Number: **11**
3. FIMI Parcel Number: **11**
4. Montauk Parcel Number: **11**
5. Westhampton Parcel Number: **11**

Legend:


- CEHA
- MIDU_Baseline_20151022
- Parcels
- Easement Area
- Impacted Parcels
- GRR Plan Features
- Landward Toe of Dune
- Seaward Toe of Dune
- Seaward Berm Crest
- Design MHW (2 ft NGVD)
- Dune - 1st Construction
- Berm - 1st Construction

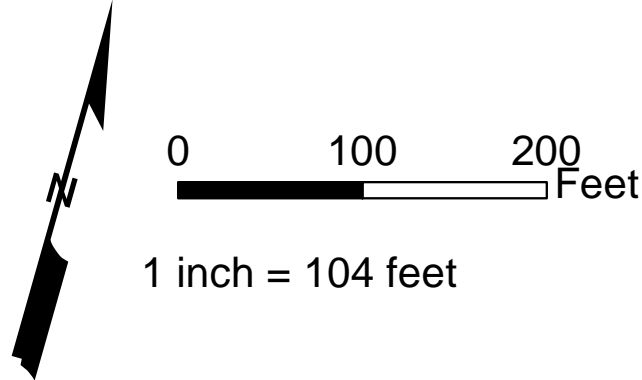

Key Map




TITLE:		DRAFT		Fire Island Inlet to Montauk Point, NY Reformulation Study	
DRAWING NO.		RE-20		SHEET 20 OF 95	
Reference Files:		Designed by: RWH		Checked by:	
		Drawn by: RWH		Reviewed by:	
		Date: Nov. 18, 2015		Submitted by:	
		Proj. Scale: AS NOTED		Comm. No.: XXXXX	

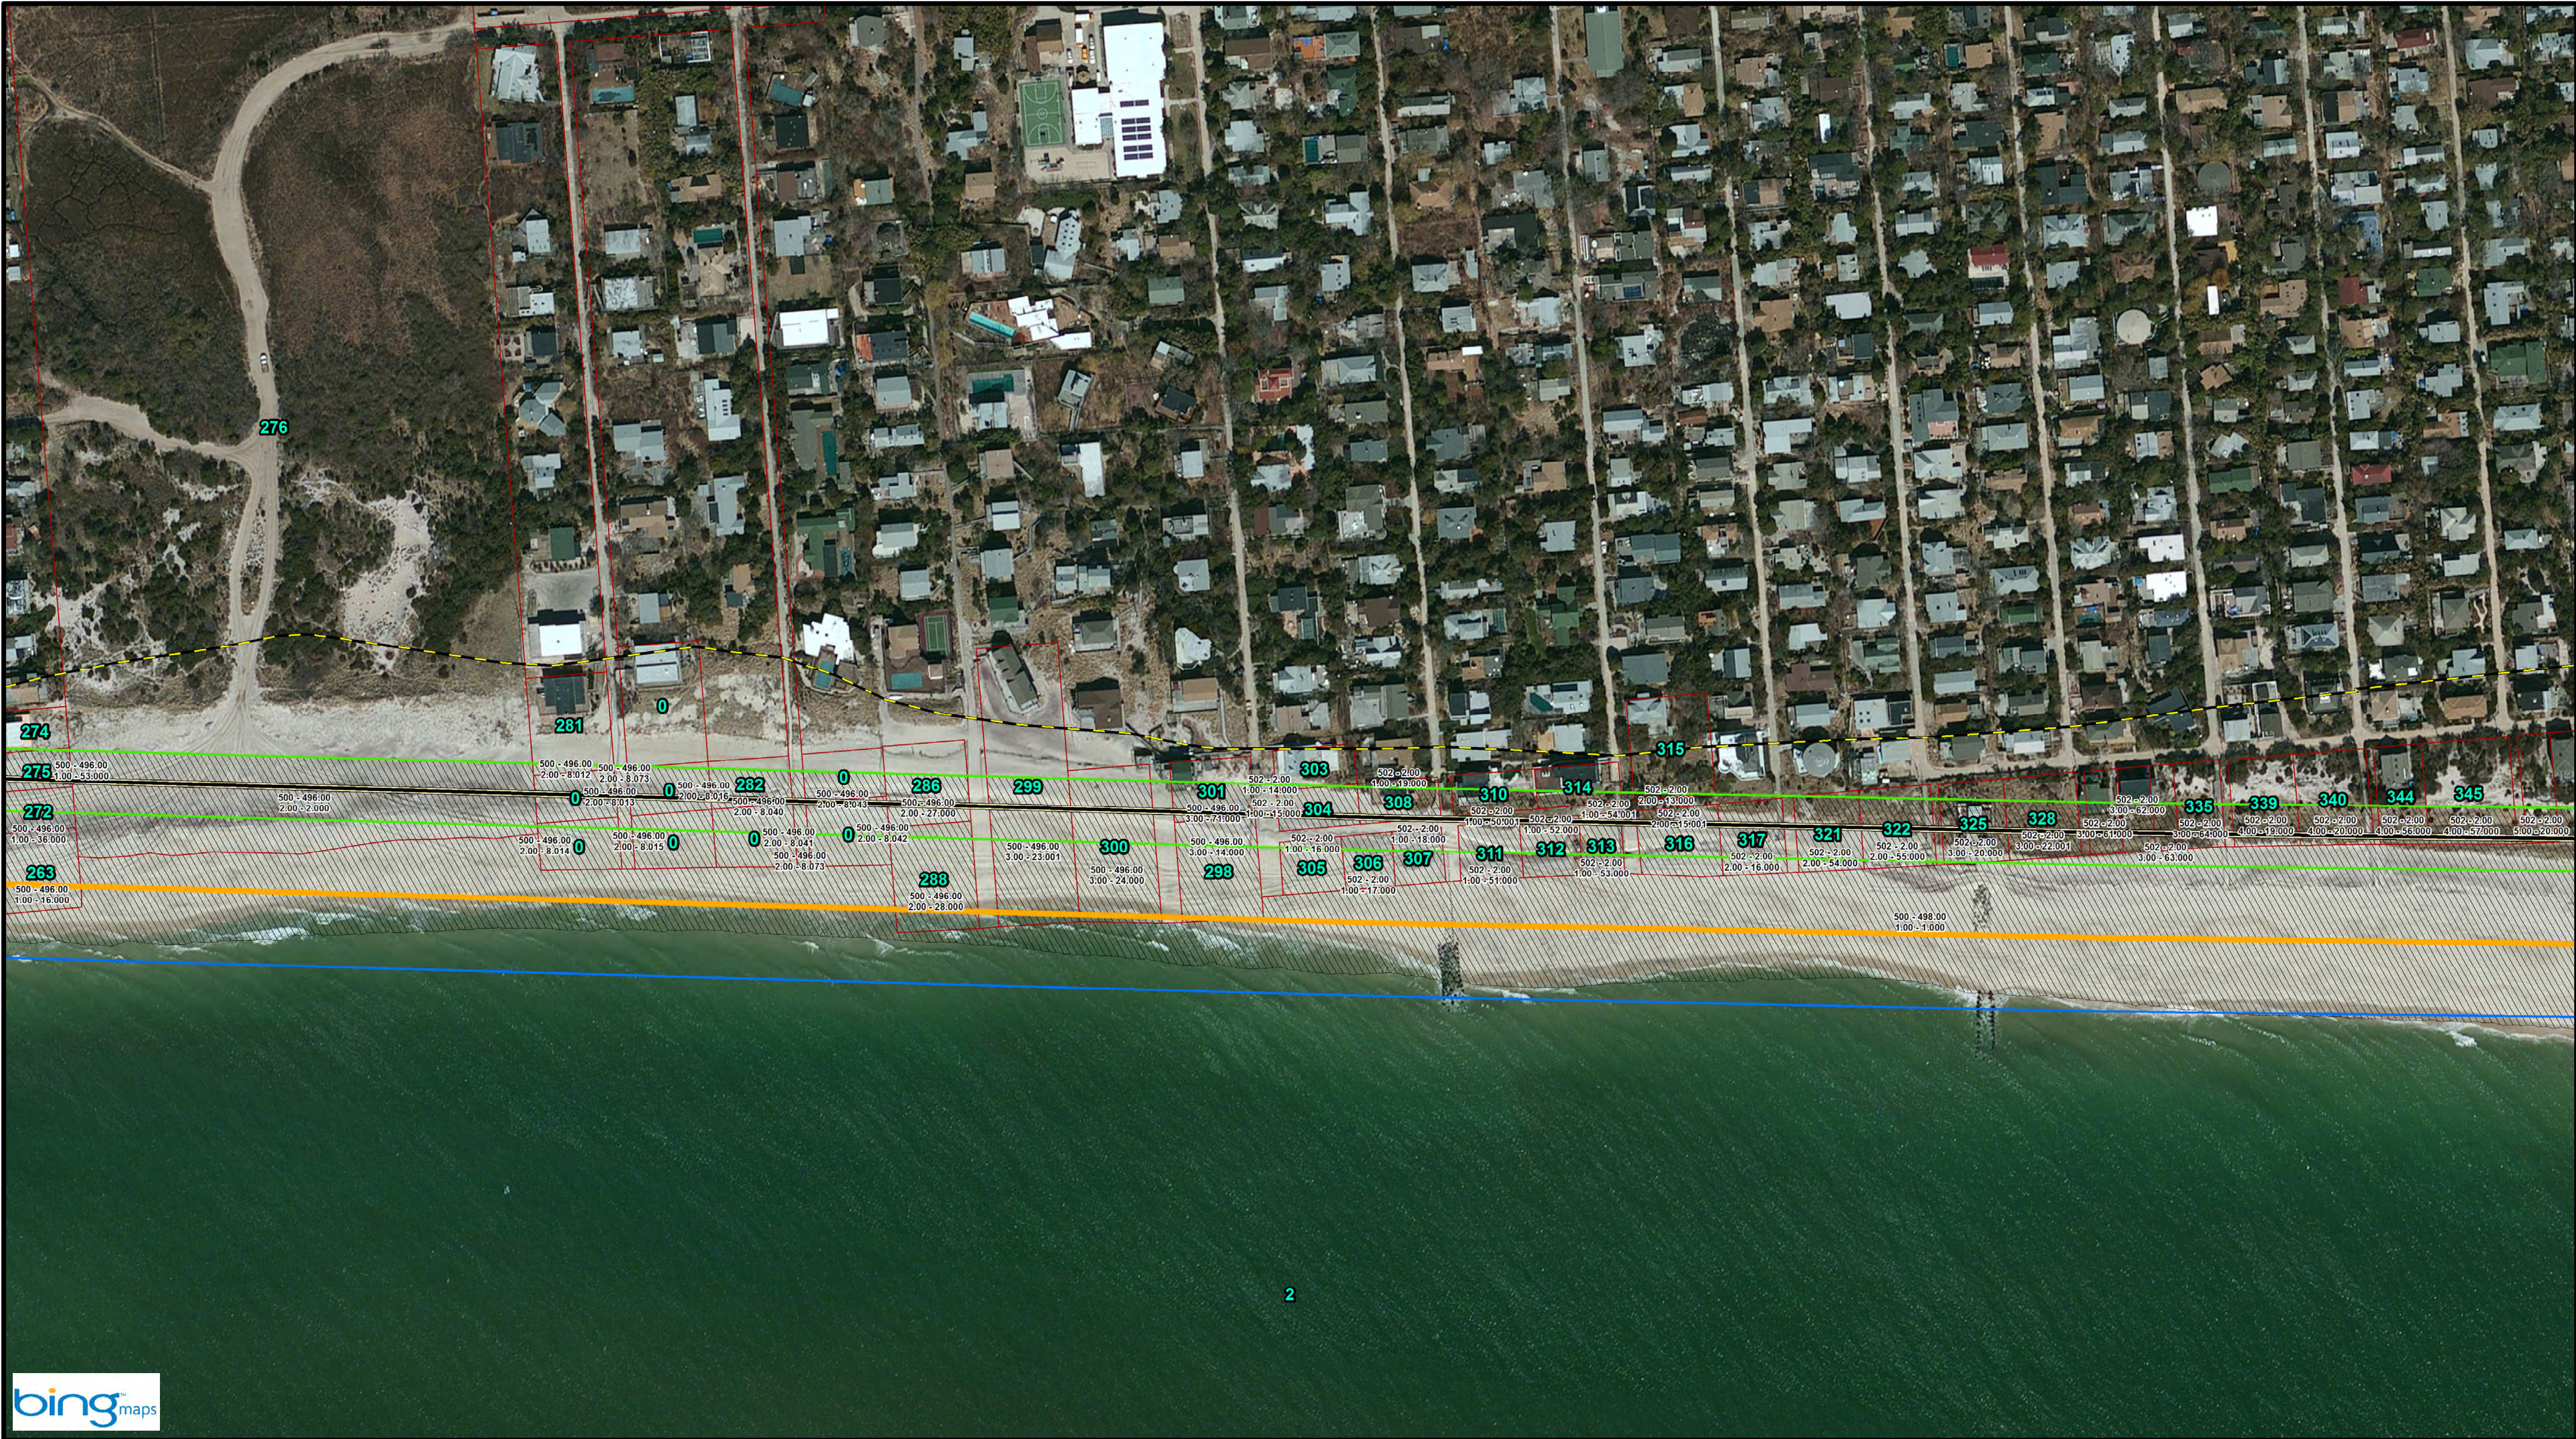

- Notes:**
- Parcel data: District - Section
Block - Lot
 - GRR Parcel Number: **11**
 - FIMI Parcel Number: **11**
 - Montauk Parcel Number: **11**
 - Westhampton Parcel Number: **11**


- Legend:**
- CEHA
 - MIDU_Baseline_20151022
 - Parcels
 - Easement Area
 - Impacted Parcels
 - GRR Plan Features
 - Landward Toe of Dune
 - Seaward Toe of Dune
 - Seaward Berm Crest
 - Design MHW (2 ft NGVD)
 - Dune - 1st Construction
 - Berm - 1st Construction

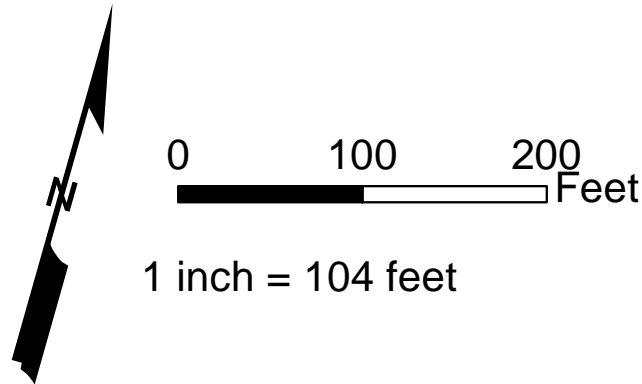

Key Map



TITLE: DRAFT Fire Island Inlet to Montauk Point, NY Reformulation Study				
	Designed by:	RWH	Checked by:	
	Drawn by:	RWH	Reviewed by:	
	Date:	Nov. 18, 2015	Submitted by:	
	Proj. Scale:	AS NOTED	Comm. No.:	XXXXX
DRAWING NO.				
RE-21				
SHEET 21 OF 95				

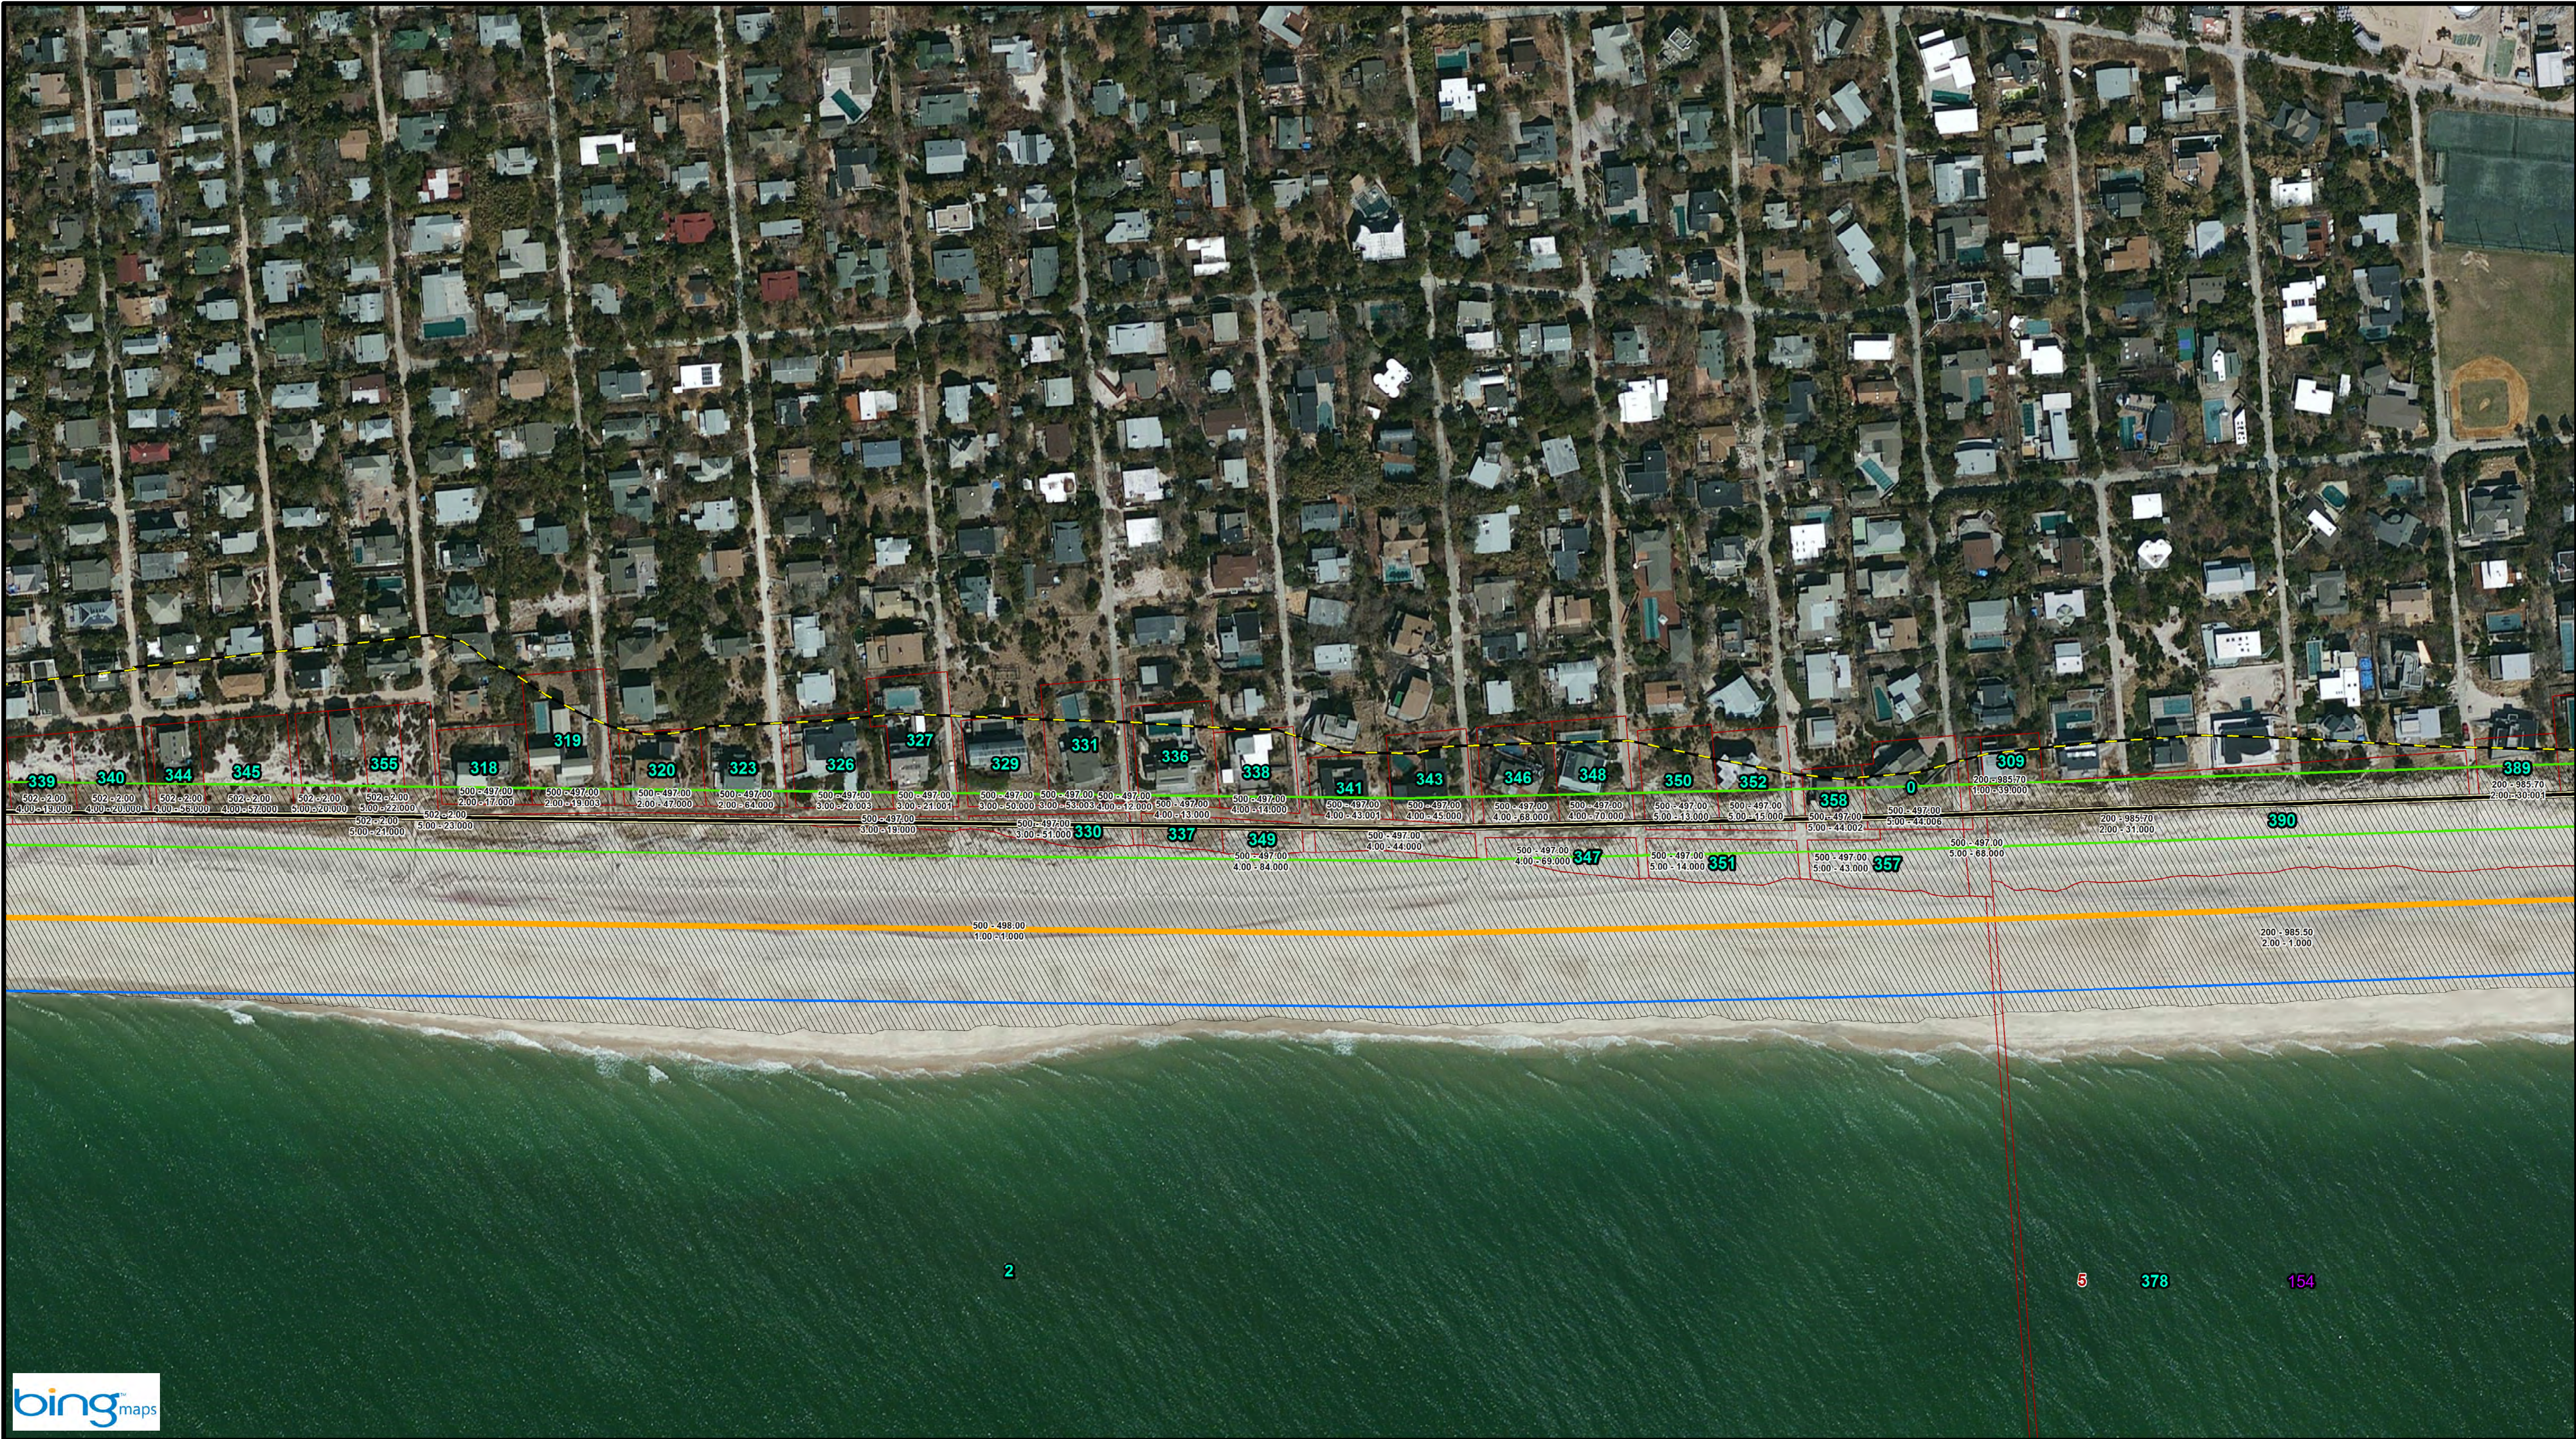


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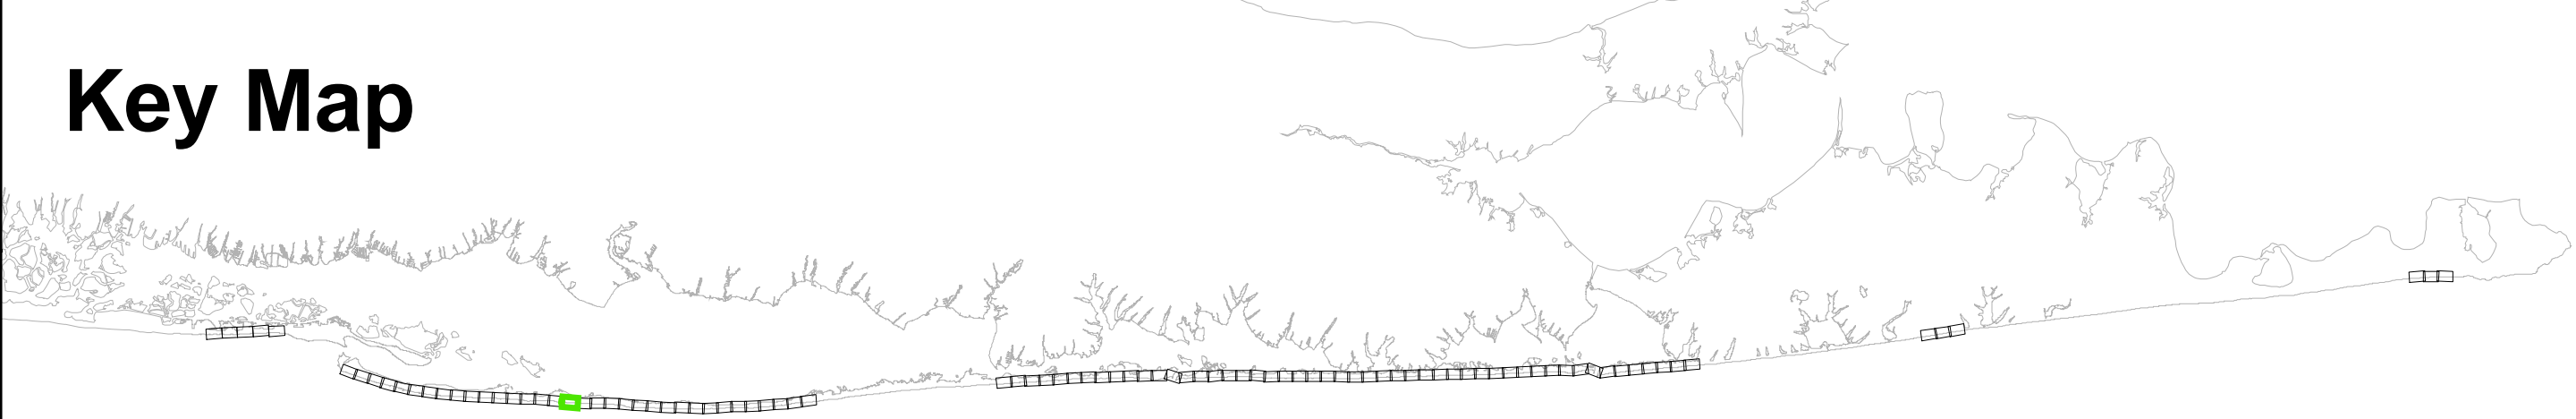
- Parcel data: District - Section
Block - Lot
- GRR Parcel Number: **11**
- FIMI Parcel Number: **11**
- Montauk Parcel Number: **11**
- Westhampton Parcel Number: **11**

Legend:


- CEHA
- MIDU_Baseline_20151022
- Parcels
- Easement Area
- Impacted Parcels
- GRR Plan Features
- Landward Toe of Dune
- Seaward Toe of Dune
- Seaward Berm Crest
- Design MHW (2 ft NGVD)
- Dune - 1st Construction
- Berm - 1st Construction

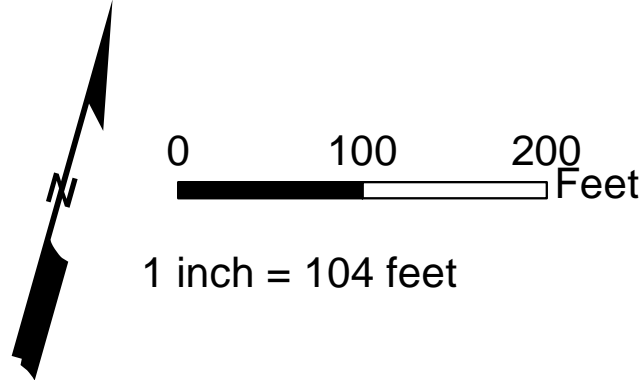

Key Map



SHEET 22 OF 95		DRAWING NO.		TITLE:		Reference Files:																																																																																																																																																																																																																																																																																																																																																																																																																																																																																																																																																																																																																																																																																																																																																																																																																																																																																																																																																																																																																																																																																																																																																																																					
RE-22		DRAFT		Fire IslandInlet to Montauk Point, NY Reformulation Study		Designed by: RWH		Checked by:																																																																																																																																																																																																																																																																																																																																																																																																																																																																																																																																																																																																																																																																																																																																																																																																																																																																																																																																																																																																																																																																																																																																																																																			

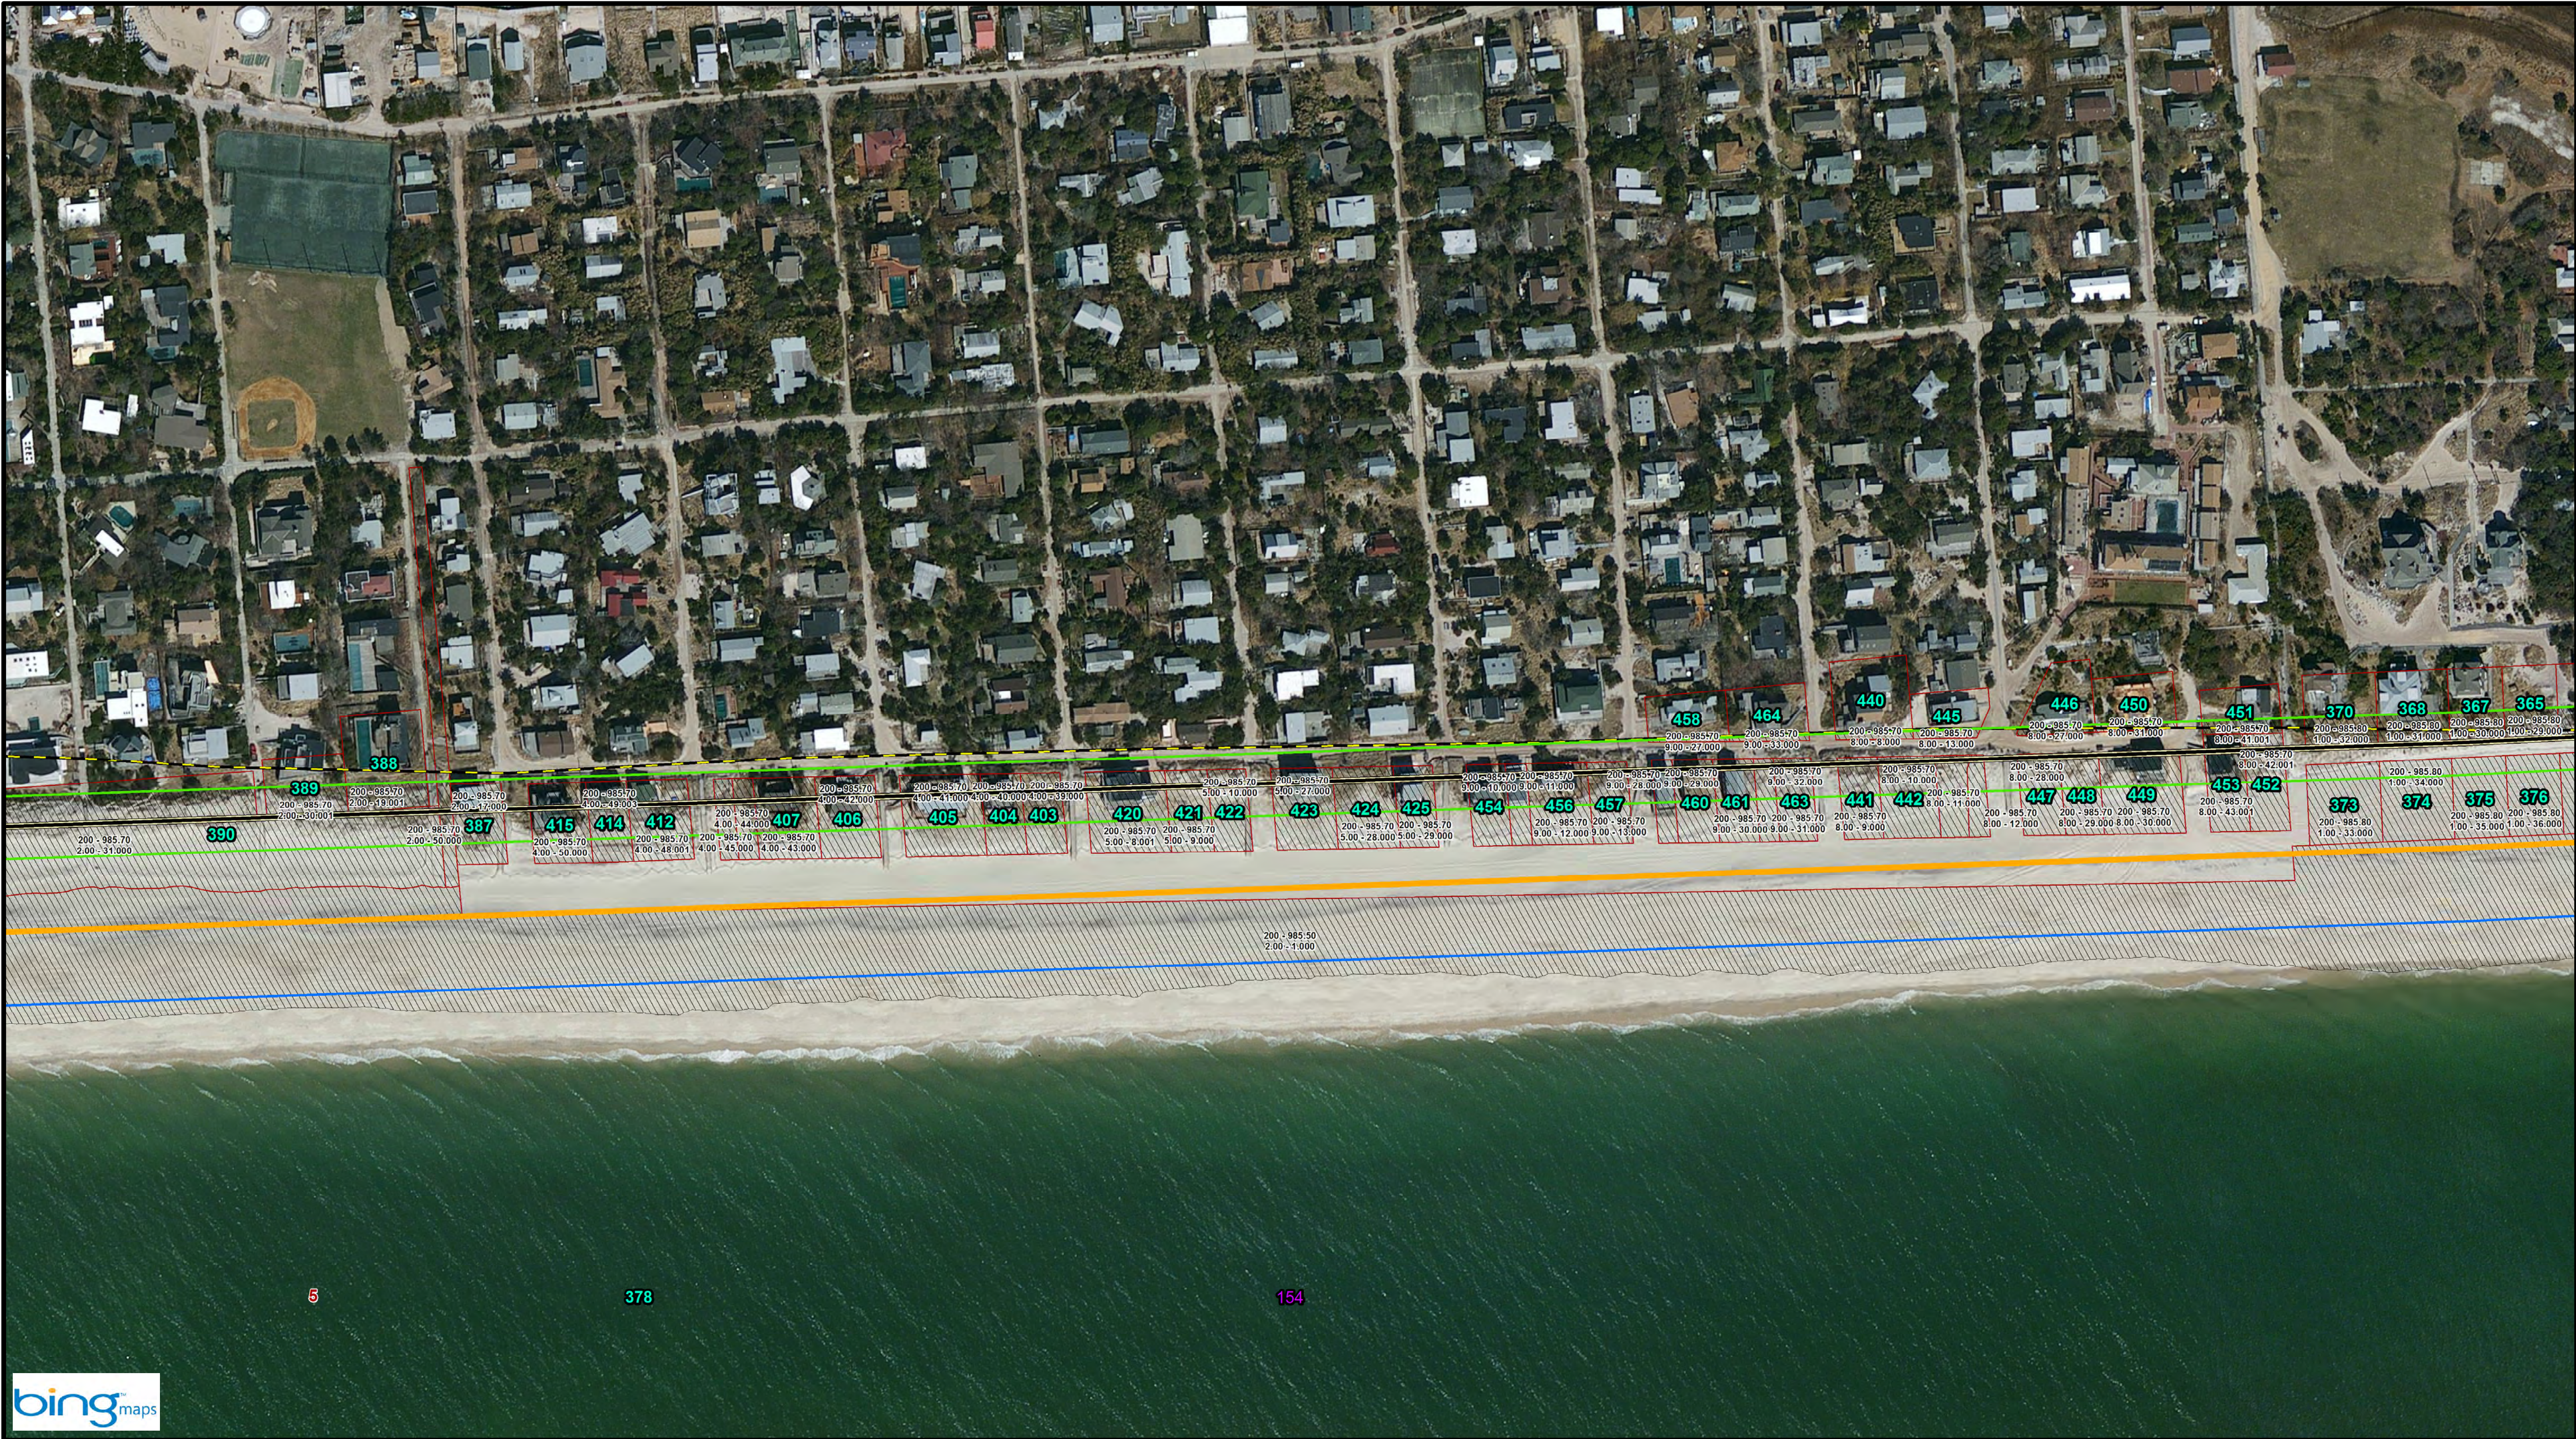


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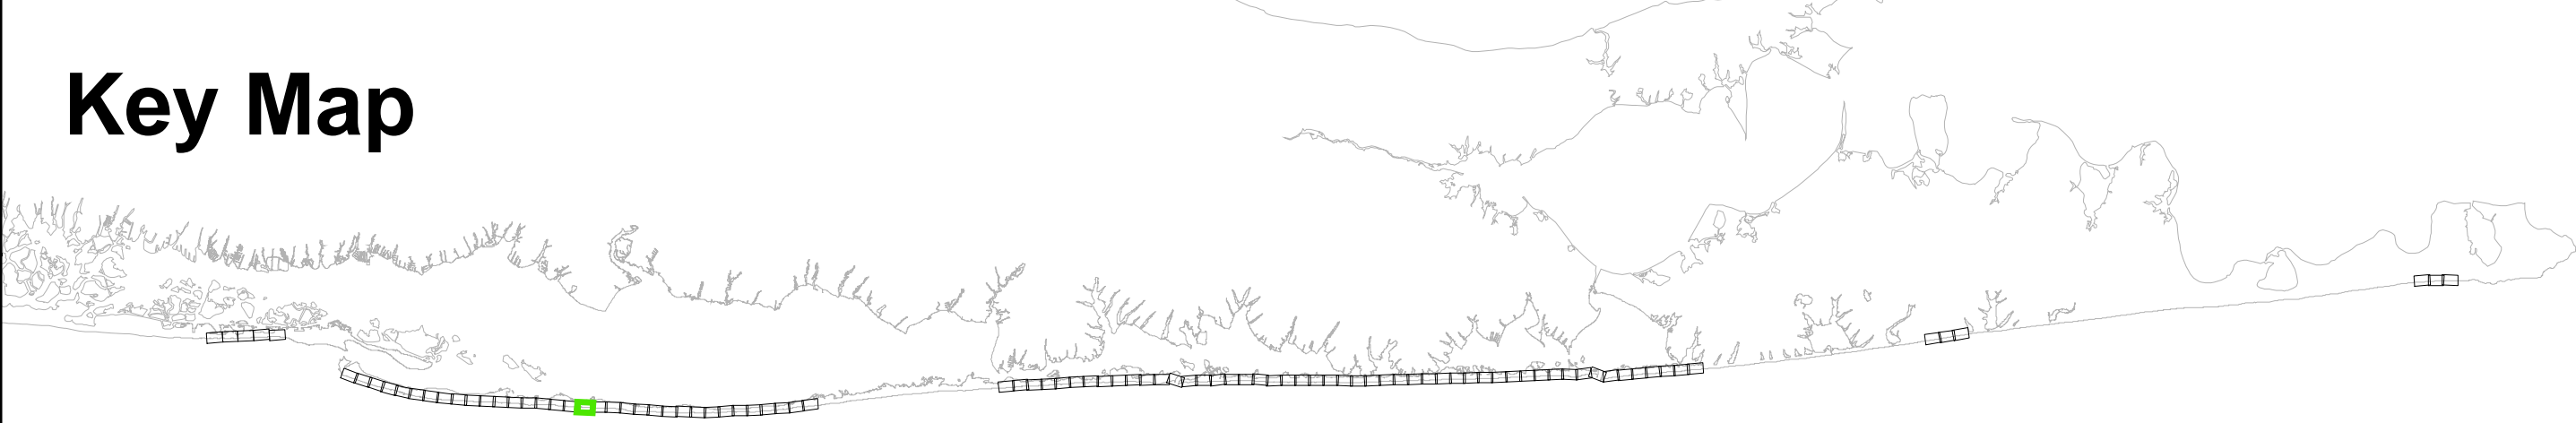
1. Parcel data: District - Section
Block - Lot
2. GRR Parcel Number: **11**
3. FIMI Parcel Number: **11**
4. Montauk Parcel Number: **11**
5. Westhampton Parcel Number: **11**

Legend:

- CEHA
- MIDU_Baseline_20151022
- Parcels
- Easement Area
- Impacted Parcels
- GRR Plan Features
- Landward Toe of Dune
- Seaward Toe of Dune
- Seaward Berm Crest
- Design MHW (2 ft NGVD)
- Dune - 1st Construction
- Berm - 1st Construction

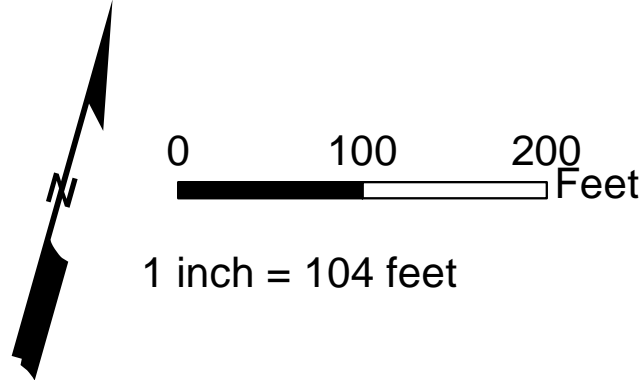

Key Map




SHEET 23 OF 95		DRAWING NO.		TITLE:		Reference Files:		Designed by: RWH		Checked by:			
RE-23				DRAFT		Fire Island Inlet to Montauk Point, NY Reformulation Study		Drawn by: RWH		Reviewed by:			
								Date: Nov 18, 2015		Submitted by:			
								Plot Scale: AS NOTED		Comm. No.:			
										XXXXX		No. Date	




- Notes:**
- Parcel data: District - Section
Block - Lot
 - GRR Parcel Number: **11**
 - FIMI Parcel Number: **11**
 - Montauk Parcel Number: **11**
 - Westhampton Parcel Number: **11**

- Legend:**
- CEHA
 - MIDU_Baseline_20151022
 - Parcels
 - Easement Area
 - Impacted Parcels
 - GRR Plan Features
 - Landward Toe of Dune
 - Seaward Toe of Dune
 - Seaward Berm Crest
 - Design MHW (2 ft NGVD)
 - Dune - 1st Construction
 - Berm - 1st Construction

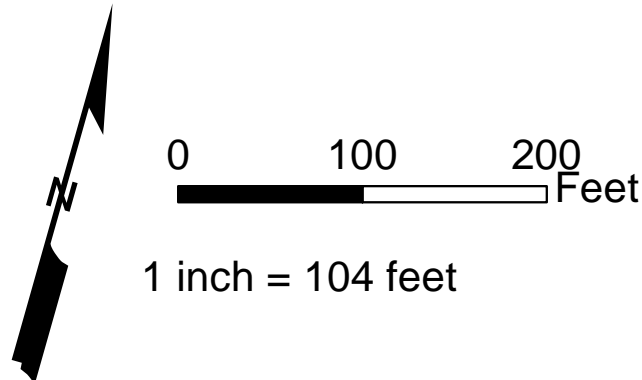

Key Map

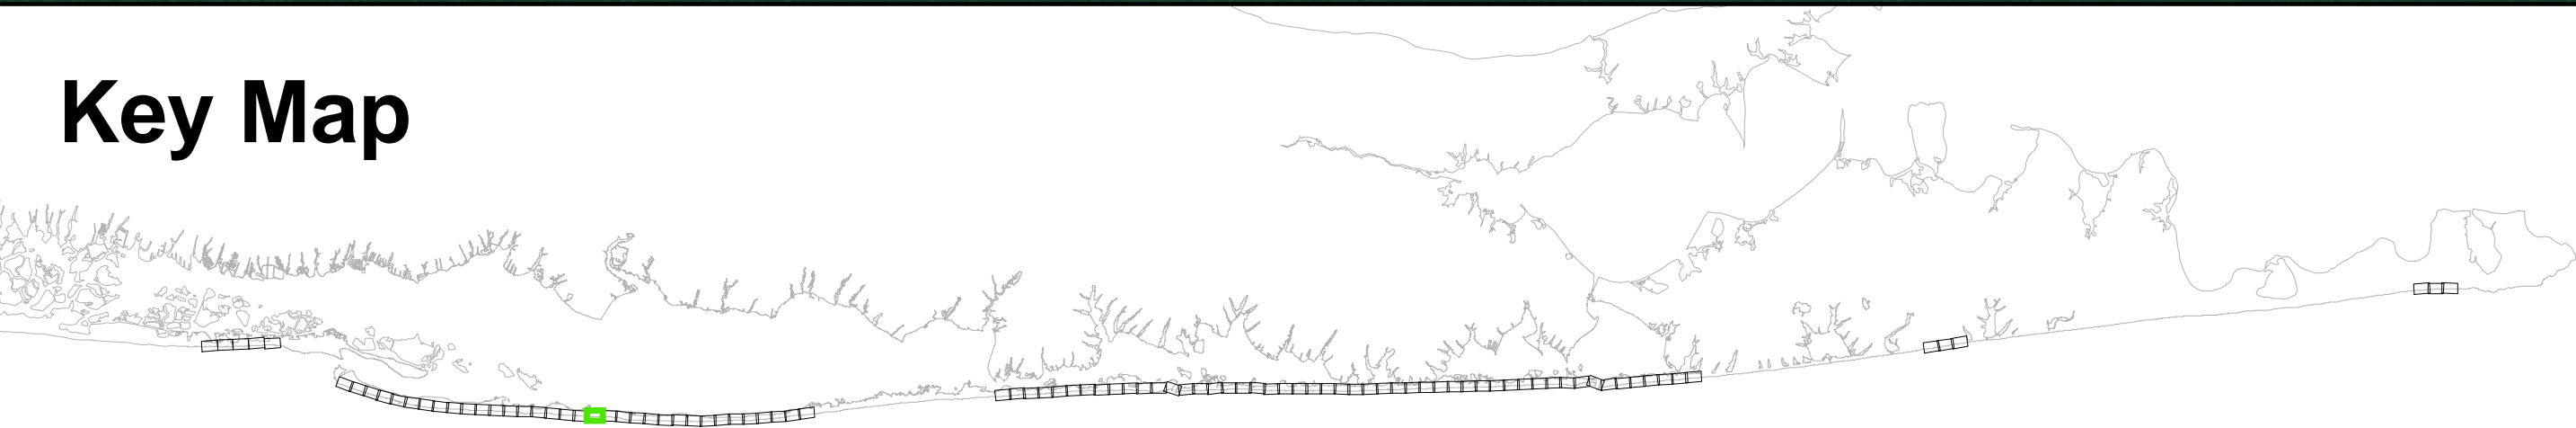

TITLE:		DRAFT		Fire Island Inlet to Montauk Point, NY Reformulation Study	
DRAWING NO.		RE-24		SHEET 24 OF 95	
Reference Files:		Designed by: RWH		Checked by:	
Drawn by: RWH		Reviewed by:		Submitted by:	
Date: Nov. 18, 2015		Date:		Comm. No.:	
Proj. Scale: N/A NOTED		Proj. Scale:		Comm. No.:	
P/S NOTED		P/S NOTED		Comm. No.:	
XXXXX		XXXXX		XXXXX	




Notes:

1. Parcel data: District - Section
Block - Lot
2. GRR Parcel Number: 11
3. FIMI Parcel Number: 11
4. Montauk Parcel Number: 11
5. Westhampton Parcel Number: 11

Legend:

- CEHA
- MIDU_Baseline_20151022
- Parcels
- Easement Area
- Impacted Parcels
- GRR Plan Features
- Landward Toe of Dune
- Seaward Toe of Dune
- Seaward Berm Crest
- Design MHW (2 ft NGVD)
- Dune - 1st Construction
- Berm - 1st Construction

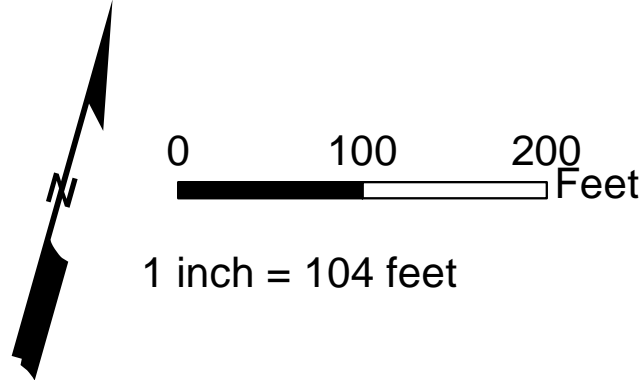

Key Map



TITLE:		DRAFT		Fire Island Inlet to Montauk Point, NY Reformulation Study		DRAWING NO.	
RE-26		SHEET 26 OF 95					
Reference Files:		Designed by: RWH		Checked by:			
		Drawn by: RWH		Reviewed by:			
		Date: Nov. 18, 2015		Submitted by:			
		Comm. No.:		Comm.			
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		AS NOTED					




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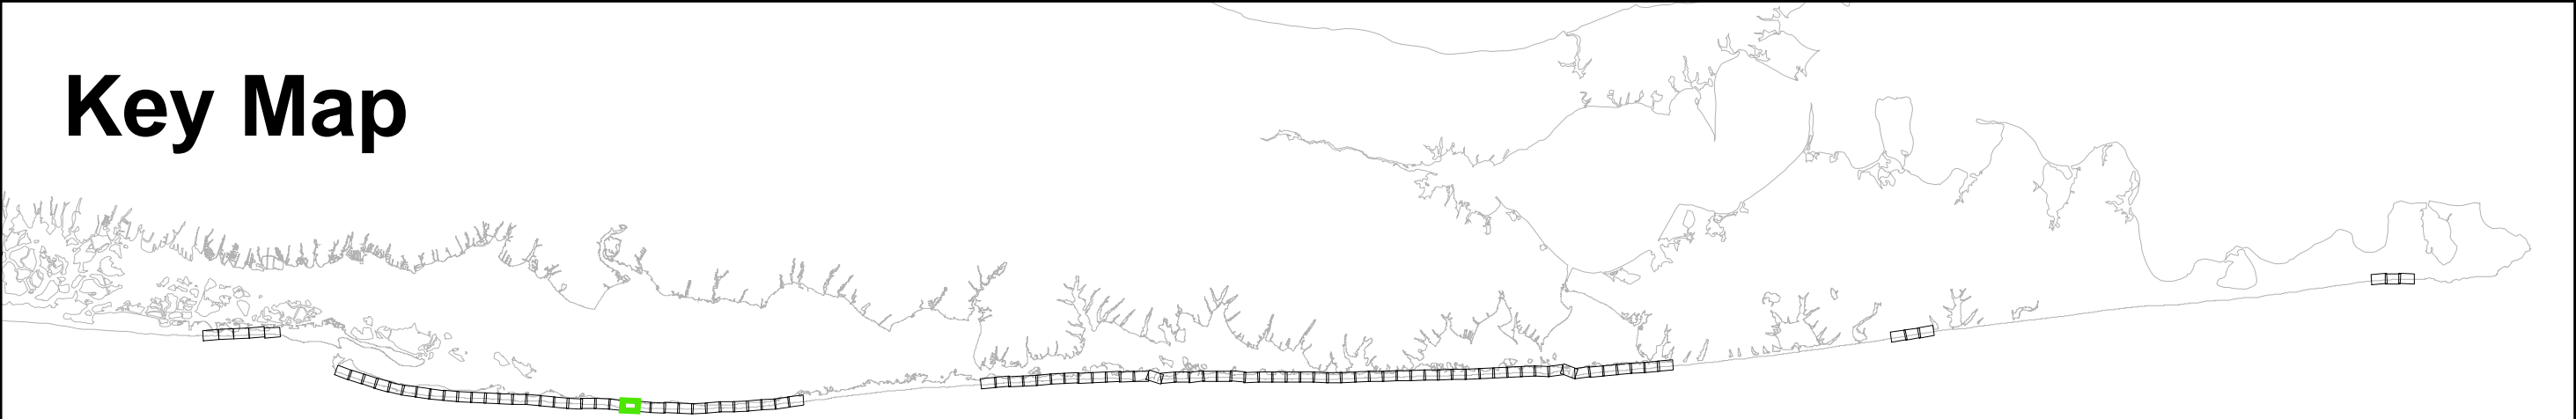
- Parcel data: District - Section
Block - Lot
- GRR Parcel Number: **11**
- FIMI Parcel Number: **11**
- Montauk Parcel Number: **11**
- Westhampton Parcel Number: **11**

Legend:


- | | |
|------------------------|-------------------------|
| CEHA | Landward Toe of Dune |
| MIDU_Baseline_20151022 | Seaward Toe of Dune |
| Parcels | Seaward Berm Crest |
| Easement Area | Design MHW (2 ft NGVD) |
| Impacted Parcels | Dune - 1st Construction |
| | Berm - 1st Construction |

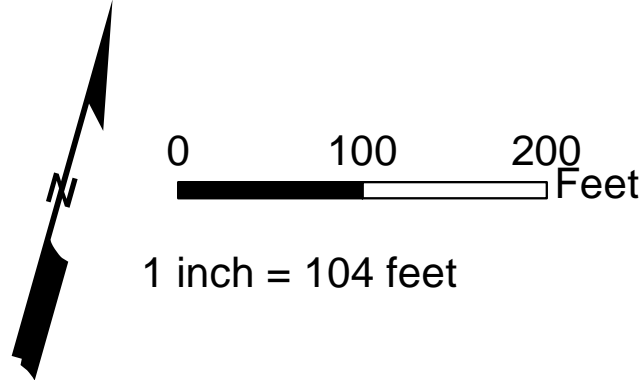

Key Map



DRAFT				Fire Island Inlet to Montauk Point, NY Reformulation Study			
TITLE:				DRAWING NO.			
RE-27				SHEET 27 OF 95			
Reference Files:				Designed by: RWH			
Checked by:				Drawn by: RWH			
Reviewed by:				Date: Nov. 18, 2015			
Submitted by:				Proj. Scale: AS NOTED			
Comm. No.: XXXXX				No. 100			

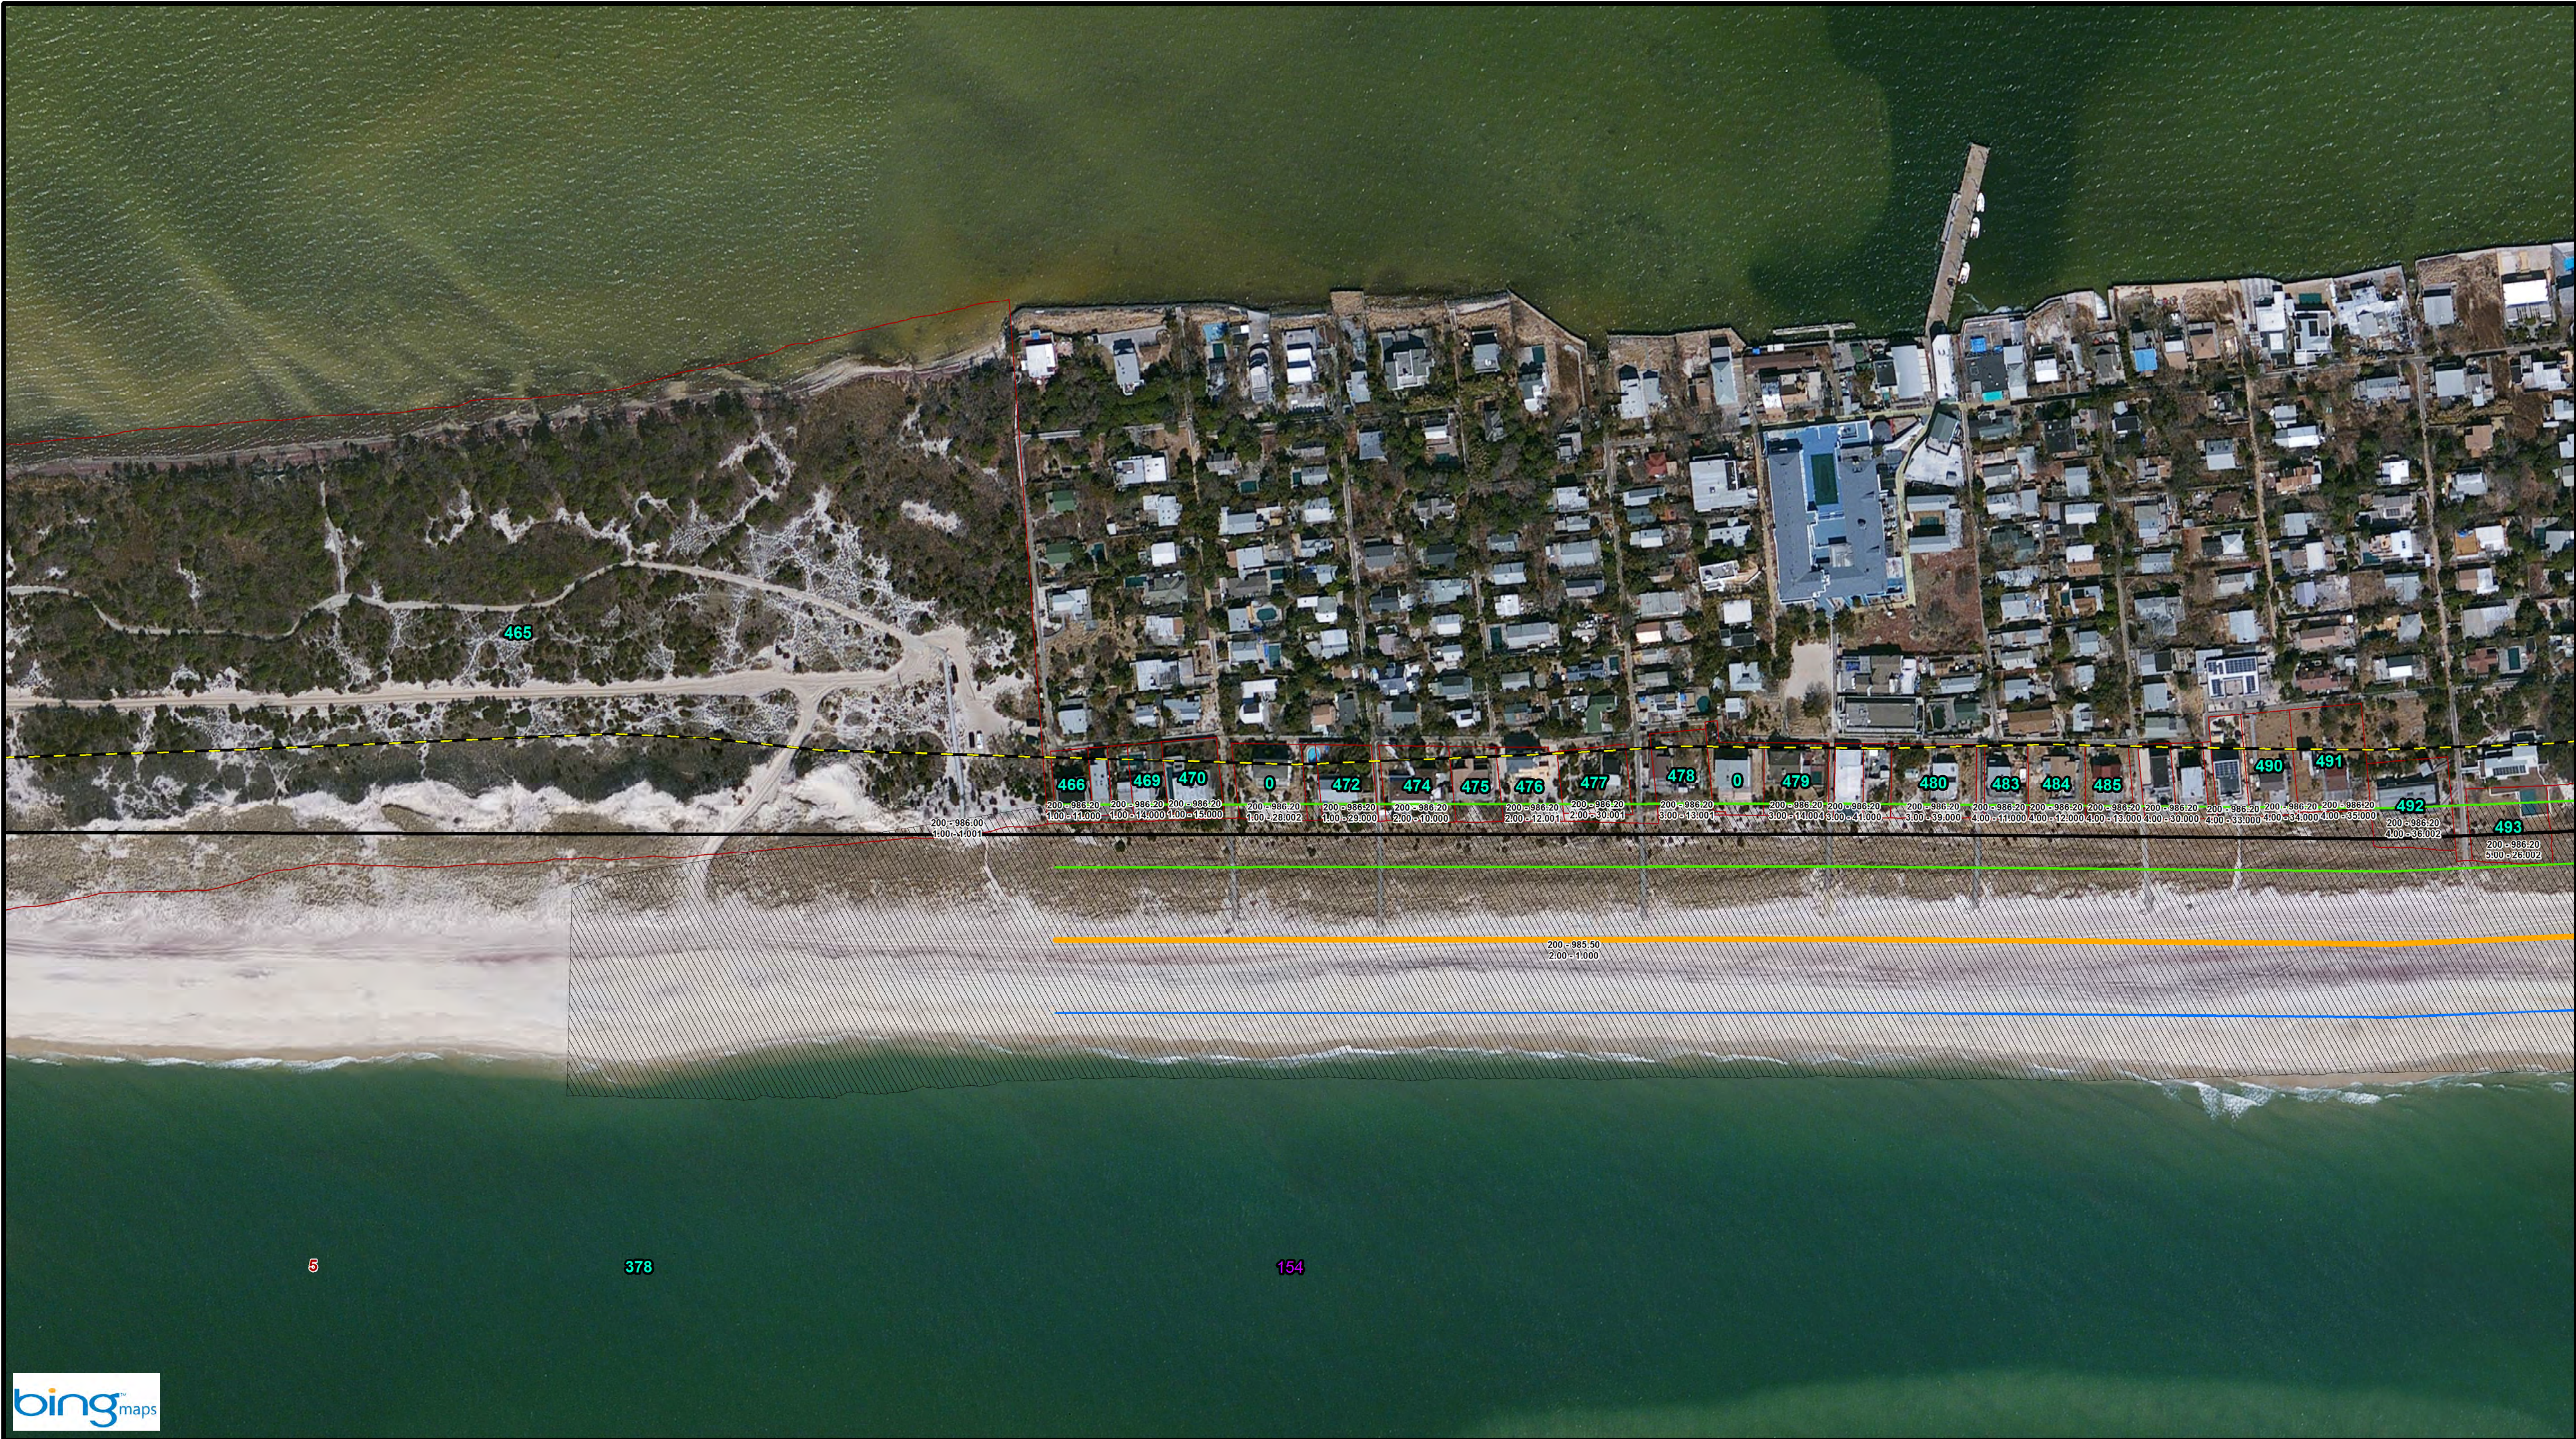


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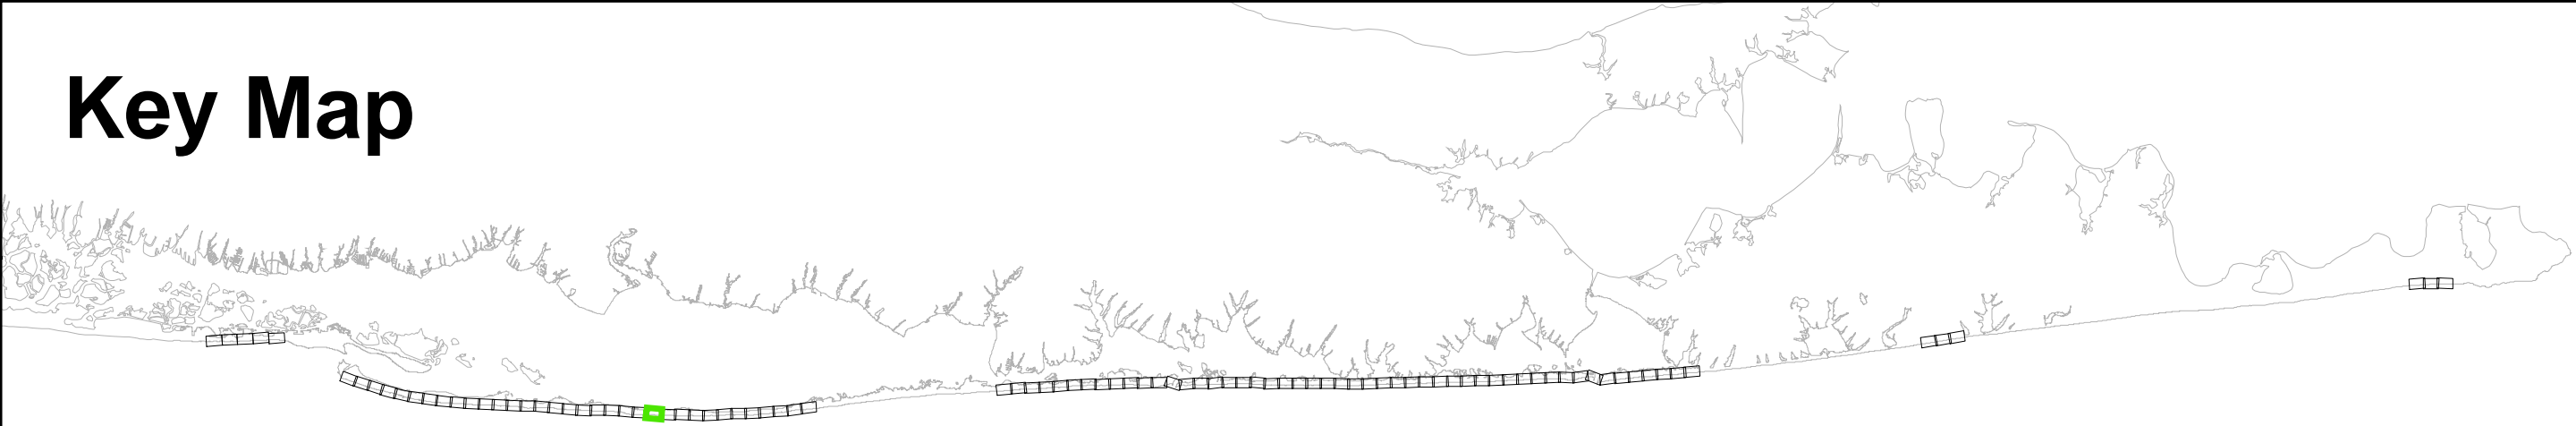
1. Parcel data: District - Section
Block - Lot
2. GRR Parcel Number: **11**
3. FIMI Parcel Number: **11**
4. Montauk Parcel Number: **11**
5. Westhampton Parcel Number: **11**

Legend:


- CEHA
- MIDU_Baseline_20151022
- Parcels
- Easement Area
- Impacted Parcels
- GRR Plan Features
- Landward Toe of Dune
- Seaward Toe of Dune
- Seaward Berm Crest
- Design MHW (2 ft NGVD)
- Dune - 1st Construction
- Berm - 1st Construction

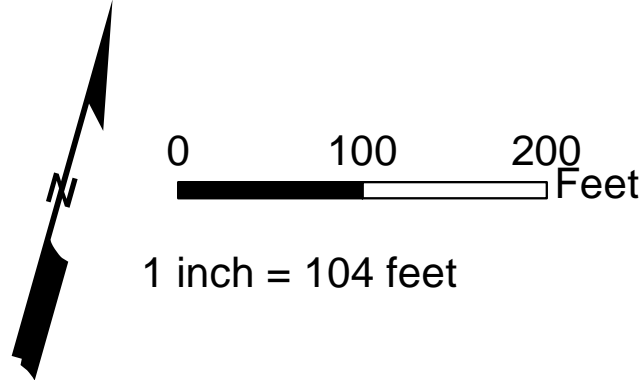

Key Map




TITLE: DRAFT Fire Island Inlet to Montauk Point, NY Reformulation Study			
DRAWING NO. RE-28			
SHEET 28 OF 95			
Reference Files:	Designed by: RW	Checked by: RW	
	Drawn by: RW	Reviewed by:	
	Date: Nov. 18, 2015	Submitted by:	
	Proj. Scale: AS NOTED	Comm. No.:	XXXX
		No.	001

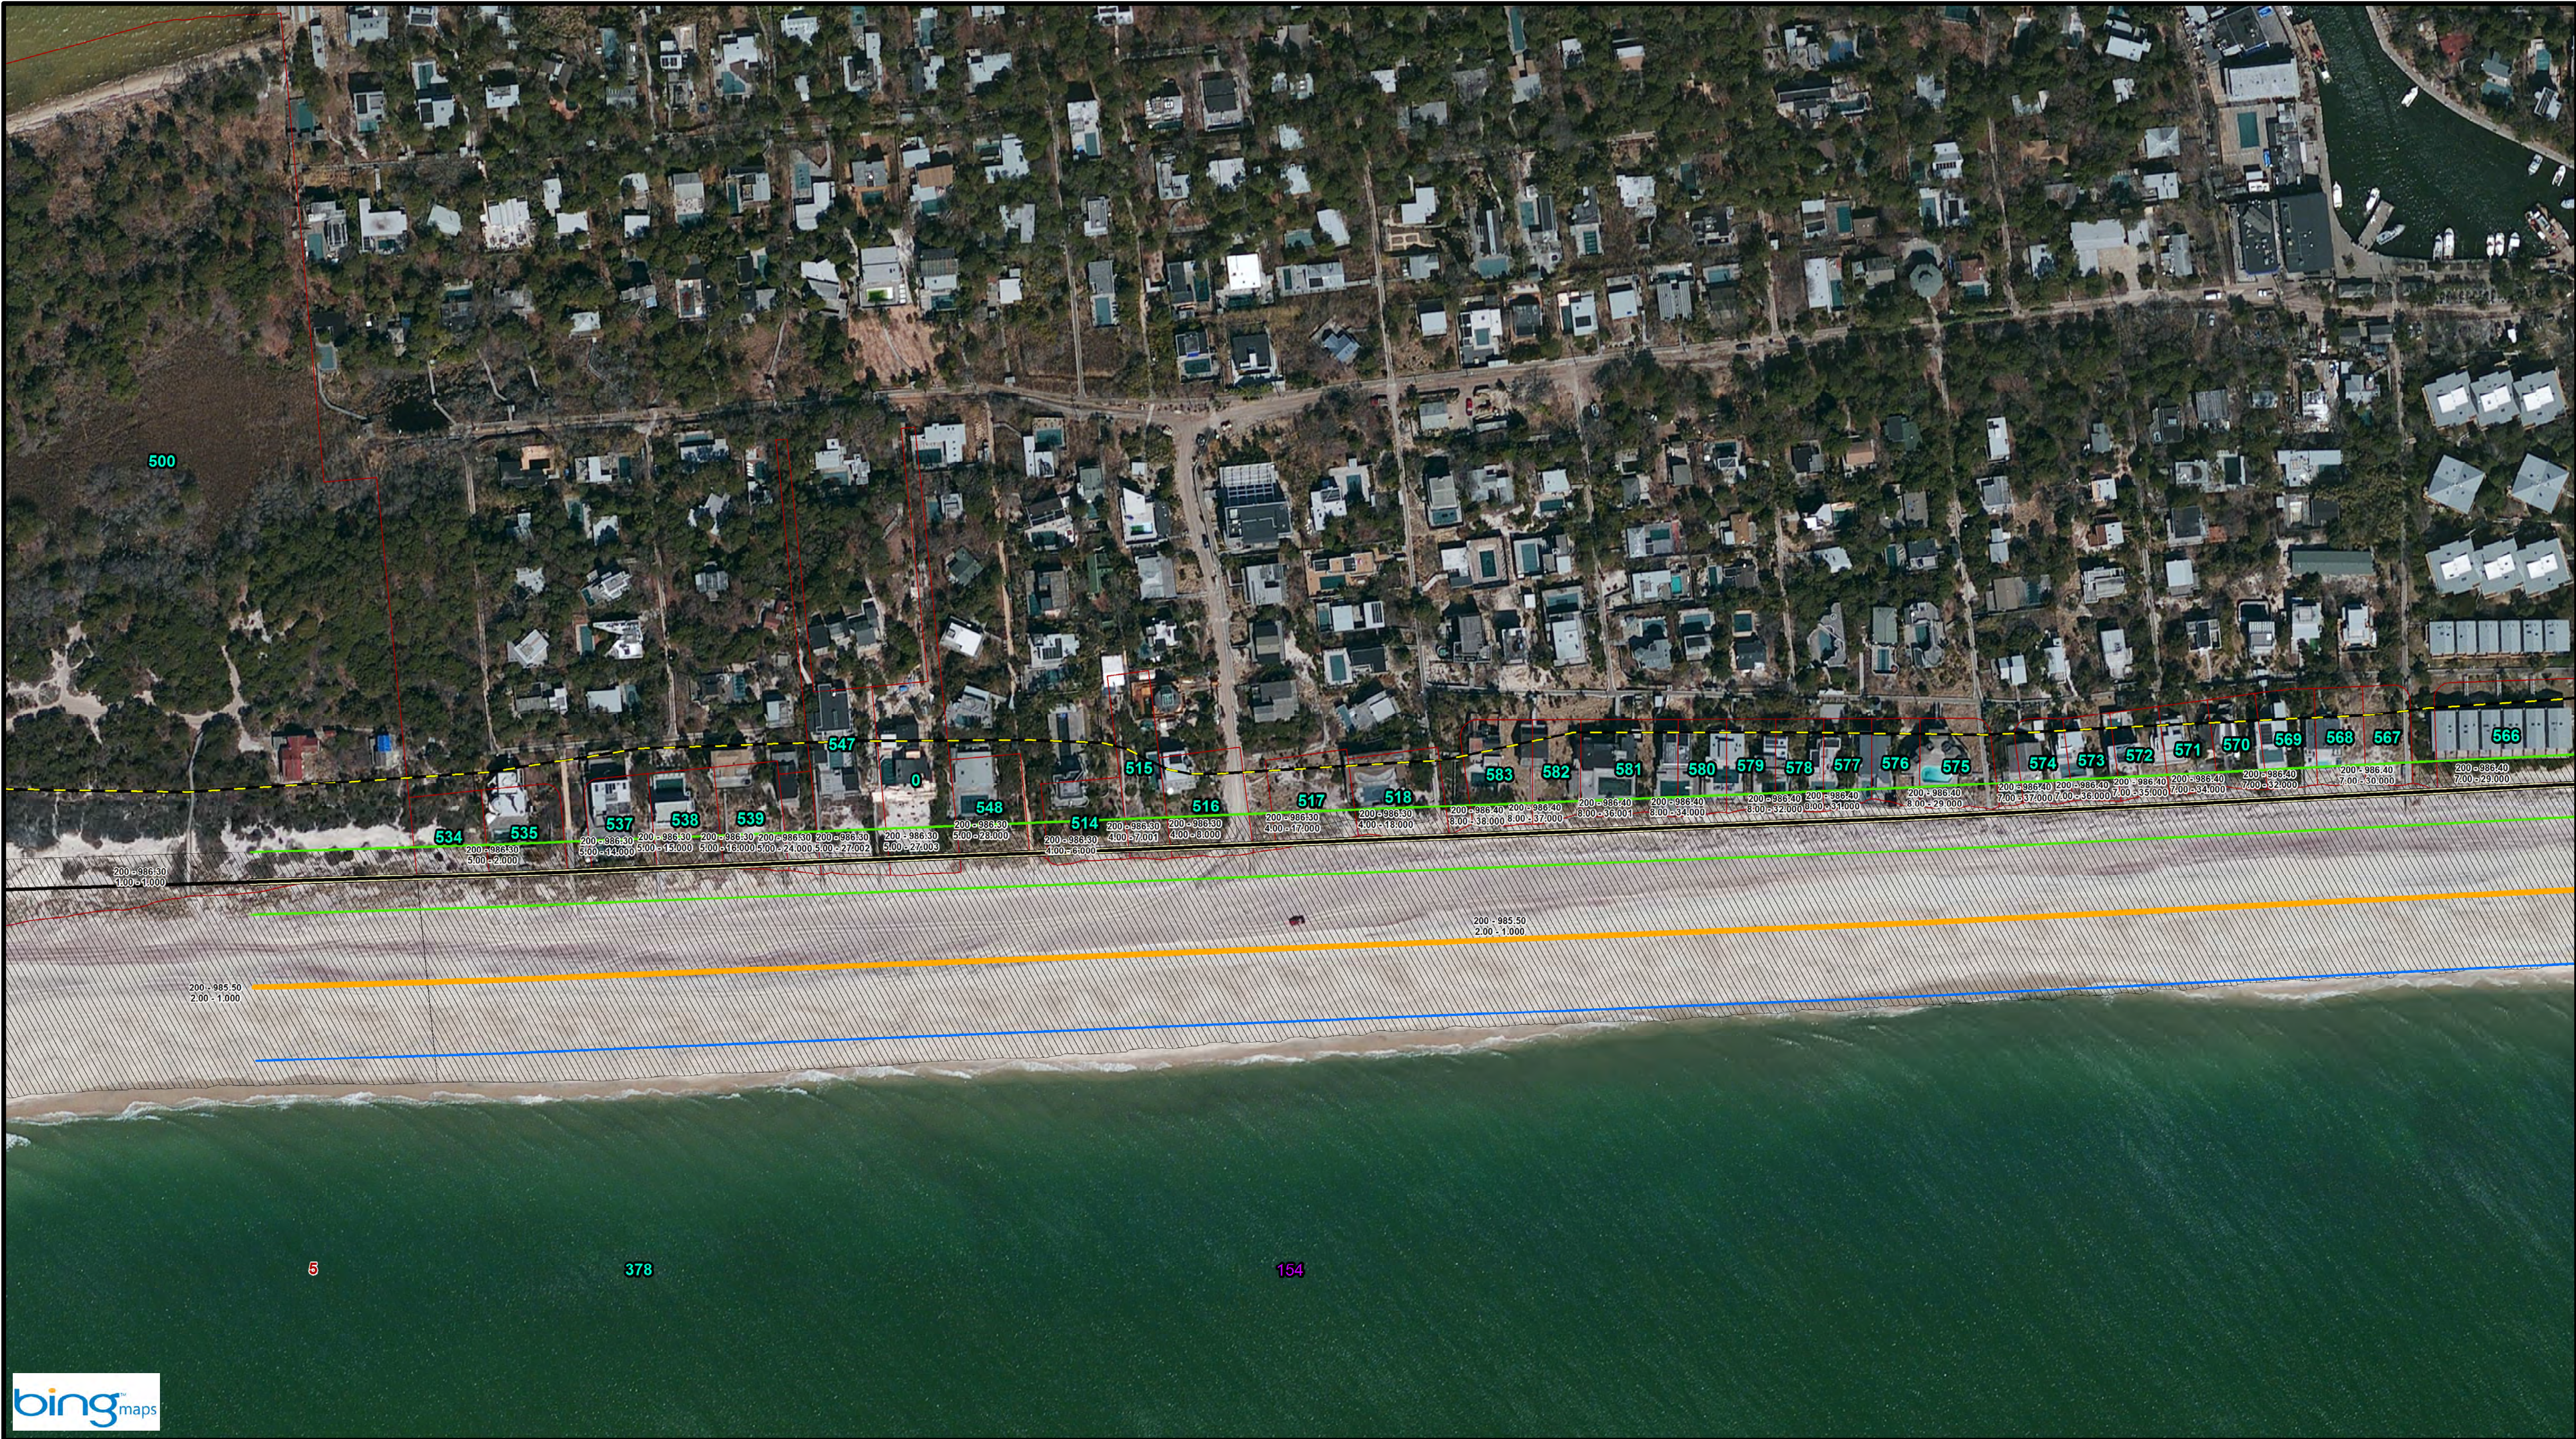

- Notes:**
- Parcel data: District - Section
Block - Lot
 - GRR Parcel Number: **11**
 - FIMI Parcel Number: **11**
 - Montauk Parcel Number: **11**
 - Westhampton Parcel Number: **11**


- Legend:**
- CEHA
 - MIDU_Baseline_20151022
 - Parcels
 - Easement Area
 - Impacted Parcels
 - GRR Plan Features
 - Landward Toe of Dune
 - Seaward Toe of Dune
 - Seaward Berm Crest
 - Design MHW (2 ft NGVD)
 - Dune - 1st Construction
 - Berm - 1st Construction

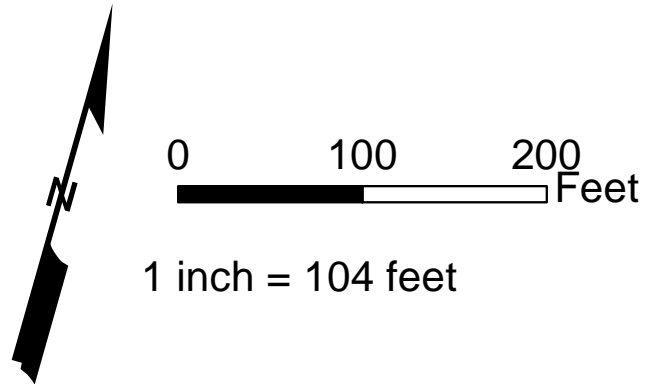

Key Map




SHEET 30 OF 95		DRAWING NO.		TITLE:		Reference Files:		Designed by: RWH		Checked by:			
RE-30				DRAFT		Fire Island Inlet to Montauk Point, NY Reformulation Study		Drawn by: RWH		Reviewed by:			
								Date: Nov 18, 2015		Submitted by:			
								Plot Scale: AS NOTED		Comm. No.:			
										XXXXX		No. Date	

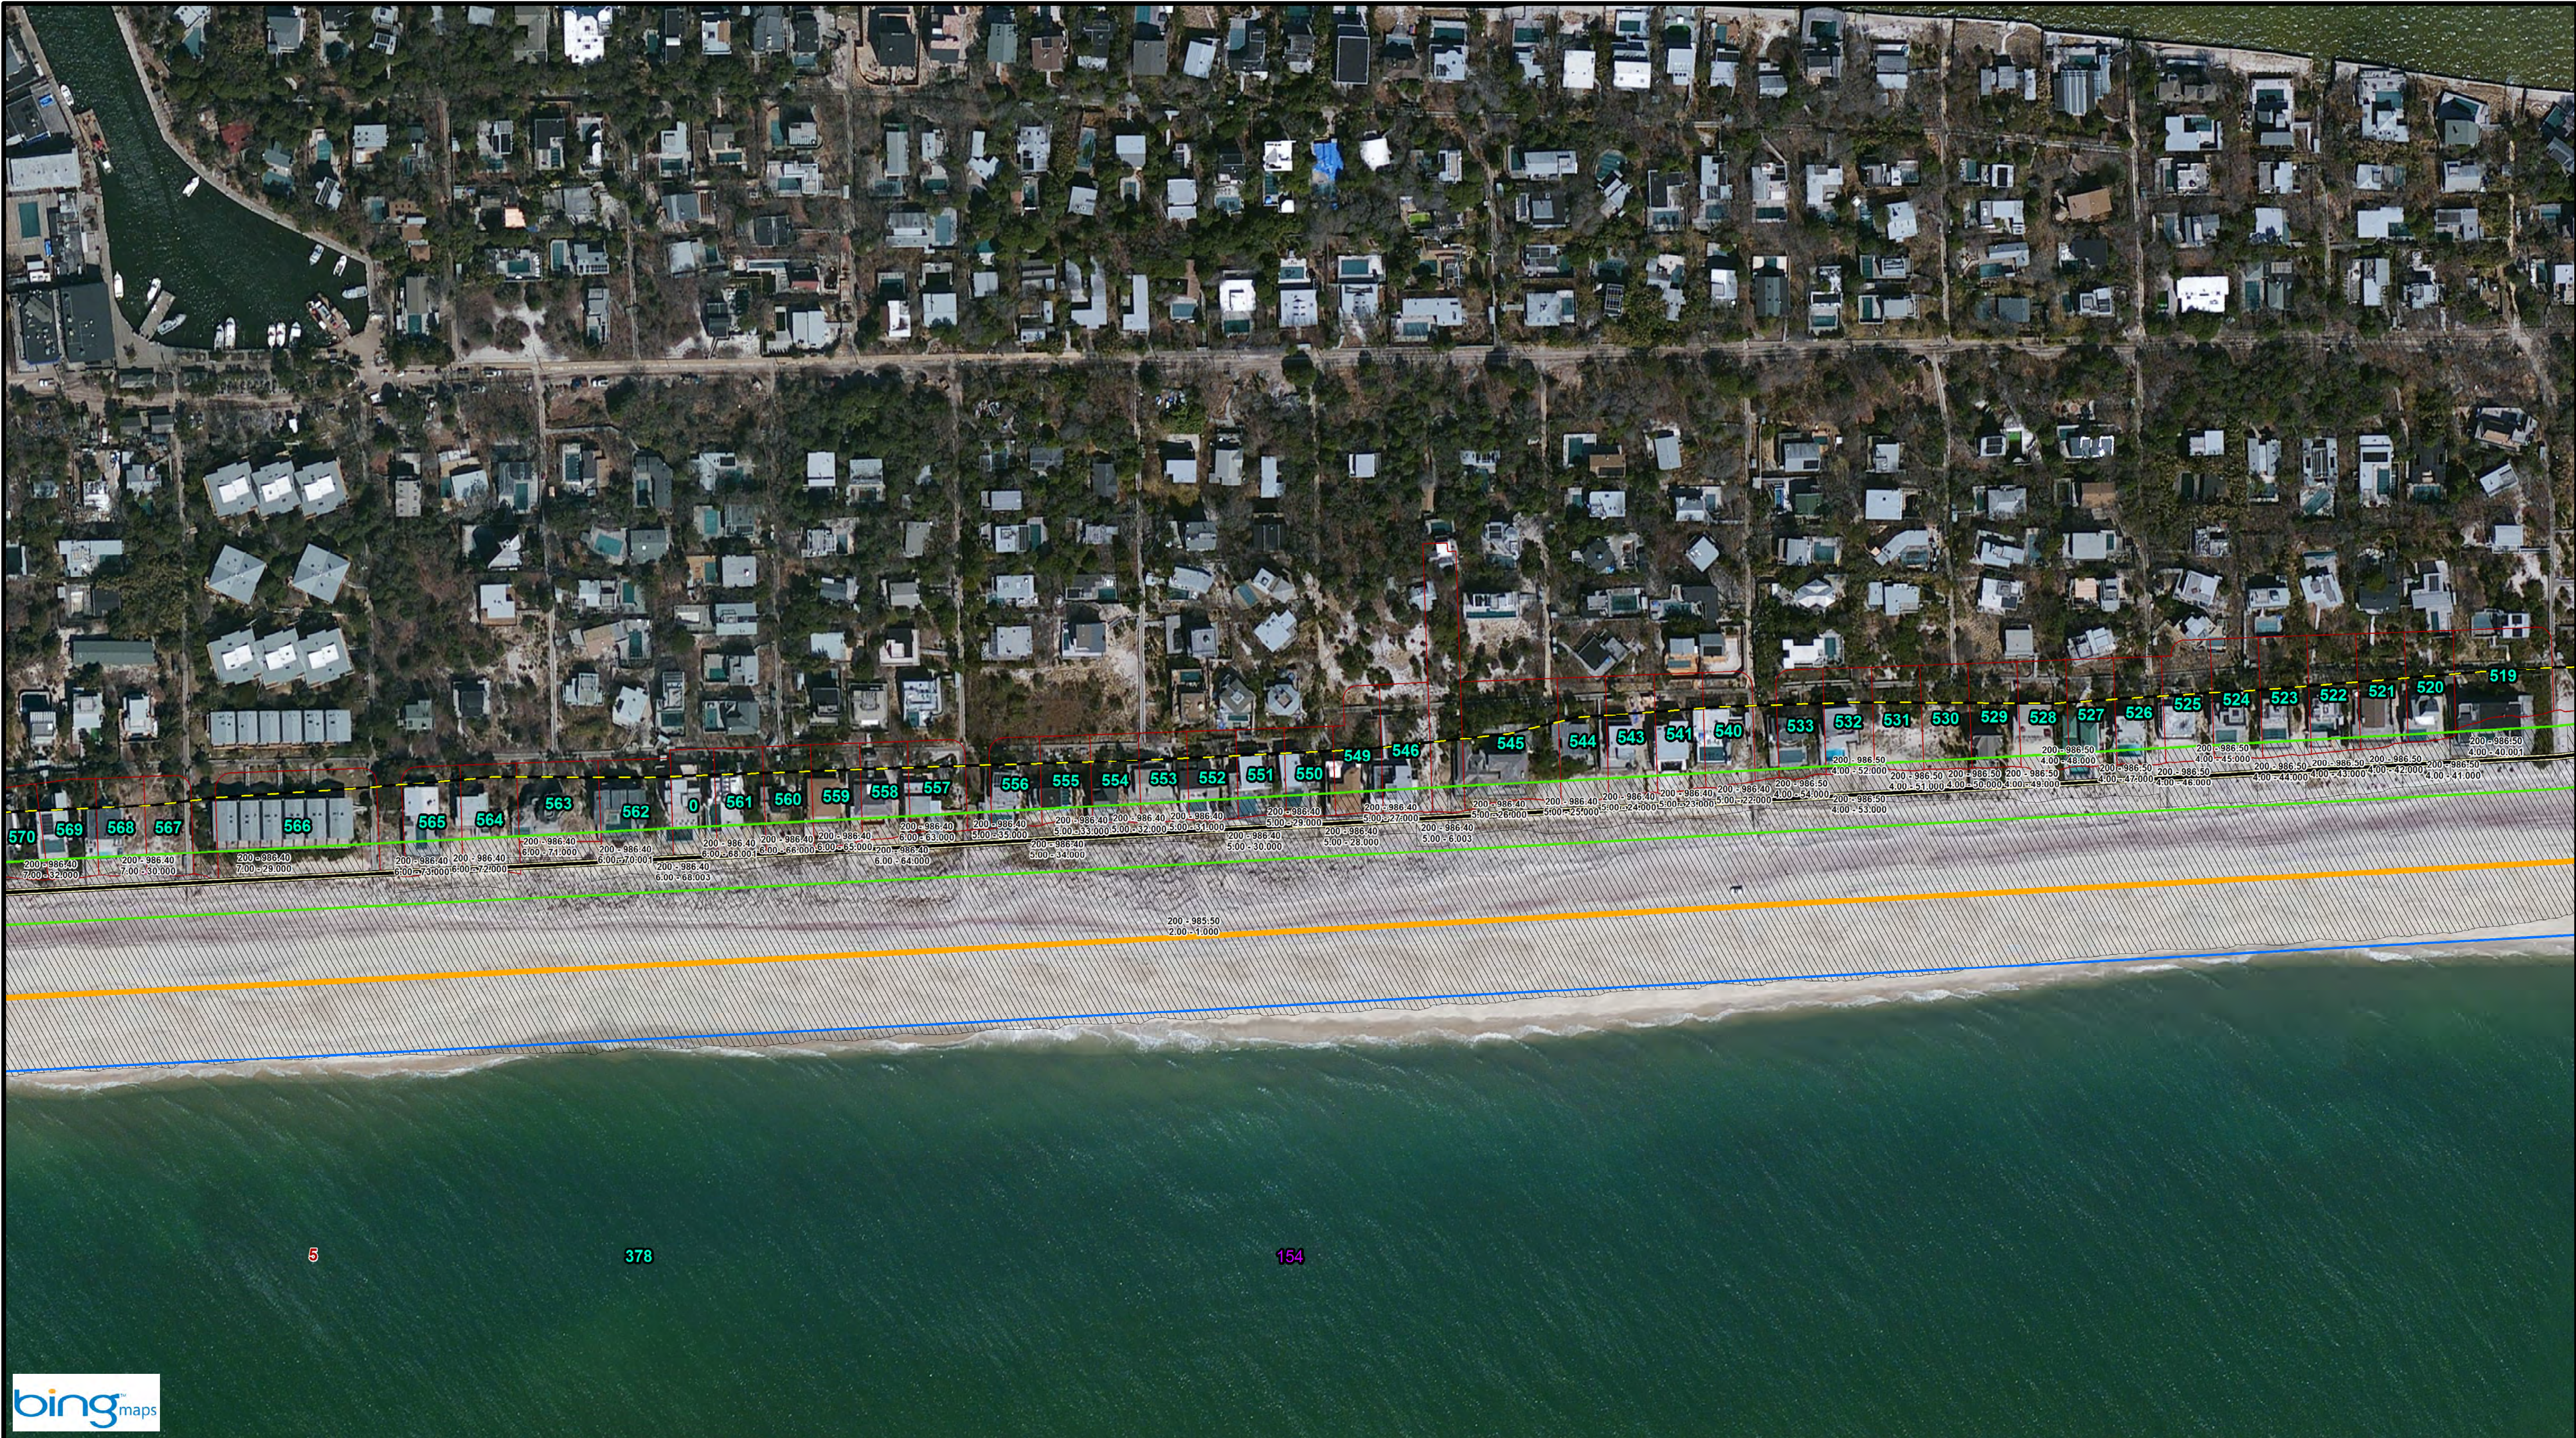


- Notes:**
1. Parcel data: District - Section
Block - Lot
 2. GRR Parcel Number: 11
 3. FIMI Parcel Number: 11
 4. Montauk Parcel Number: 11
 5. Westhampton Parcel Number: 11


- Legend:**
- CEHA
 - MIDU_Baseline_20151022
 - Parcels
 - Easement Area
 - Impacted Parcels
 - GRR Plan Features
 - Landward Toe of Dune
 - Seaward Toe of Dune
 - Seaward Berm Crest
 - Design MHW (2 ft NGVD)
 - Dune - 1st Construction
 - Berm - 1st Construction

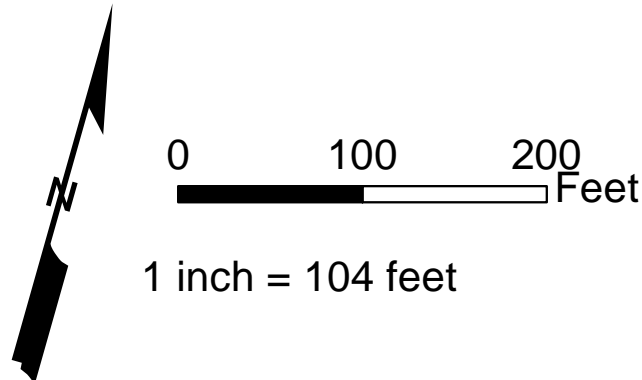

Key Map

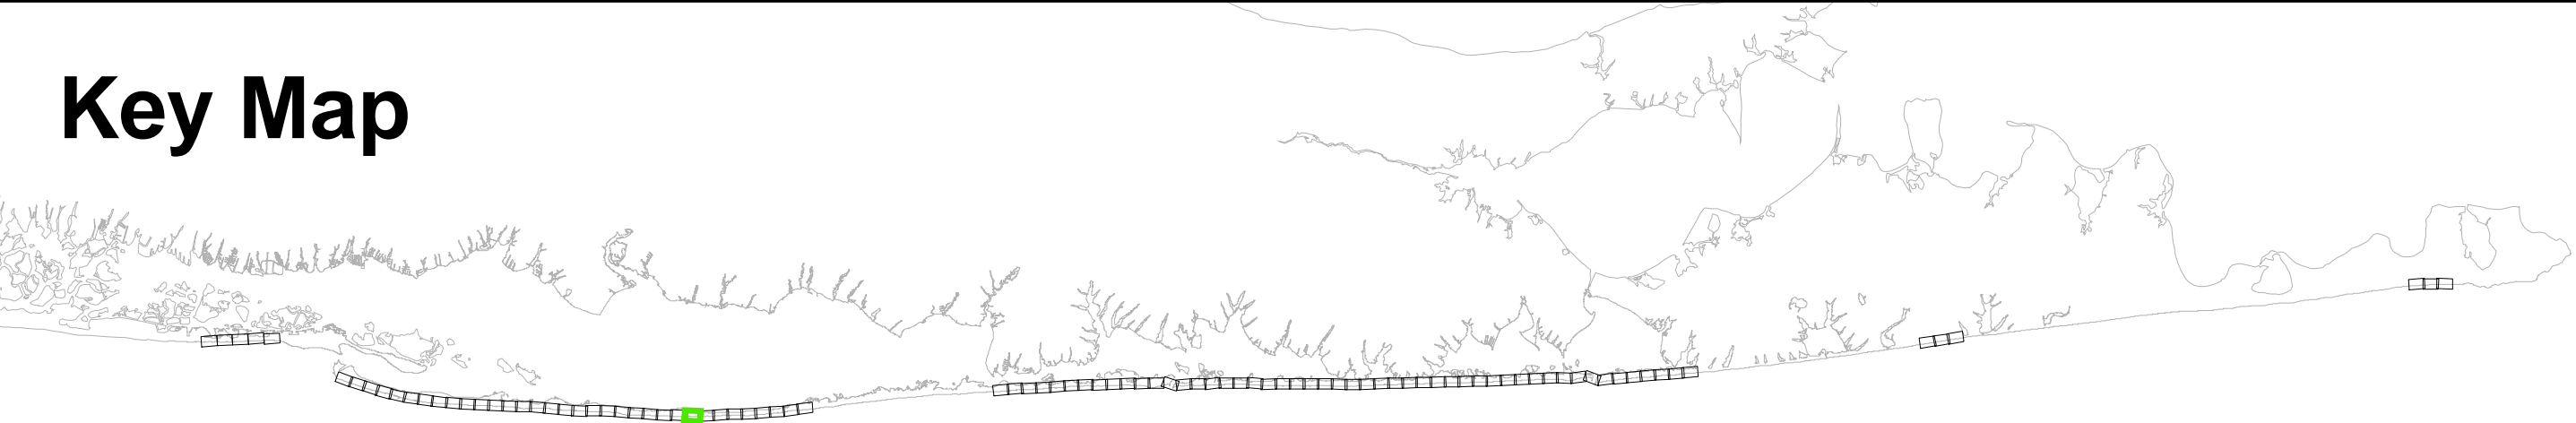


DRAWING NO.		TITLE:		Reference Files:		Designed by:		Checked by:			
RE-31		DRAFT		Fire IslandInlet to Montauk Point, NY Reformulation Study		RW H					
						Drawn by:		Reviewed by:			
						Date:		Submitted by:			
						Nov 18, 2015					
						Comm.		No. :			
Proj Scale:		AS NOTED		XXXXX		No.		Date			
SHEET 31 OF 95											

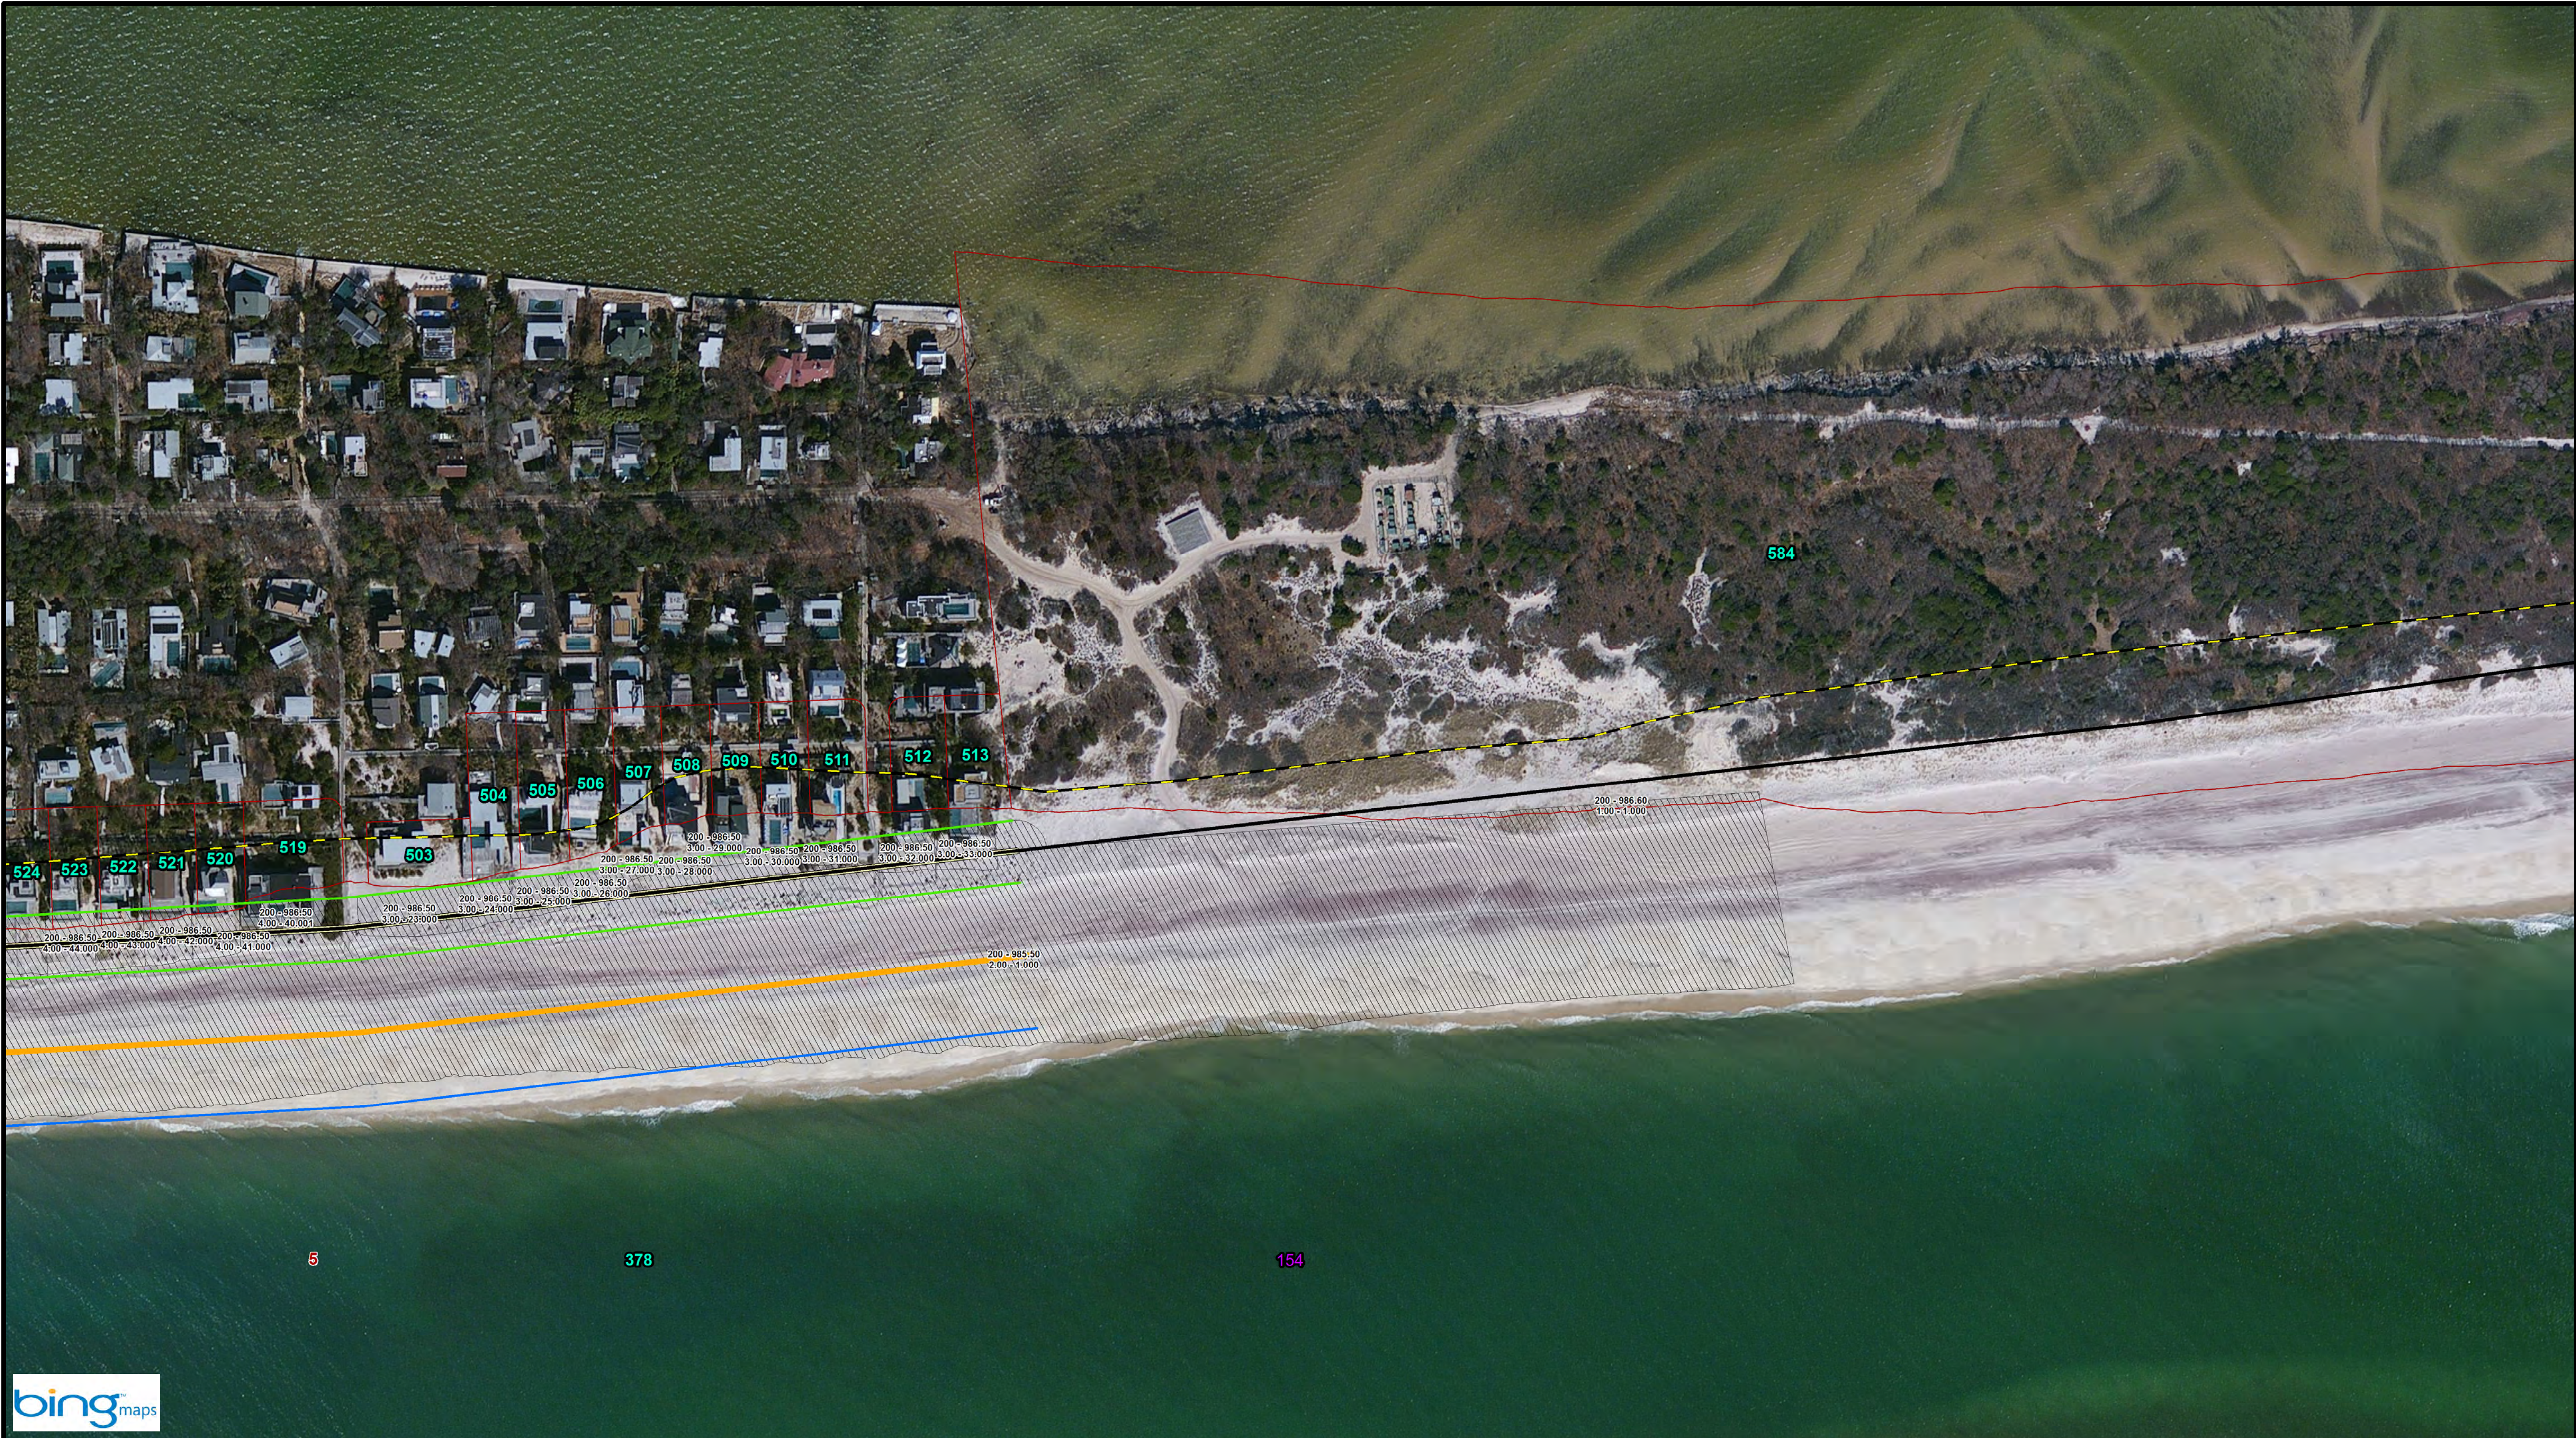


- Notes:**
- Parcel data: District - Section
Block - Lot
 - GRR Parcel Number: 11
 - FIMI Parcel Number: 11
 - Montauk Parcel Number: 11
 - Westhampton Parcel Number: 11

- Legend:**
- CEHA
 - MIDU_Baseline_20151022
 - Parcels
 - Easement Area
 - Impacted Parcels
 - GRR Plan Features
 - Landward Toe of Dune
 - Seaward Toe of Dune
 - Seaward Berm Crest
 - Design MHW (2 ft NGVD)
 - Dune - 1st Construction
 - Berm - 1st Construction

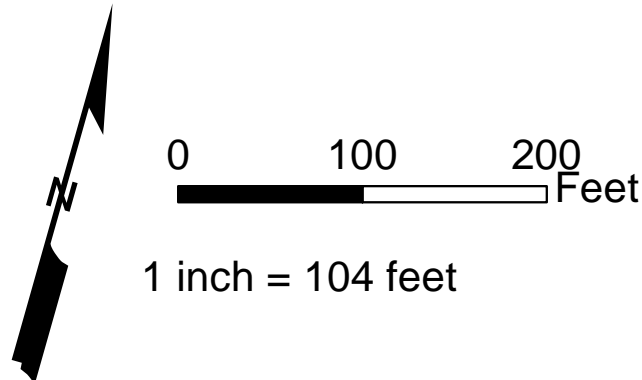

Key Map

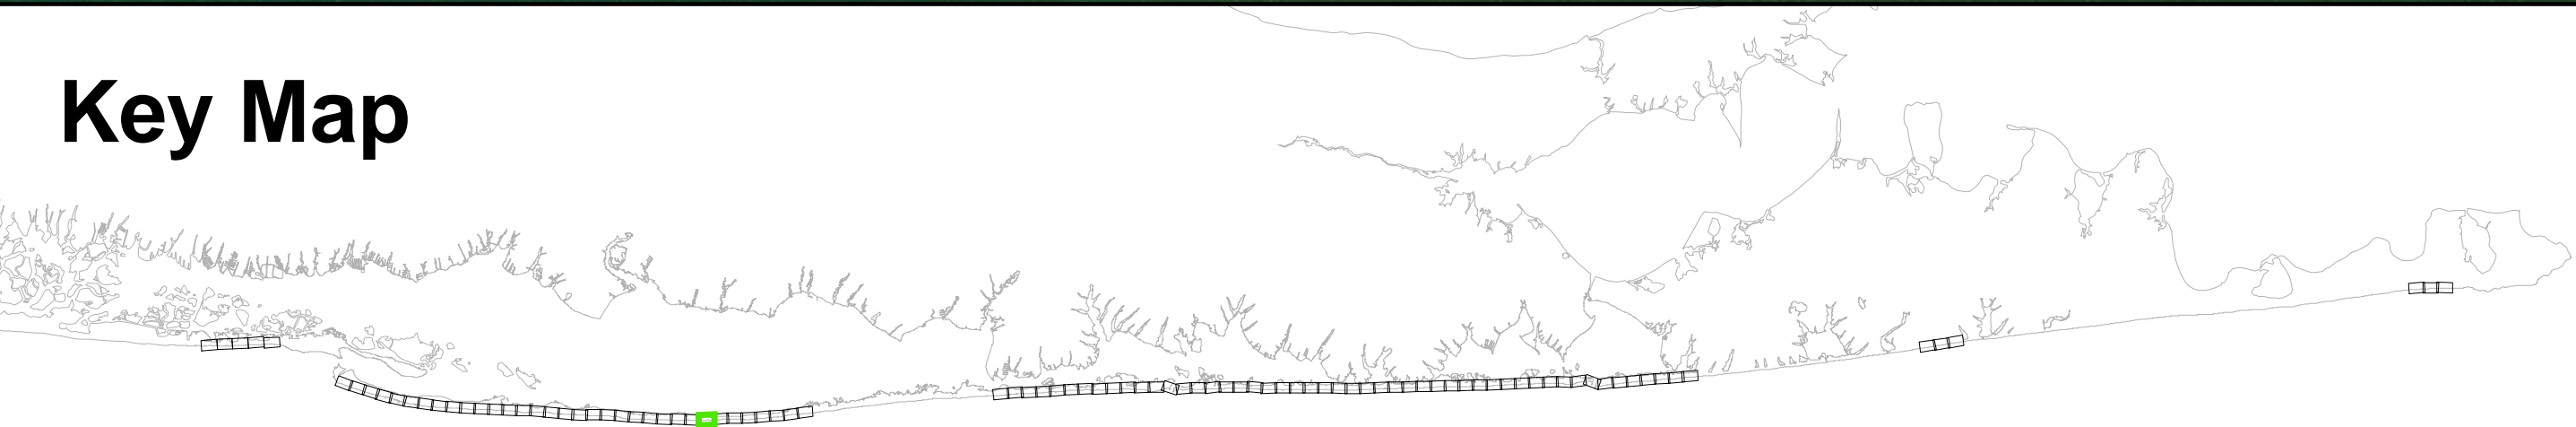


DRAFT		TITLE:		DRAWING NO.	
		Fire Island Inlet to Montauk Point, NY Reformulation Study		RE-32	
Reference Files:		DESIGNED BY:		SHEET 32 OF 95	
Designed by:		Checked by:			
Drawn by:		Reviewed by:			
Date:		Submitted by:			
Proj. Scale:		Comm. No.:			
AS NOTED		XXXX			




- Notes:**
- Parcel data: District - Section
Block - Lot
 - GRR Parcel Number: **11**
 - FIMI Parcel Number: **11**
 - Montauk Parcel Number: **11**
 - Westhampton Parcel Number: **11**

- Legend:**
- CEHA
 - MIDU_Baseline_20151022
 - Parcels
 - Easement Area
 - Impacted Parcels
 - GRR Plan Features
 - Landward Toe of Dune
 - Seaward Toe of Dune
 - Seaward Berm Crest
 - Design MHW (2 ft NGVD)
 - Dune - 1st Construction
 - Berm - 1st Construction

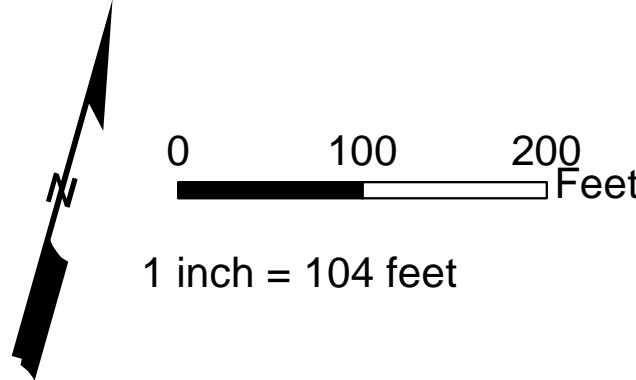

Key Map

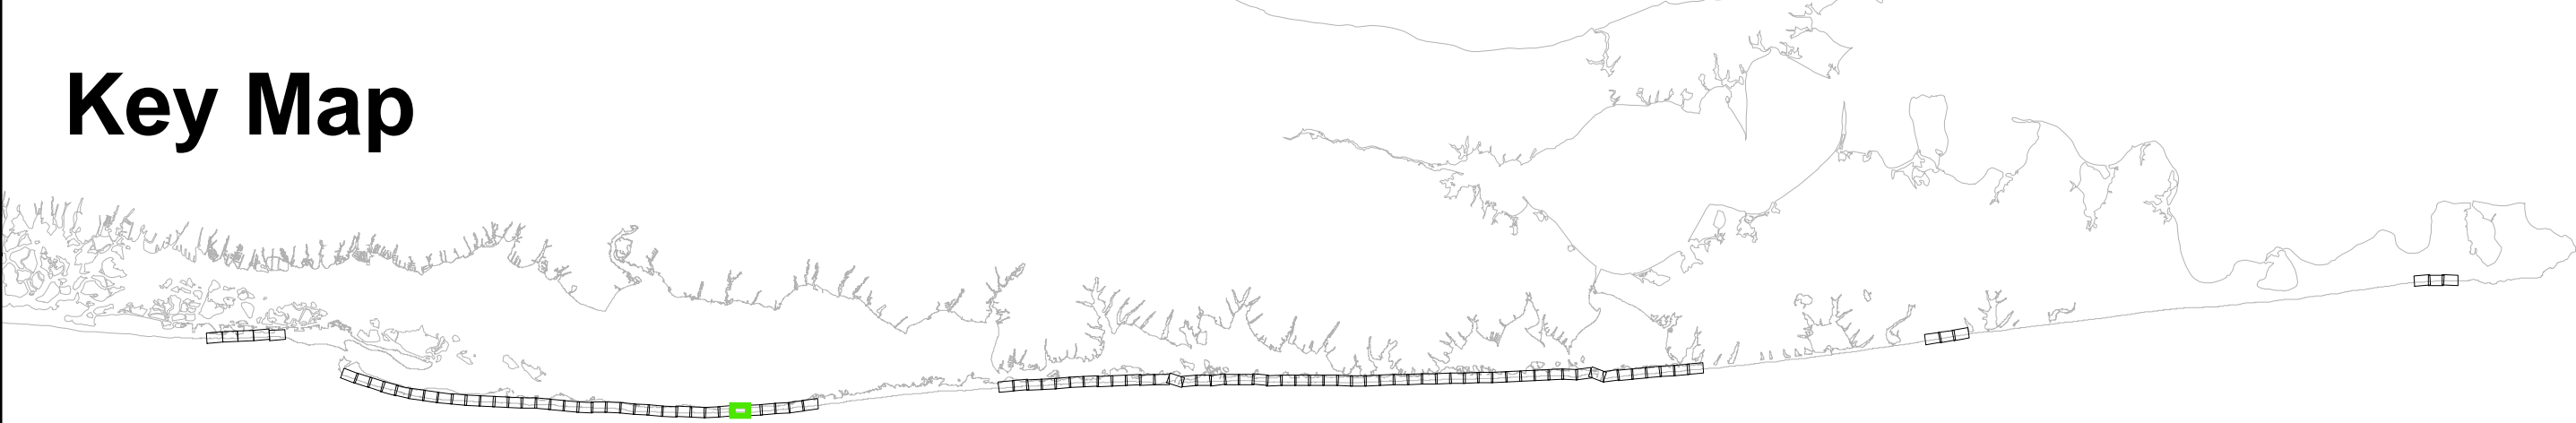

Reference Files:		Designed by:	Checked by:		
RWI		RWH	RWH		
Drawn by:		Reviewed by:	Reviewed by:		
Date:		Submitted by:	Submitted by:		
Nov. 18, 2015					
Proj Scale:		Comm. No.:	Comm. No.:		
AS NOTED		XXXXX	XXXXX		
TITLE:					
Fire Island Inlet to Montauk Point, NY					
Reformulation Study					
DRAWING NO.					
RE-34					
SHEET 34 OF 95					




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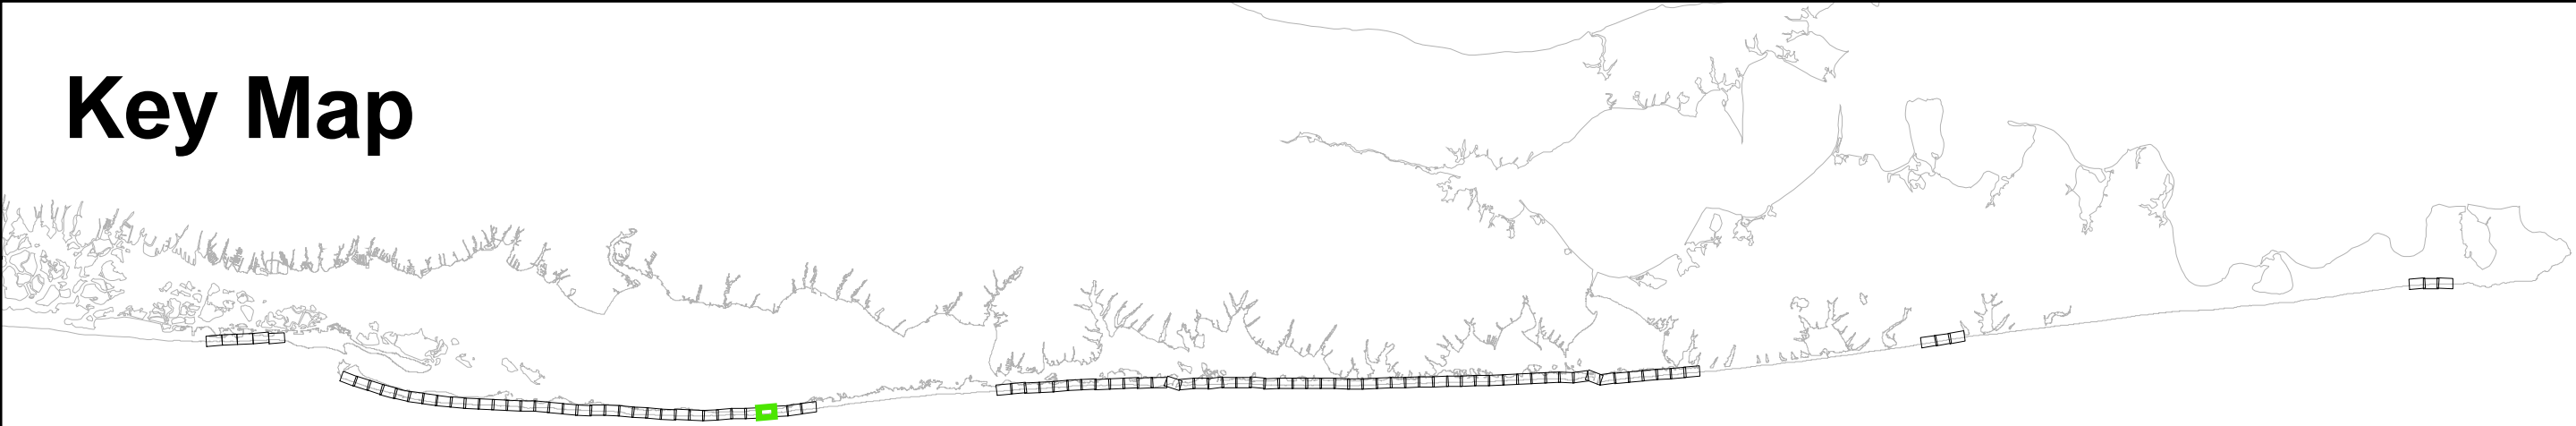
1. Parcel data: District - Section
Block - Lot
2. GRR Parcel Number: 11
3. FIMI Parcel Number: 11
4. Montauk Parcel Number: 11
5. Westhampton Parcel Number: 11

Legend:


- CEHA
- MIDU_Baseline_20151022
- Parcels
- Easement Area
- Impacted Parcels
- GRR Plan Features
- Landward Toe of Dune
- Seaward Toe of Dune
- Seaward Berm Crest
- Design MHW (2 ft NGVD)
- Dune - 1st Construction
- Berm - 1st Construction

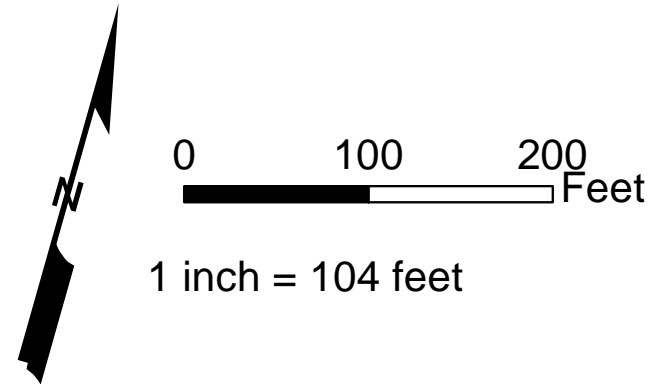

Key Map



TITLE:		DRAFT		Fire Island Inlet to Montauk Point, NY Reformulation Study	
DRAWING NO.		RE-36		SHEET 36 OF 95	
Reference Files:		Designed by:		Checked by:	
		Drawn by:		Reviewed by:	
		Date:		Submitted by:	
		Proj. Scale:		Comm. No.:	
		Nov. 18, 2015		XXXXX	
		AS NOTED			

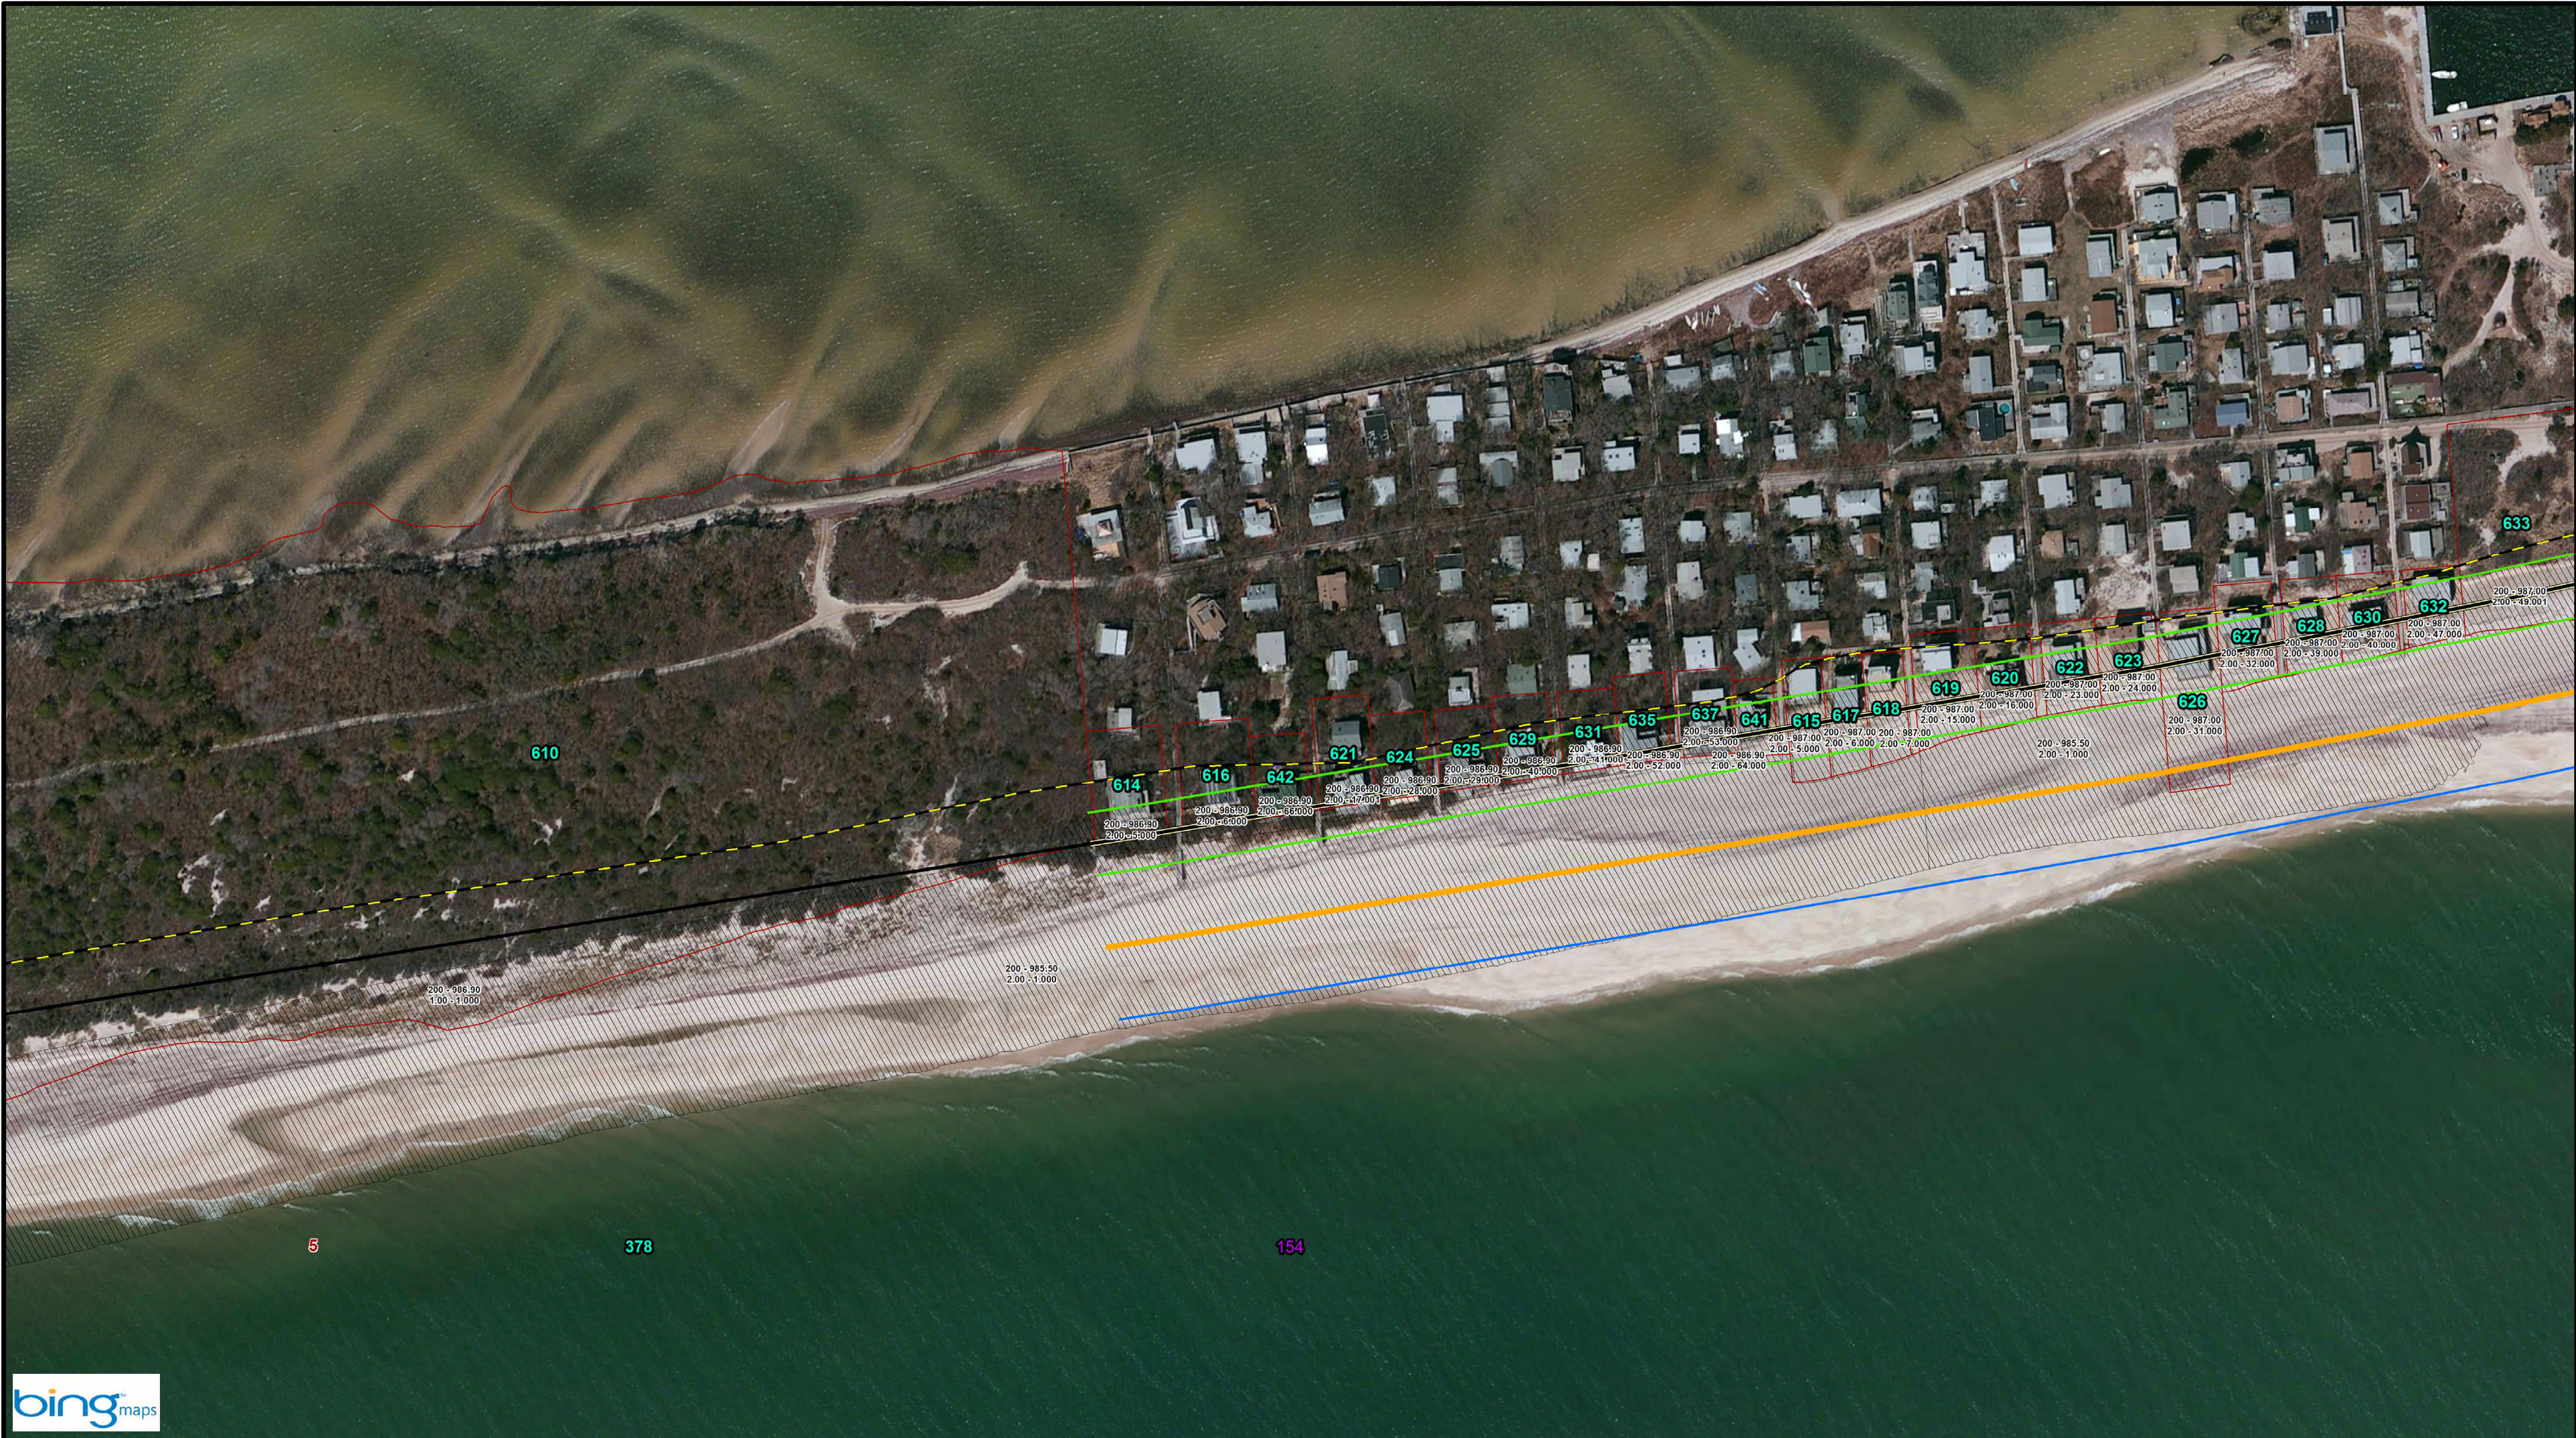


Notes:

1. Parcel data: District - Section
Block - Lot
2. GRR Parcel Number: 11
3. FIMI Parcel Number: 11
4. Montauk Parcel Number: 11
5. Westhampton Parcel Number: 11

Legend:

- CEHA
 - MIDU_Baseline_20151022
 - Parcels
 - Easement Area
 - Impacted Parcels
- GRR Plan Features
- Landward Toe of Dune
 - Seaward Toe of Dune
 - Seaward Berm Crest
 - Design MHW (2 ft NGVD)
 - Dune - 1st Construction
 - Berm - 1st Construction

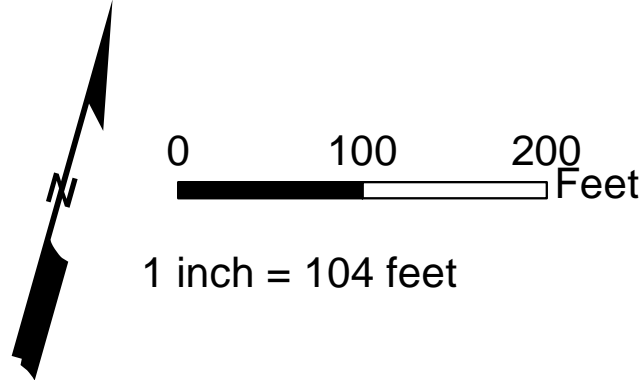

Key Map



TITLE:		DRAFT		Fire Island Inlet to Montauk Point, NY Reformulation Study	
DRAWING NO.		RE-37		SHEET 37 OF 95	
Reference Files:		Designed by: RWH		Checked by:	
		Drawn by: RWH		Reviewed by:	
		Date: Nov. 18, 2015		Submitted by:	
		Proj. Scale: AS NOTED		Comm. No.: XXXXX	
				No. Date	




Notes:

1. Parcel data: District - Section
Block - Lot
2. GRR Parcel Number: **11**
3. FIMI Parcel Number: **11**
4. Montauk Parcel Number: **11**
5. Westhampton Parcel Number: **11**

Legend:

- CEHA
 - MIDU_Baseline_20151022
 - Parcels
 - Easement Area
 - Impacted Parcels
- GRR Plan Features
- Landward Toe of Dune
 - Seaward Toe of Dune
 - Seaward Berm Crest
 - Design MHW (2 ft NGVD)
 - Dune - 1st Construction
 - Berm - 1st Construction

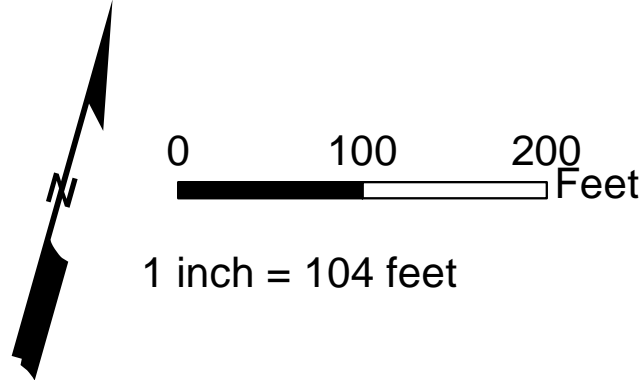

Key Map



TITLE:		DRAFT		Fire Island Inlet to Montauk Point, NY Reformulation Study	
DRAWING NO.		RE-54		SHEET 54 OF 95	
Reference Files:		Designed by:		Checked by:	
Drawn by:		RW		RW	
Date:		Nov. 18, 2015		Reviewed by:	
Proj. Scale:		AS NOTED		Submitted by:	
Comm. No.:		XXXX		No.:	
				Date:	




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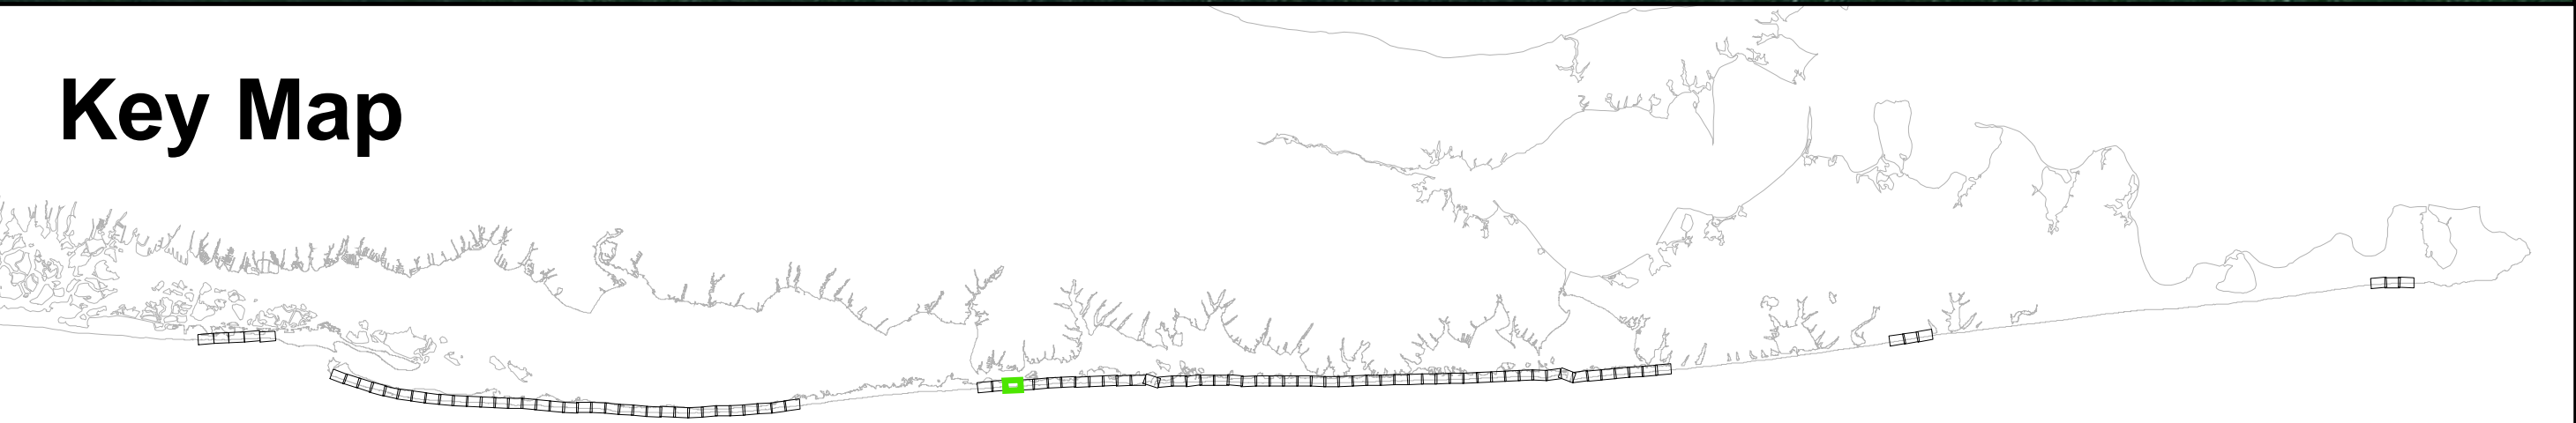
1. Parcel data: District - Section
Block - Lot
2. GRR Parcel Number: **11**
3. FIMI Parcel Number: **11**
4. Montauk Parcel Number: **11**
5. Westhampton Parcel Number: **11**

Legend:

- CEHA
- MIDU_Baseline_20151022
- Parcels
- Easement Area
- Impacted Parcels
- GRR Plan Features
- Landward Toe of Dune
- Seaward Toe of Dune
- Seaward Berm Crest
- Design MHW (2 ft NGVD)
- Dune - 1st Construction
- Berm - 1st Construction

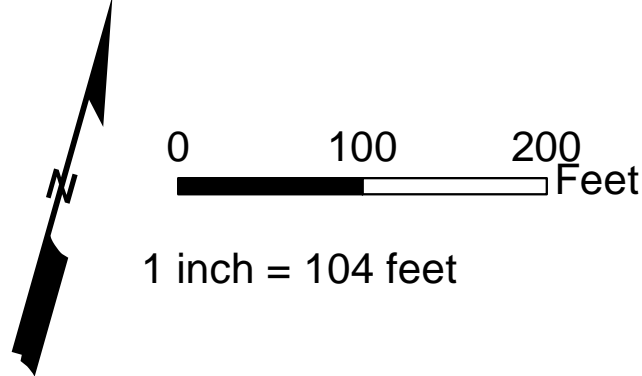

Key Map



DRAFT		TITLE:		DRAWING NO.	
		Fire Island Inlet to Montauk Point, NY Reformulation Study		RE-55	
Reference Files:		Designed by:		SHEET 55 OF 95	
Checked by:		Reviewed by:			
Drawn by:		Submitted by:			
Date:		Comm. No.:			
Rev. 18, 2015		AS NOTED			
No.		Date			
XXXXX					



- Notes:**
1. Parcel data: District - Section
Block - Lot
2. GRR Parcel Number: 11
3. FIMI Parcel Number: 11
4. Montauk Parcel Number: 11
5. Westhampton Parcel Number: 11

- Legend:**
- CEHA

MIDU_Baseline_20151022

Parcels

Easement Area

Impacted Parcels
- GRR Plan Features

Landward Toe of Dune


Seaward Toe of Dune

Seaward Berm Crest


Design MHW (2 ft NGVD)

Dune - 1st Construction

Berm - 1st Construction

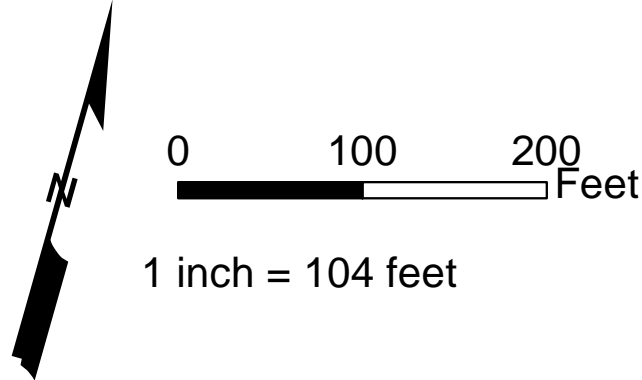

Key Map

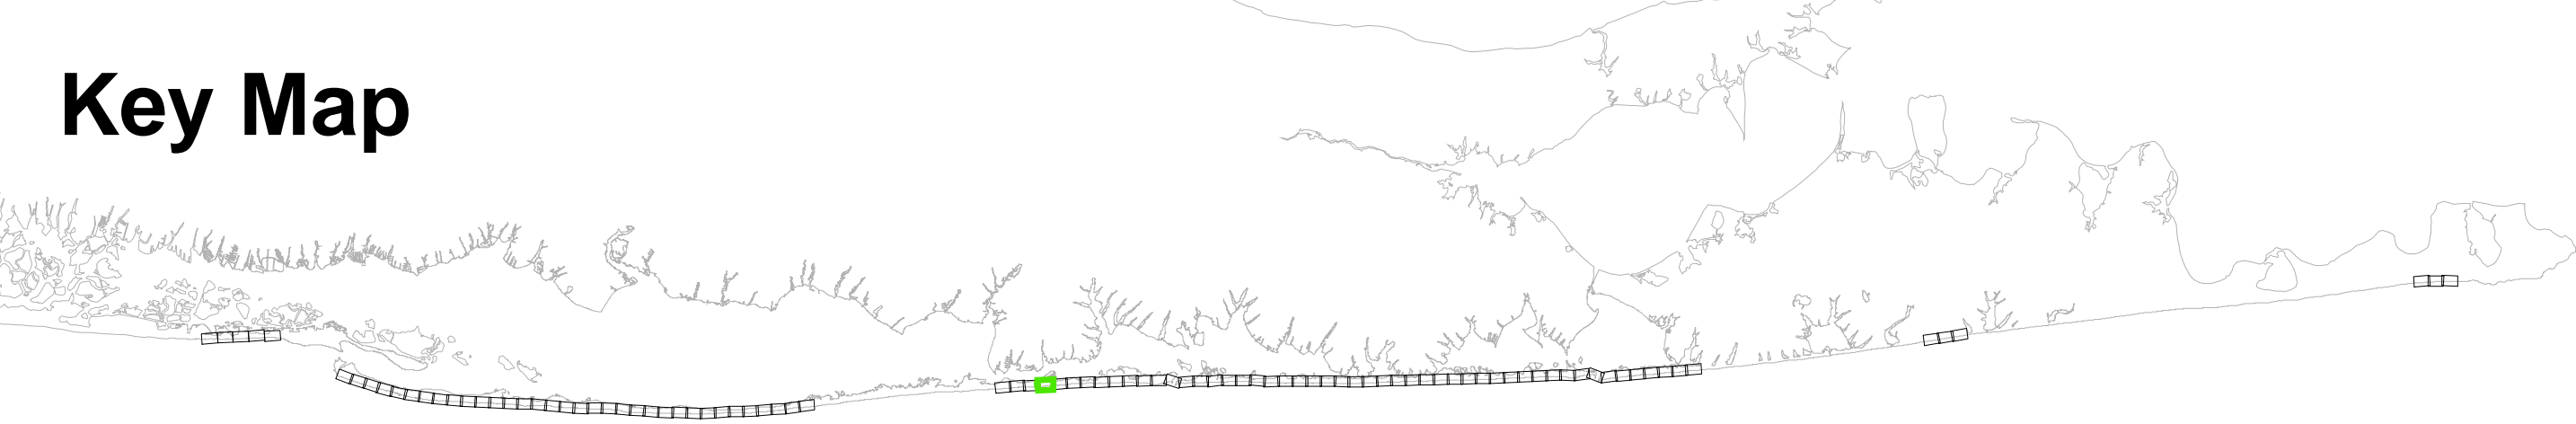

Reference Files:	Designed by:	RWH	Checked by:				
	Drawn by:	RWH	Reviewed by:				
	Date:	Nov. 18, 2015	Submitted by:				
	Proj. Scale:	AS NOTED	Comm. No.:	XXXXX			
TITLE:				DRAWING NO.			
DRAFT				RE-56			
Fire Island Inlet to Montauk Point, NY Reformulation Study				SHEET 56 OF 95			




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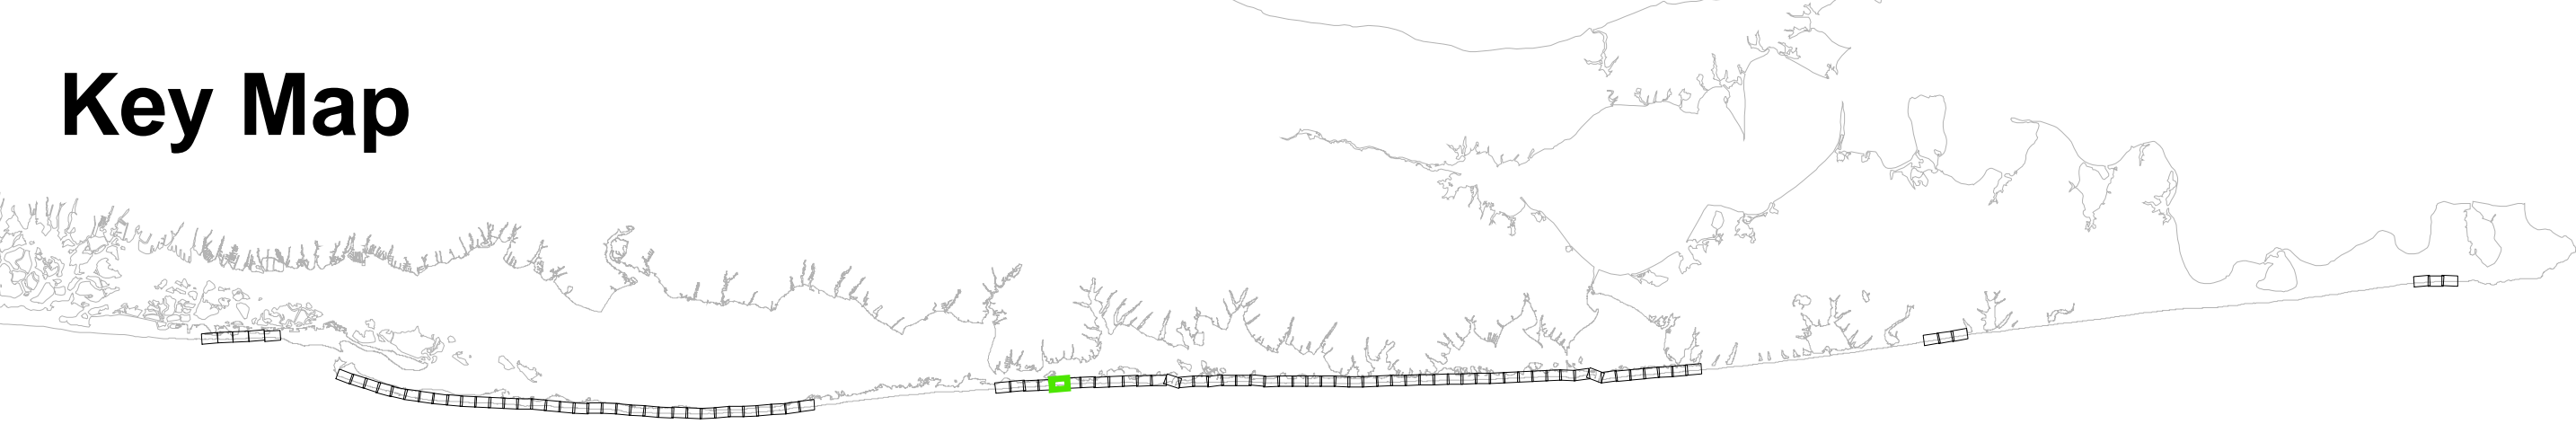
1. Parcel data: District - Section
Block - Lot
2. GRR Parcel Number: 11
3. FIMI Parcel Number: 11
4. Montauk Parcel Number: 11
5. Westhampton Parcel Number: 11

Legend:


- CEHA
MIDU_Baseline_20151022
Parcels
Easement Area
Impacted Parcels
- GRR Plan Features
Landward Toe of Dune
Seaward Toe of Dune
Seaward Berm Crest
Design MHW (2 ft NGVD)
Dune - 1st Construction
Berm - 1st Construction

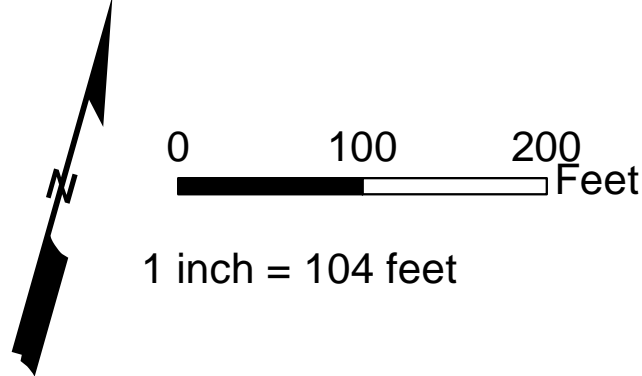

Key Map



DRAFT		Reference Files:			
TITLE:		Designed by: RWH		Checked by:	
Fire IslandInlet to Montauk Point, NY		Drawn by: RWH		Reviewed by:	
Reformulation Study		Date: Nov 18, 2015		Submitted by:	
		Plot Scale:		Comm. No.:	
		AS NOTED		XXXXX	
				No. Date	

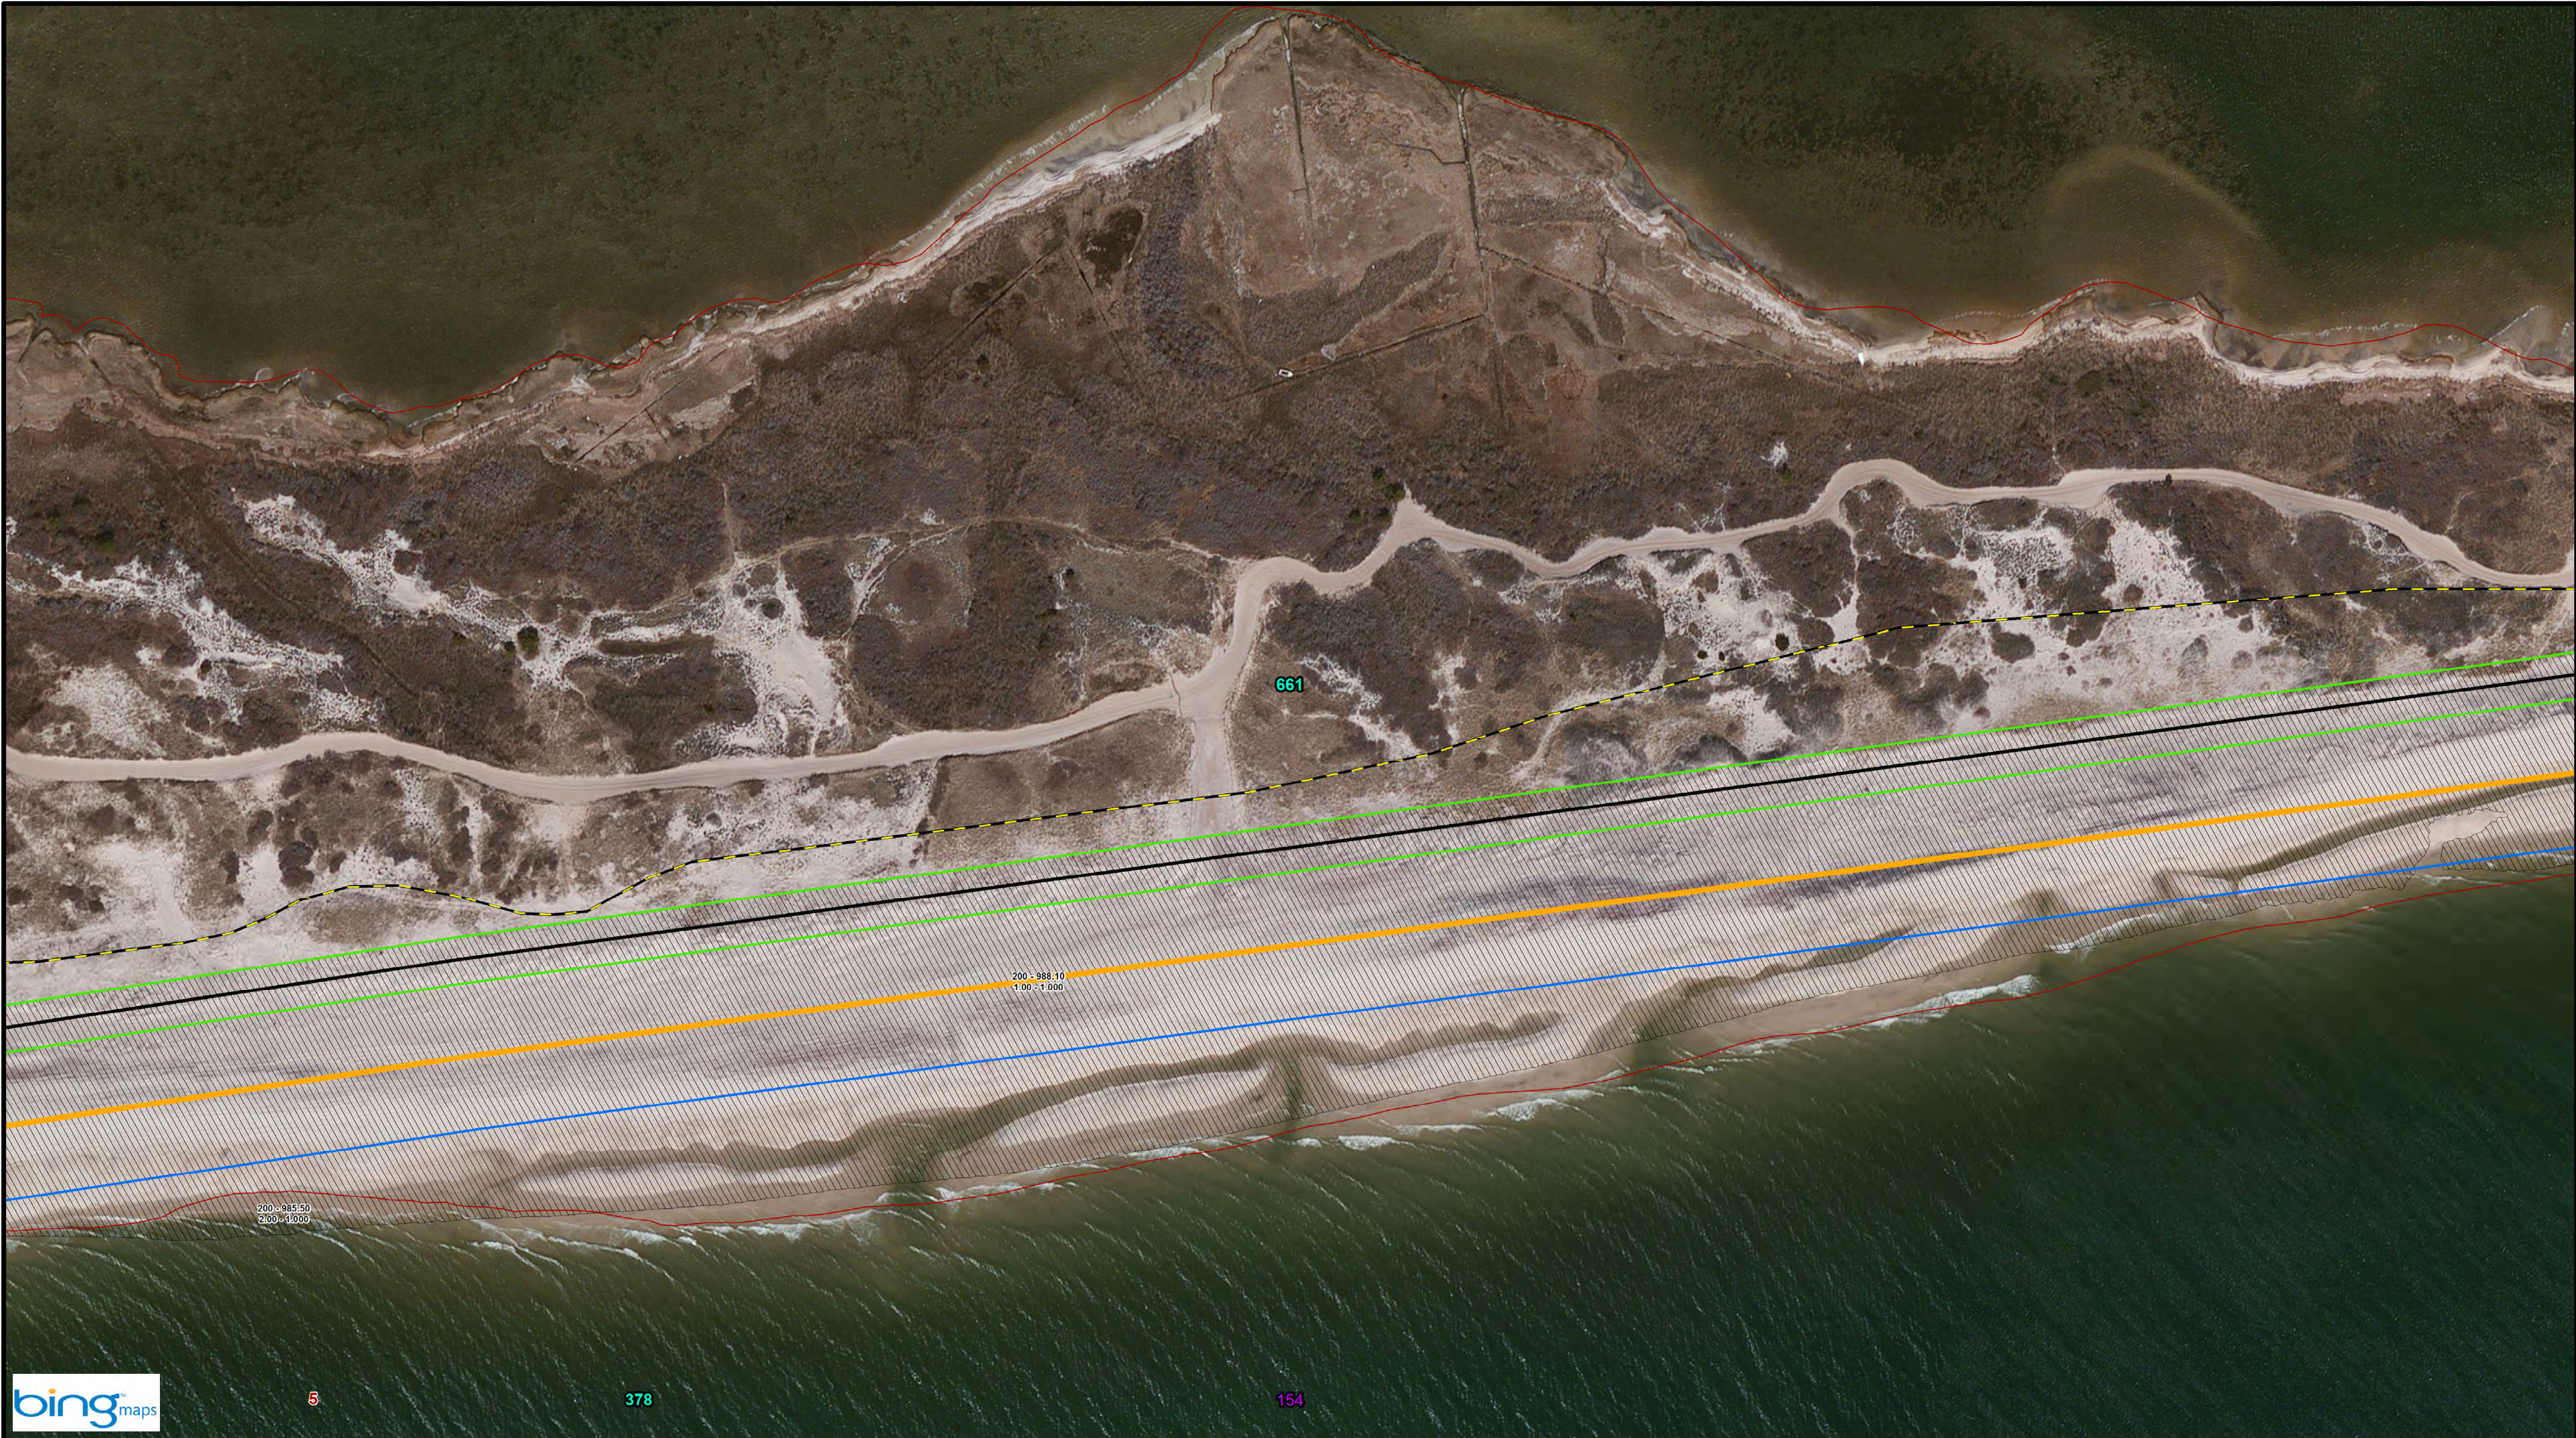


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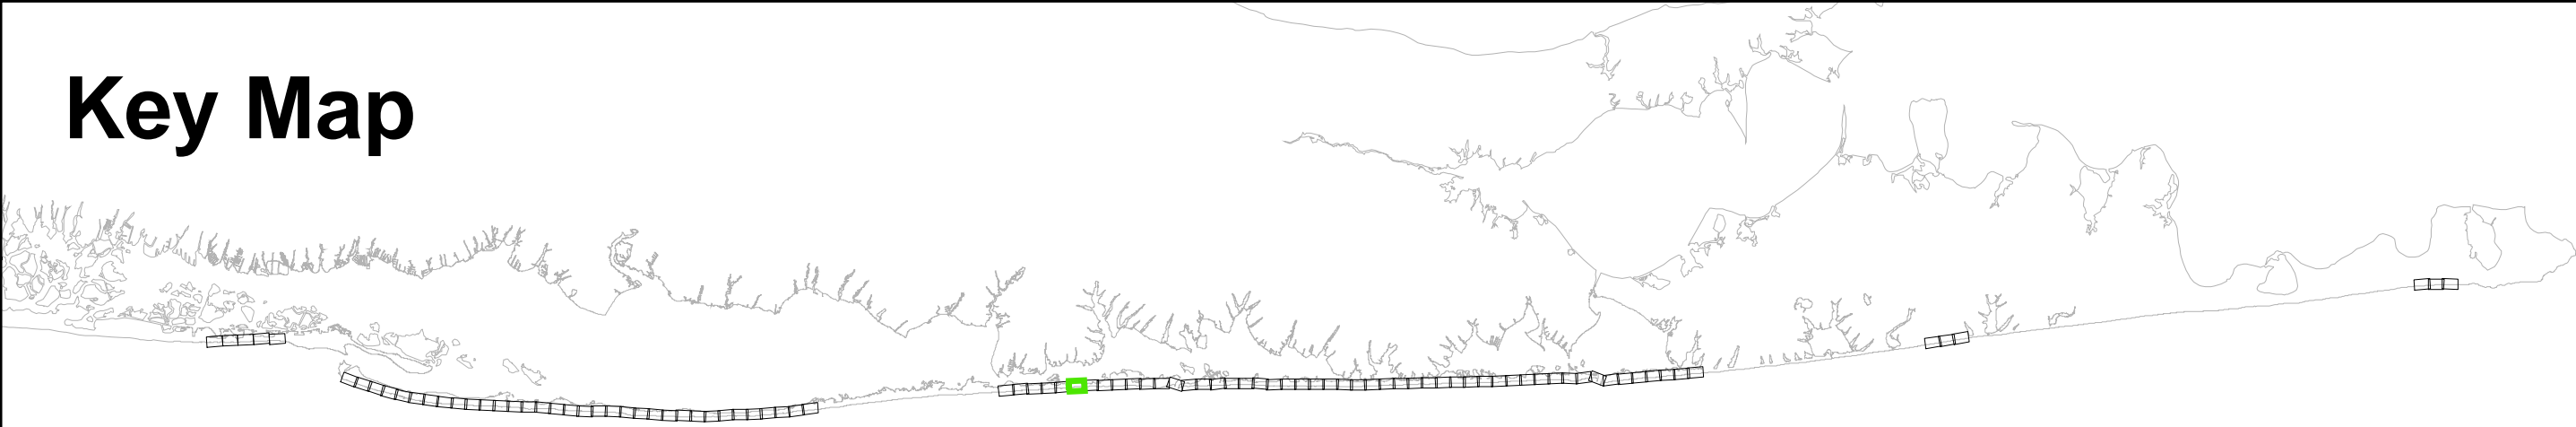
1. Parcel data: District - Section
Block - Lot
2. GRR Parcel Number: **11**
3. FIMI Parcel Number: **11**
4. Montauk Parcel Number: **11**
5. Westhampton Parcel Number: **11**

Legend:

- | | |
|------------------------|-------------------------|
| CEHA | Landward Toe of Dune |
| MIDU_Baseline_20151022 | Seaward Toe of Dune |
| Parcels | Seaward Berm Crest |
| Easement Area | Design MHW (2 ft NGVD) |
| Impacted Parcels | Dune - 1st Construction |
| | Berm - 1st Construction |

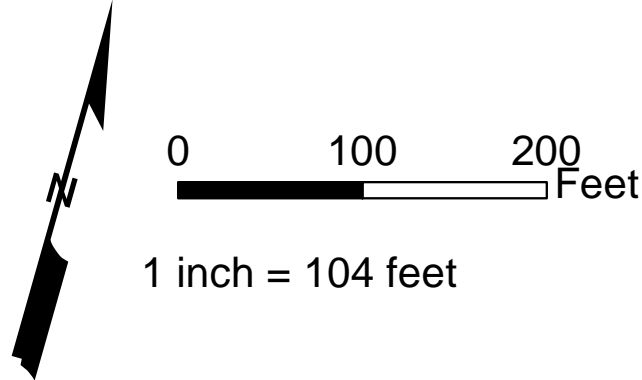

Key Map



SHEET 58 OF 95		DRAWING NO.		TITLE:		Reference Files:										Designed by: RWH										Checked by:																			
RE-58				DRAFT		Fire IslandInlet to Montauk Point, NY Reformulation Study										Drawn by: RWH										Reviewed by:																			
																Date: Nov 18, 2015										Submitted by:																			
																Plot Scale: AS NOTED										Comm. No.:																			
																										XXXXX																			
																										No.										Date									




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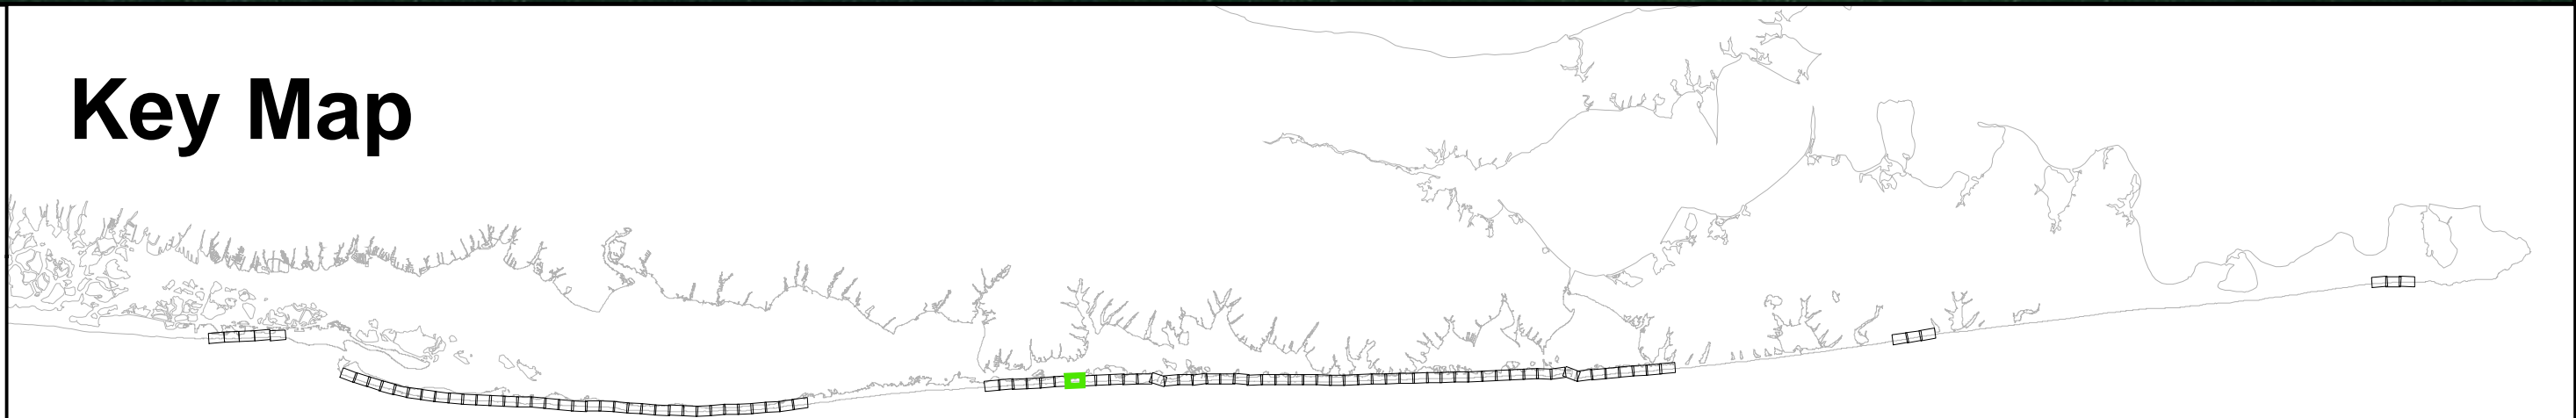
1. Parcel data: District - Section
Block - Lot
2. GRR Parcel Number: **11**
3. FIMI Parcel Number: **11**
4. Montauk Parcel Number: **11**
5. Westhampton Parcel Number: **11**

Legend:

- CEHA
- MIDU_Baseline_20151022
- Parcels
- Easement Area
- Impacted Parcels
- GRR Plan Features
- Landward Toe of Dune
- Seaward Toe of Dune
- Seaward Berm Crest
- Design MHW (2 ft NGVD)
- Dune - 1st Construction
- Berm - 1st Construction

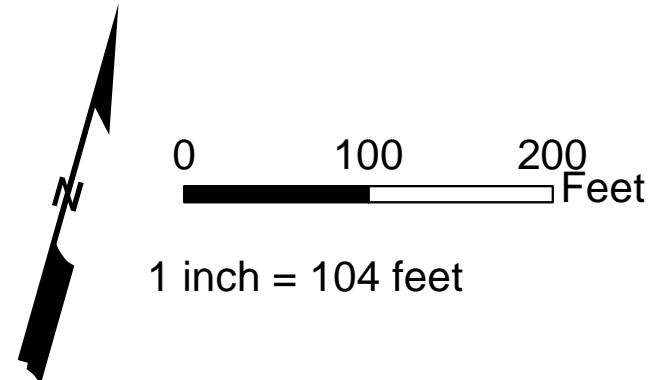

Key Map



DRAFT		Fire Island Inlet to Montauk Point, NY Reformulation Study		DRAWING NO. RE-59	
TITLE:		SHEET 59 OF 95			
Designed by:	RWH	Checked by:		No.	Rev.
Drawn by:	RWH	Reviewed by:			
Date:	Nov. 18, 2015	Submitted by:			
Proj. Scale:	AS NOTED	Comm. No.:	XXXXX		




Notes:

1. Parcel data: District - Section
Block - Lot
2. GRR Parcel Number: 11
3. FIMI Parcel Number: 11
4. Montauk Parcel Number: 11
5. Westhampton Parcel Number: 11

Legend:

- CEHA
- MIDU_Baseline_20151022
- Parcels
- Easement Area
- Impacted Parcels
- GRR Plan Features
- Landward Toe of Dune
- Seaward Toe of Dune
- Seaward Berm Crest
- Design MHW (2 ft NGVD)
- Dune - 1st Construction
- Berm - 1st Construction

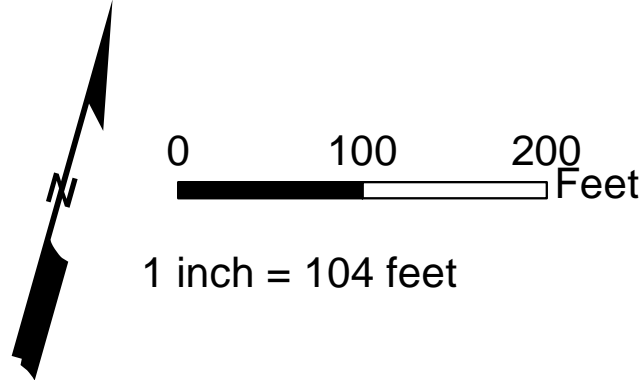

Key Map



DRAFT		Fire Island Inlet to Montauk Point, NY Reformulation Study	
TITLE:		DRAWING NO.	
RE-60		SHEET 60 OF 95	
Designed by:	RWH	Checked by:	
Drawn by:	RWH	Reviewed by:	
Date:	Nov. 18, 2015	Submitted by:	
Proj. Scale:	AS NOTED	Comm. No.:	XXXXX




Notes:

1. Parcel data: District - Section Block - Lot
2. GRR Parcel Number: **11**
3. FIMI Parcel Number: **11**
4. Montauk Parcel Number: **11**
5. Westhampton Parcel Number: **11**

Legend:

- CEHA
- MIDU_Baseline_20151022
- Parcels
- Easement Area
- Impacted Parcels
- GRR Plan Features
- Landward Toe of Dune
- Seaward Toe of Dune
- Seaward Berm Crest
- Design MHW (2 ft NGVD)
- Dune - 1st Construction
- Berm - 1st Construction

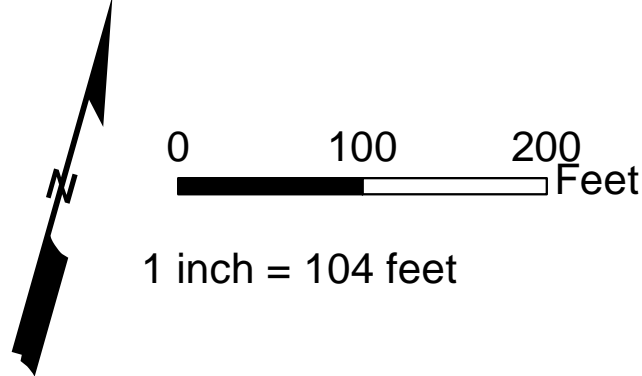

Key Map



Reference Files:	Designed by:	RWH	Checked by:				
	Drawn by:	RWH	Reviewed by:				
	Date:	Nov. 18, 2015	Submitted by:				
	Proj. Scale:	AS NOTED	Comm. No.:	XXXXX			
TITLE:				DRAWING NO.			
DRAFT				RE-61			
Fire Island Inlet to Montauk Point, NY Reformulation Study				SHEET 61 OF 95			




Notes:

1. Parcel data: District - Section Block - Lot
2. GRR Parcel Number: **11**
3. FIMI Parcel Number: **11**
4. Montauk Parcel Number: **11**
5. Westhampton Parcel Number: **11**

Legend:


- | | |
|------------------------|-------------------------|
| CEHA | Landward Toe of Dune |
| MIDU_Baseline_20151022 | Seaward Toe of Dune |
| Parcels | Seaward Berm Crest |
| Easement Area | Design MHW (2 ft NGVD) |
| Impacted Parcels | Dune - 1st Construction |
| | Berm - 1st Construction |

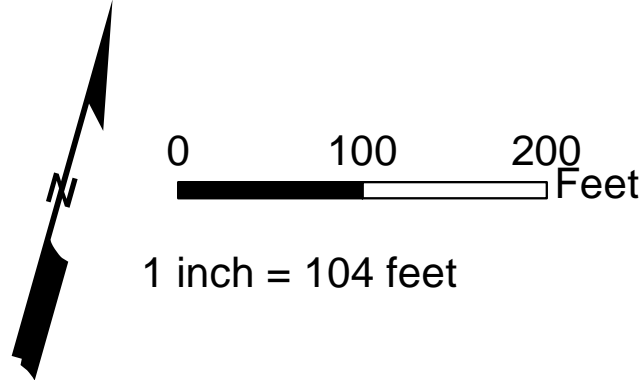

Key Map



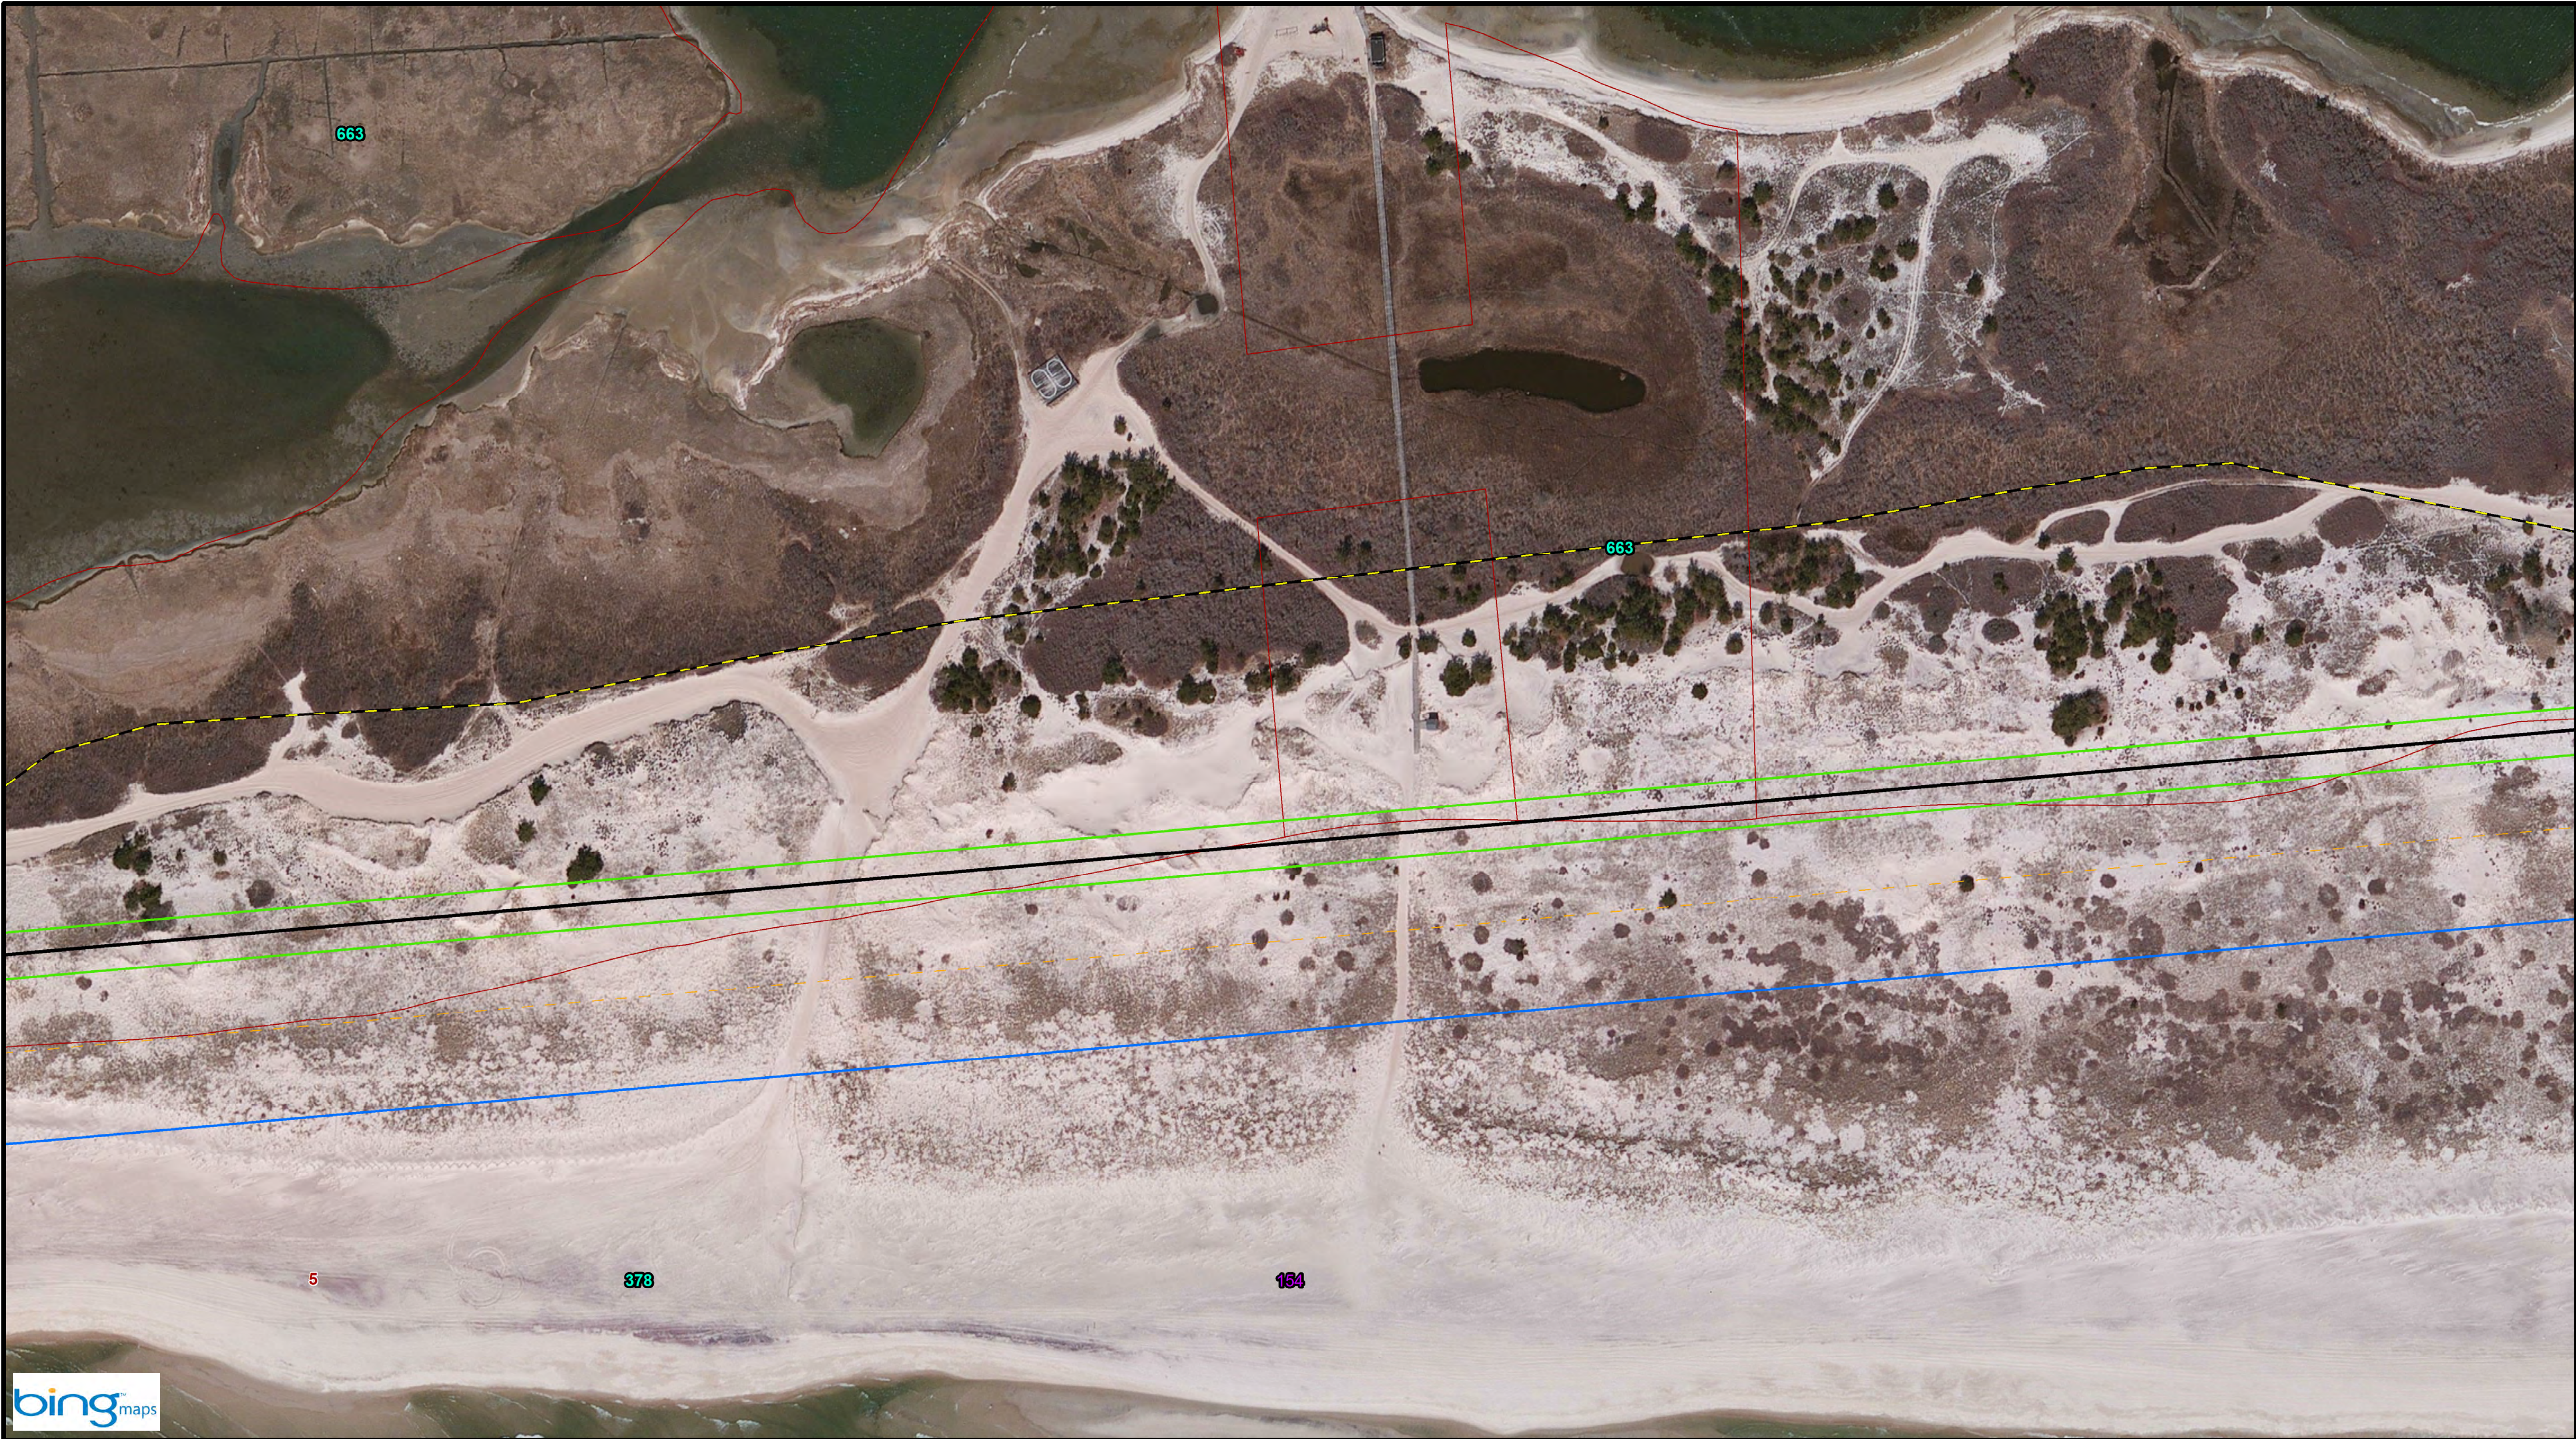

DRAFT										Reference Files:										Checked by:										Reviewed by:										Submitted by:										Comm. No.:										XXXXX										No.										Date																																																																																																																																																																																																																																																																																																																																																																																																																																																																																																																																																																																																																																																																																																																																																																																																																																																																																																																																																																																																																																																																																																																																																																																																																																																																																																																																																																																																																																																																																																																																																																																																																																																																																																																																																																																																																																																																																																																																																																																																																																																																																																																																																																																																																																																																																																																																																																																																																																																																																																																																																																																																																																																																																																																																																																																																																																																																																																																																																																																																																																																																																																																																																																																																																																																																																																																																																																																																																																																																																																																																																																																																																																																																																																																																																																																																																																																																																																																																																																																																																																																																																																																																																																																																																																																																																																																																																																																																																																																																																																																																																																																																																																																																																																																																																																																																																																																																																																																																																																																																																																																																																																																																																										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



- Notes:**
1. Parcel data: District - Section
Block - Lot
 2. GRR Parcel Number: 11
 3. FIMI Parcel Number: 11
 4. Montauk Parcel Number: 11
 5. Westhampton Parcel Number: 11



Legend:


-  CEHA


 MIDU_Baseline_20151022


 Parcels


 Easement Area


 Impacted Parcels
-  GRR Plan Features


 Landward Toe of Dune


 Seaward Toe of Dune

 Seaward Berm Crest

 Design MHW (2 ft NGVD)

 Dune - 1st Construction

 Berm - 1st Construction

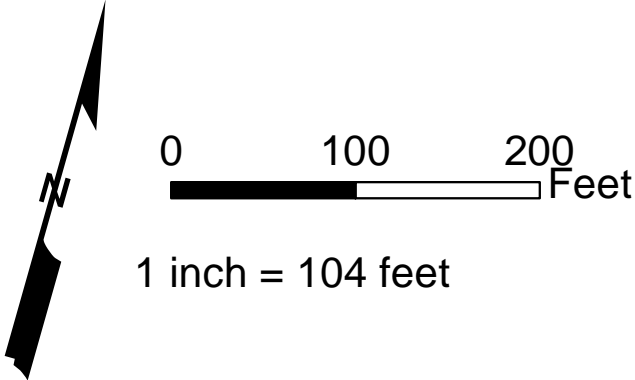

Key Map





TITLE:		DRAFT		Fire Island Inlet to Montauk Point, NY Reformulation Study	
DRAWING NO.		RE-63		SHEET 63 OF 95	
Reference Files:		Designed by: RWH		Checked by:	
		Drawn by: RWH		Reviewed by:	
		Date: Nov. 18, 2015		Submitted by:	
		Proj. Scale: AS NOTED		Comm. No.: XXXXX	
				No. 100	





- Notes:**
- 1. Parcel data: District - Section
Block - Lot
 - 2. GRR Parcel Number: 11
 - 3. FIMI Parcel Number: 11
 - 4. Montauk Parcel Number: 11
 - 5. Westhampton Parcel Number: 11



Legend:


-  CEHA


 MIDU_Baseline_20151022


 Parcels


 Easement Area


 Impacted Parcels
-  Landward Toe of Dune


 Seaward Toe of Dune

 Seaward Berm Crest


 Design MHW (2 ft NGVD)

 Dune - 1st Construction

 Berm - 1st Construction

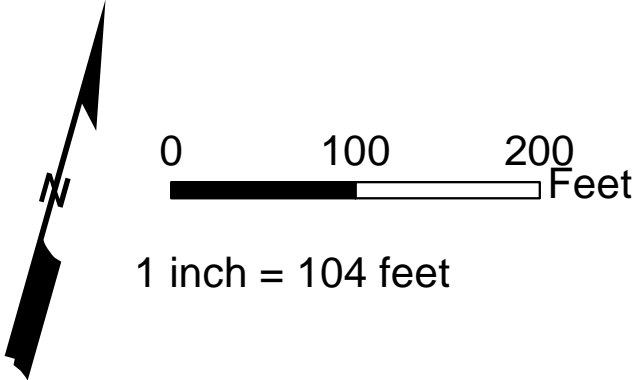

Key Map

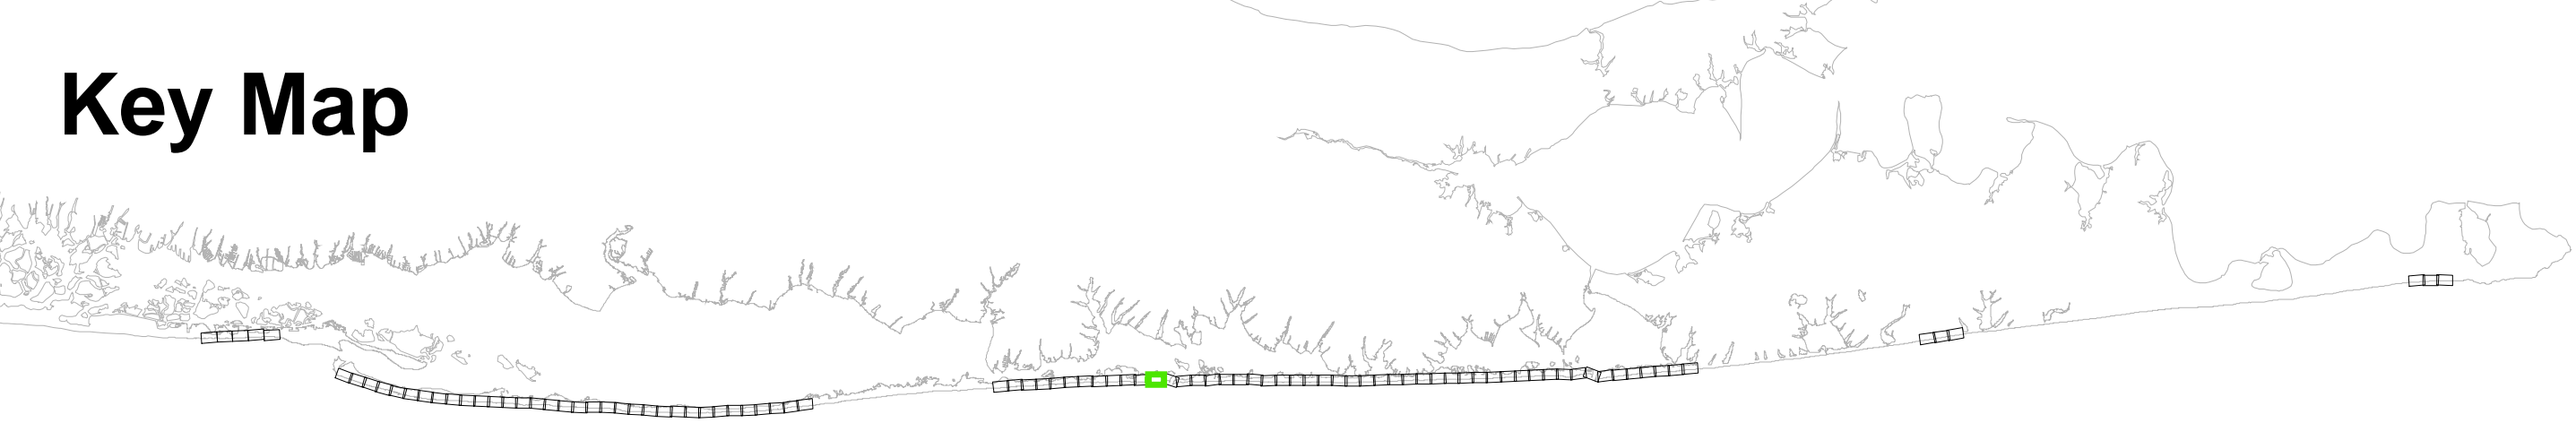

TITLE:		DRAFT		Fire Island Inlet to Montauk Point, NY Reformulation Study	
DRAWING NO.		RE-64		SHEET 64 OF 95	
Reference Files:		Designed by: RWH		Checked by:	
Drawn by: RWH		Reviewed by:		No.	
Date: Nov. 18, 2015		Submitted by:		Date:	
Proj. Scale: AS NOTED		Comm. No.: XXXXX		No.	




Notes:


- Parcel data: District - Section
Block - Lot
- GRR Parcel Number: 11
- FIMI Parcel Number: 11
- Montauk Parcel Number: 11
- Westhampton Parcel Number: 11

Legend:

- CEHA
- MIDU_Baseline_20151022
- Parcels
- Easement Area
- Impacted Parcels
- GRR Plan Features
- Landward Toe of Dune
- Seaward Toe of Dune
- Seaward Berm Crest
- Design MHW (2 ft NGVD)
- Dune - 1st Construction
- Berm - 1st Construction

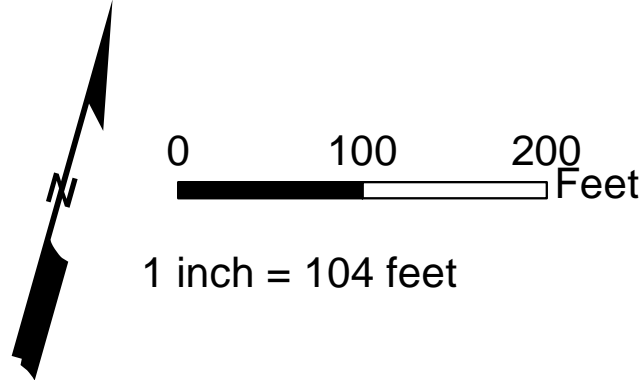

Key Map

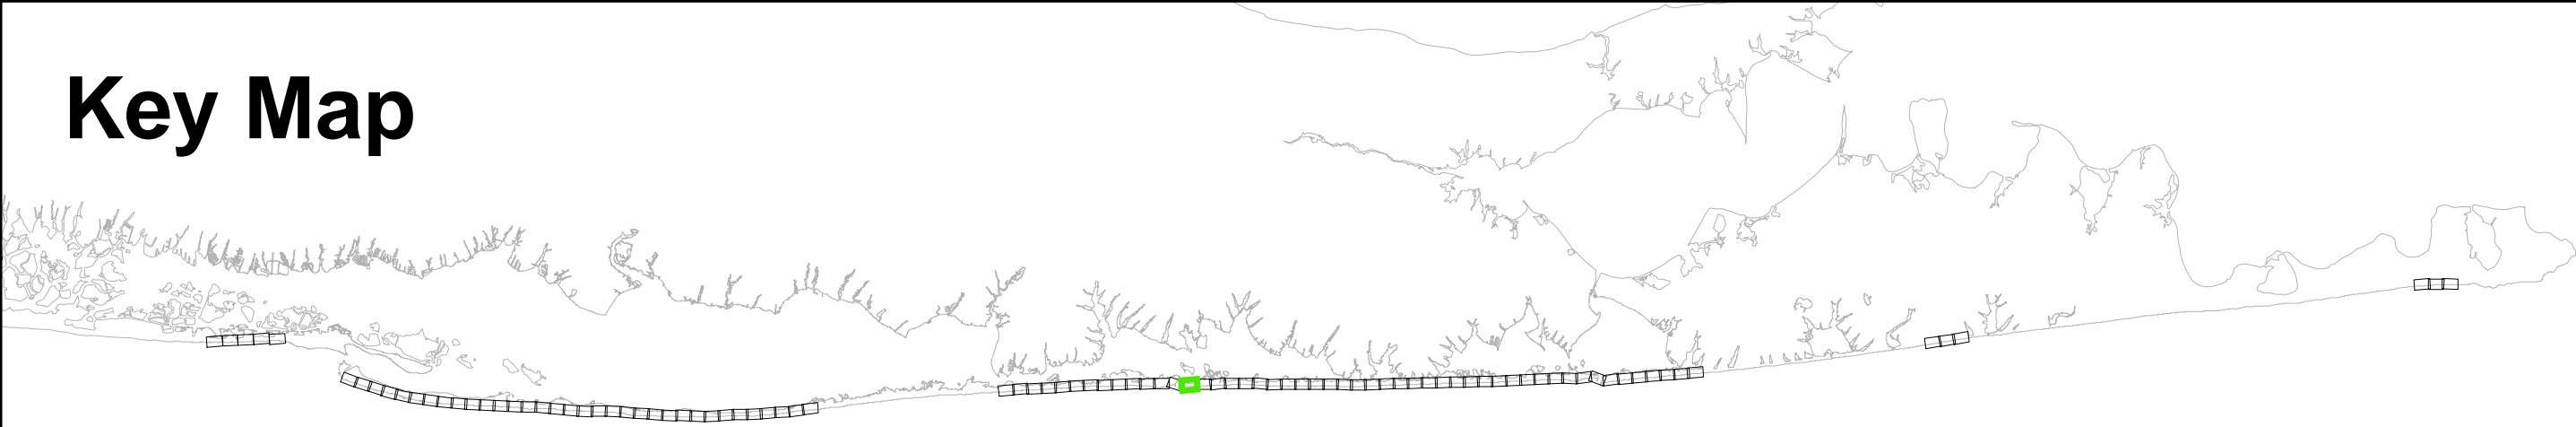

DRAFT				Fire Island Inlet to Montauk Point, NY Reformulation Study			
TITLE:				DRAWING NO.			
RE-66				SHEET 66 OF 95			
Reference Files:				Designed by: RWH			
Checked by:				Reviewed by: RWH			
Drawn by:				Submitted by:			
Date:				Comm. No.:			
Nov. 18, 2015				XXXXX			
Proj. Status:				AS NOTED			




Notes:


1. Parcel data: District - Section
Block - Lot
2. GRR Parcel Number: **11**
3. FIMI Parcel Number: **11**
4. Montauk Parcel Number: **11**
5. Westhampton Parcel Number: **11**

Legend:

- CEHA
MIDU_Baseline_20151022
Parcels
Easement Area
Impacted Parcels
- GRR Plan Features
Landward Toe of Dune
Seaward Toe of Dune
Seaward Berm Crest
Design MHW (2 ft NGVD)
Dune - 1st Construction
Berm - 1st Construction

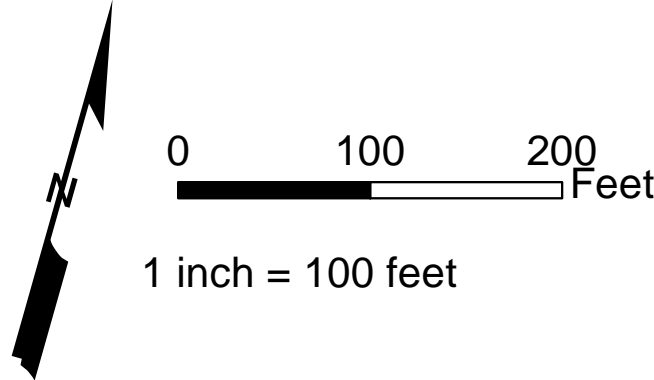

Key Map

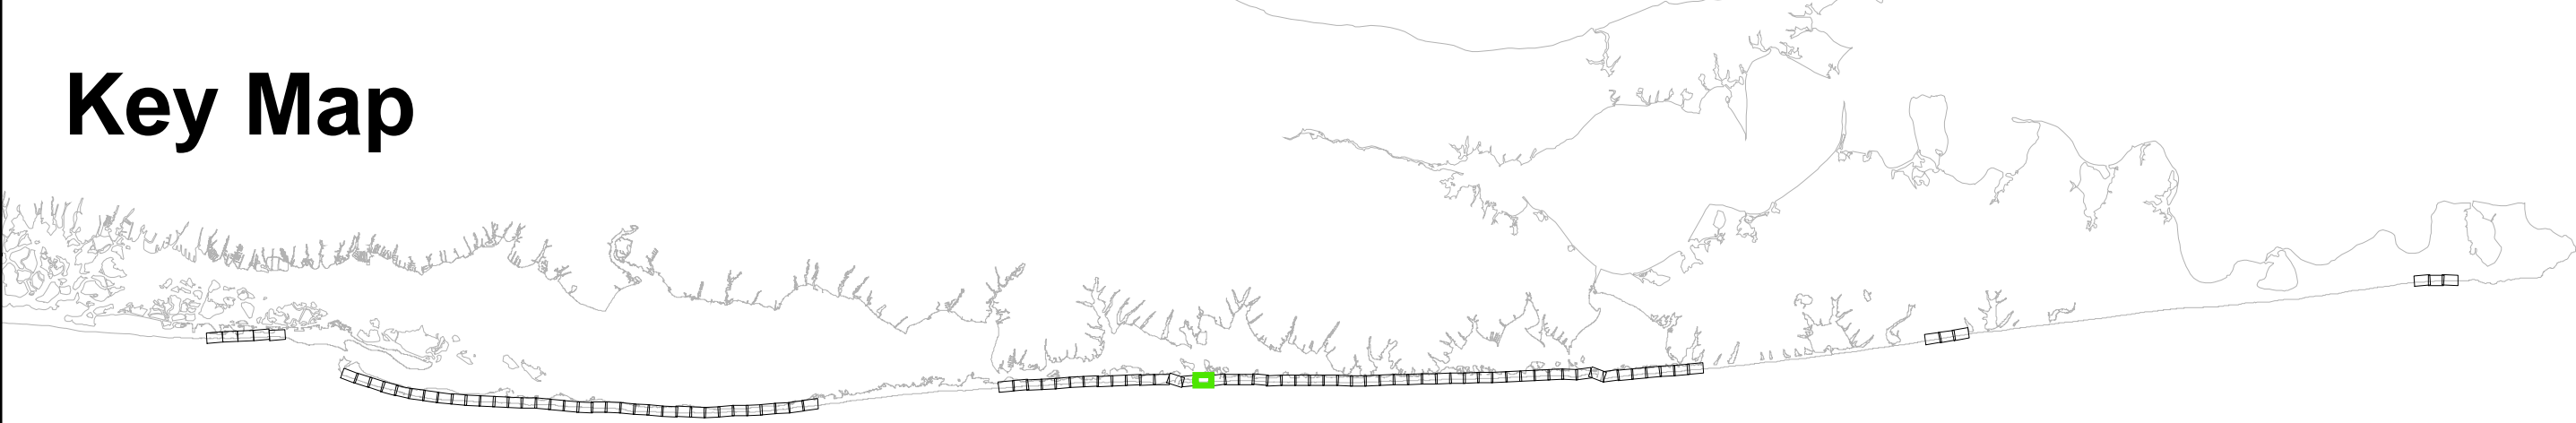

SHEET 67 OF 95		DRAWING NO.		TITLE:	
RE-67		DRAFT		Fire IslandInlet to Montauk Point, NY Reformulation Study	
Reference Files:		Designed by: RWH		Checked by:	
		Drawn by: RWH		Reviewed by:	
		Date: Nov 24, 2015		Submitted by:	




Notes:


1. Parcel data: District - Section
Block - Lot
2. GRR Parcel Number: **11**
3. FIMI Parcel Number: **11**
4. Montauk Parcel Number: **11**
5. Westhampton Parcel Number: **11**

Legend:

- CEHA
 - MIDU_Baseline_20151022
 - Parcels
 - Easement Area
 - Impacted Parcels
- GRR Plan Features
- Landward Toe of Dune
 - Seaward Toe of Dune
 - Seaward Berm Crest
 - Design MHW (2 ft NGVD)
 - Dune - 1st Construction
 - Berm - 1st Construction

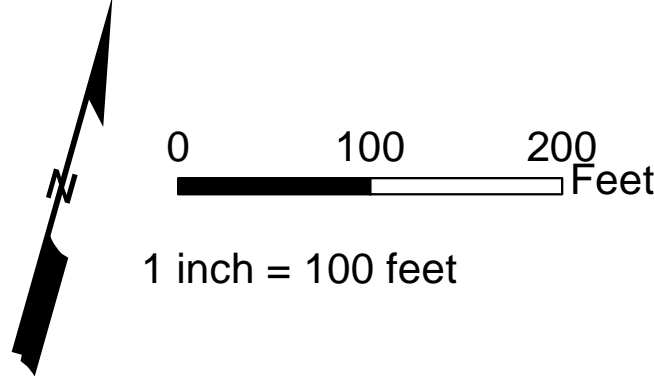

Key Map

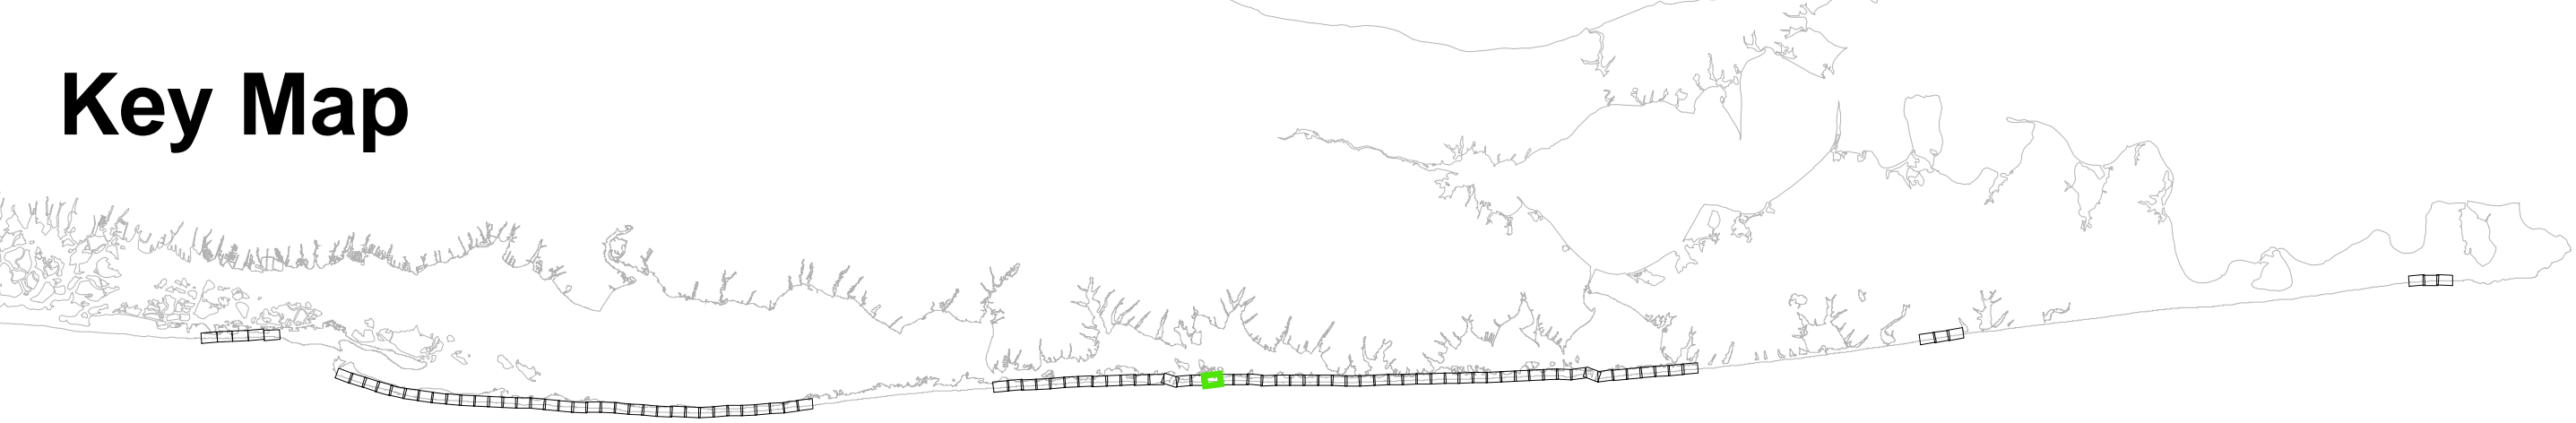


DRAFT		TITLE:		Reference Files:			
Fire IslandInlet to Montauk Point, NY				Designed by: RWH		Checked by:	
Reformulation Study				Drawn by: RWH		Reviewed by:	
				Date: Nov 24, 2015		Submitted by:	
				Plot Scale: AS NOTED		Comm. No.:	
				XXXXX		No. Date	




- Notes:**
1. Parcel data: District - Section
Block - Lot
 2. GRR Parcel Number: **11**
 3. FIMI Parcel Number: **11**
 4. Montauk Parcel Number: **11**
 5. Westhampton Parcel Number: **11**

- Legend:**
- CEHA
 - MIDU_Baseline_20151022
 - Parcels
 - Easement Area
 - Impacted Parcels
- GRR Plan Features
- Landward Toe of Dune
 - Seaward Toe of Dune
 - Seaward Berm Crest
 - Design MHW (2 ft NGVD)
 - Dune - 1st Construction
 - Berm - 1st Construction

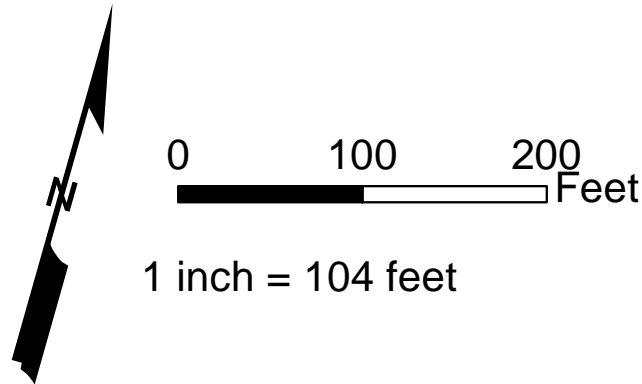

Key Map

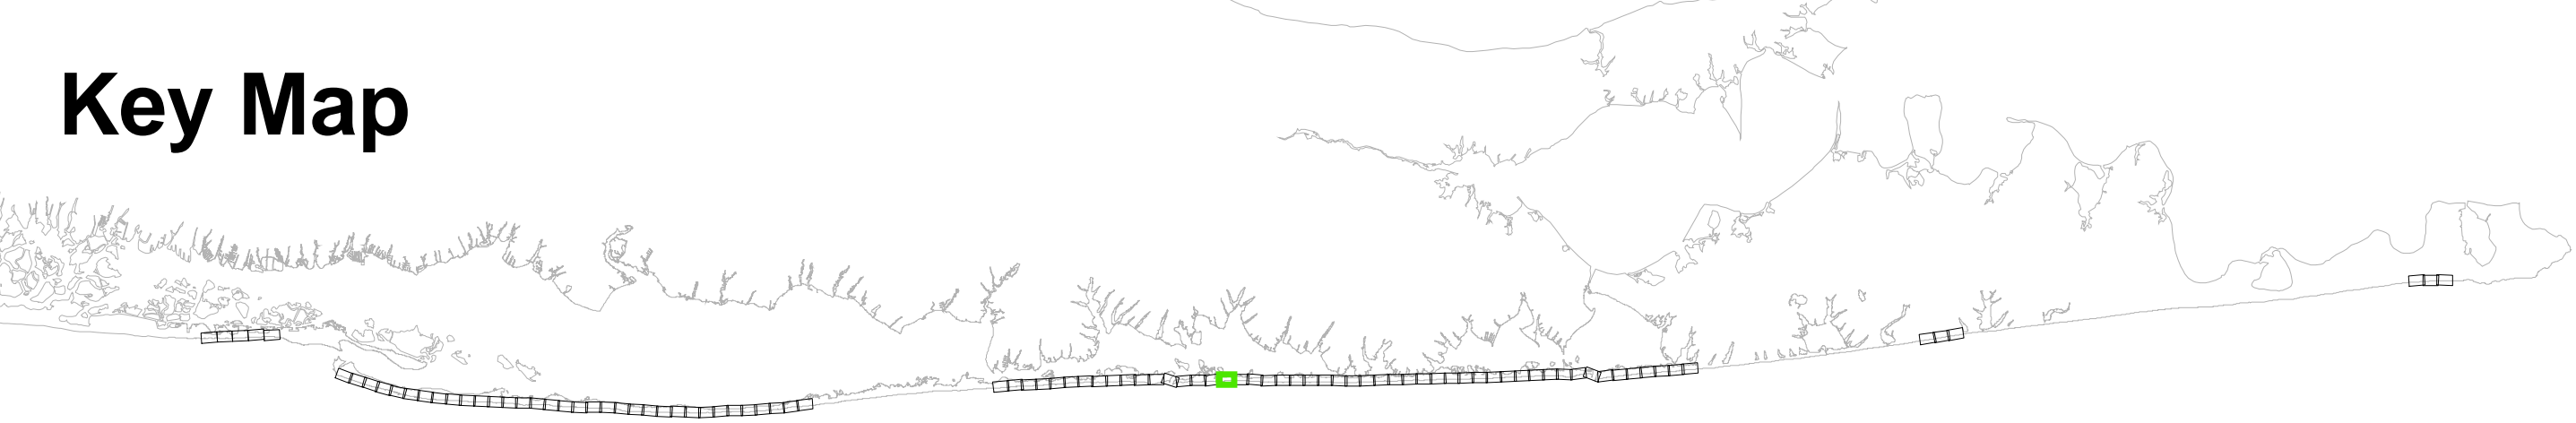

Checked by:		Reviewed by:		Submitted by:		Comm. No.:	
RW		RW		Nov. 18, 2015		XXXX	
Designed by:		Date:		Proj. Scale:		AS NOTED	
Reference Files:		TITLE:		DRAWING NO.:		SHEET 69 OF 95	
DRAFT		Fire Island Inlet to Montauk Point, NY		RE-69			
		Reformulation Study					




Notes:


1. Parcel data: District - Section
Block - Lot
2. GRR Parcel Number: **11**
3. FIMI Parcel Number: **11**
4. Montauk Parcel Number: **11**
5. Westhampton Parcel Number: **11**

Legend:

- CEHA
- MIDU_Baseline_20151022
- Parcels
- Easement Area
- Impacted Parcels
- GRR Plan Features
- Landward Toe of Dune
- Seaward Toe of Dune
- Seaward Berm Crest
- Design MHW (2 ft NGVD)
- Dune - 1st Construction
- Berm - 1st Construction

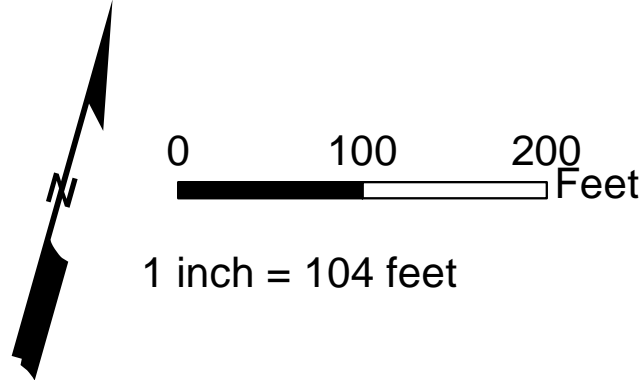

Key Map

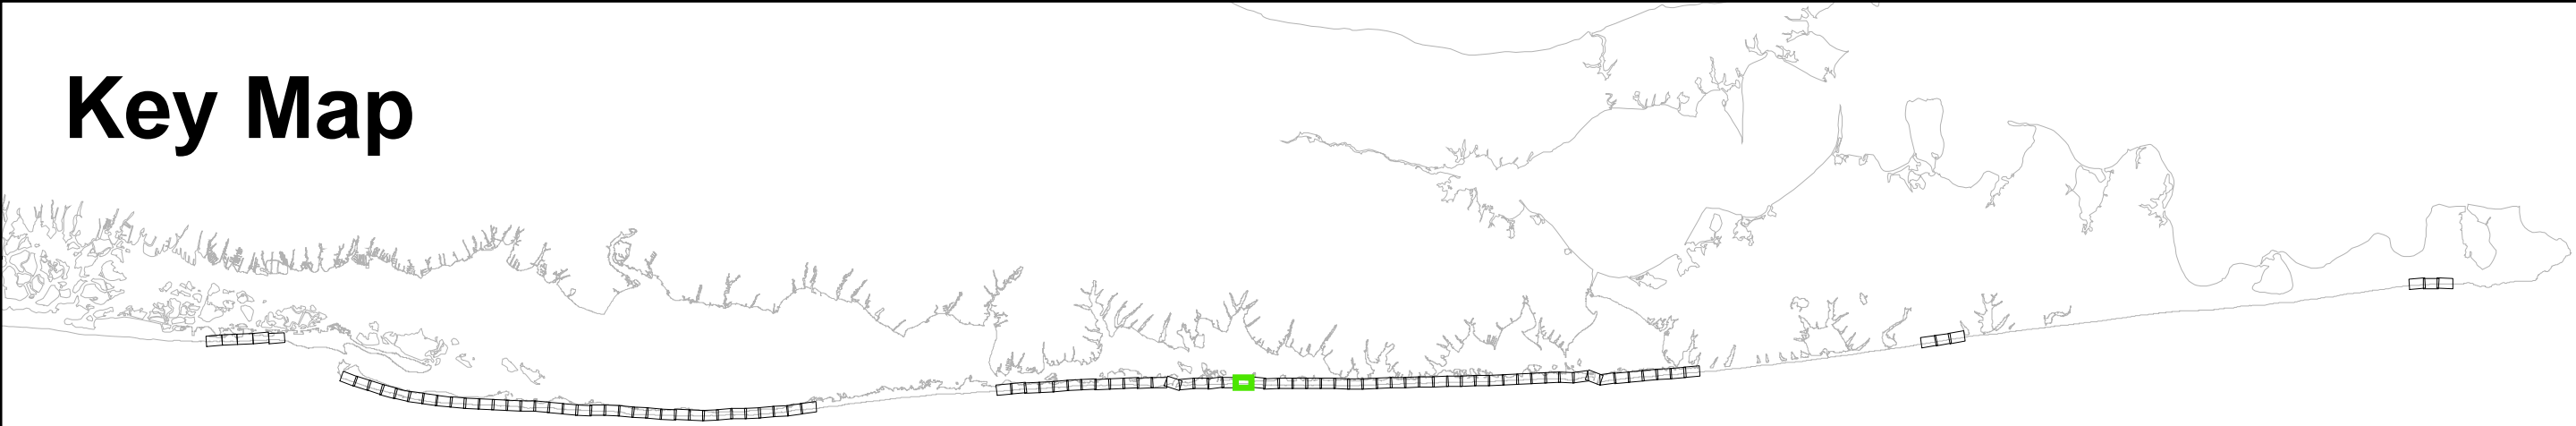


TITLE: <div>DRAFT</div> <div>Fire Island Inlet to Montauk Point, NY Reformulation Study</div>	Reference Files:		Designed by: RW		Checked by:	
			Drawn by: RW		Reviewed by:	
			Date: Nov 18, 2015		Submitted by:	
	Plot Scale: AS NOTED		Comm. No.:			
			XXXXX			
DRAWING NO. <div>RE-70</div>			No.	Date		
SHEET 70 OF 95						




- Notes:**
1. Parcel data: District - Section
Block - Lot
 2. GRR Parcel Number: 11
 3. FIMI Parcel Number: 11
 4. Montauk Parcel Number: 11
 5. Westhampton Parcel Number: 11

- Legend:**
- CEHA
 - MIDU_Baseline_20151022
 - Parcels
 - Easement Area
 - Impacted Parcels
 - GRR Plan Features
 - Landward Toe of Dune
 - Seaward Toe of Dune
 - Seaward Berm Crest
 - Design MHW (2 ft NGVD)
 - Dune - 1st Construction
 - Berm - 1st Construction

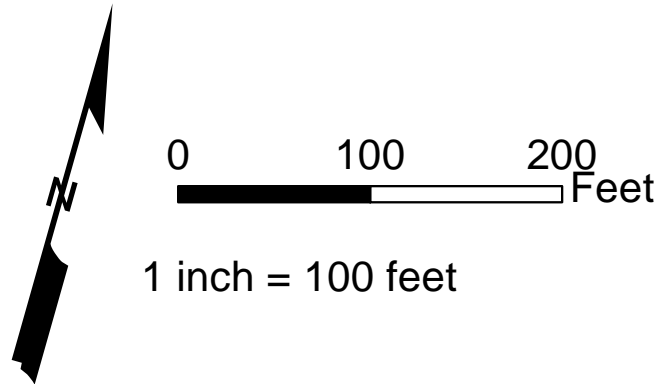

Key Map

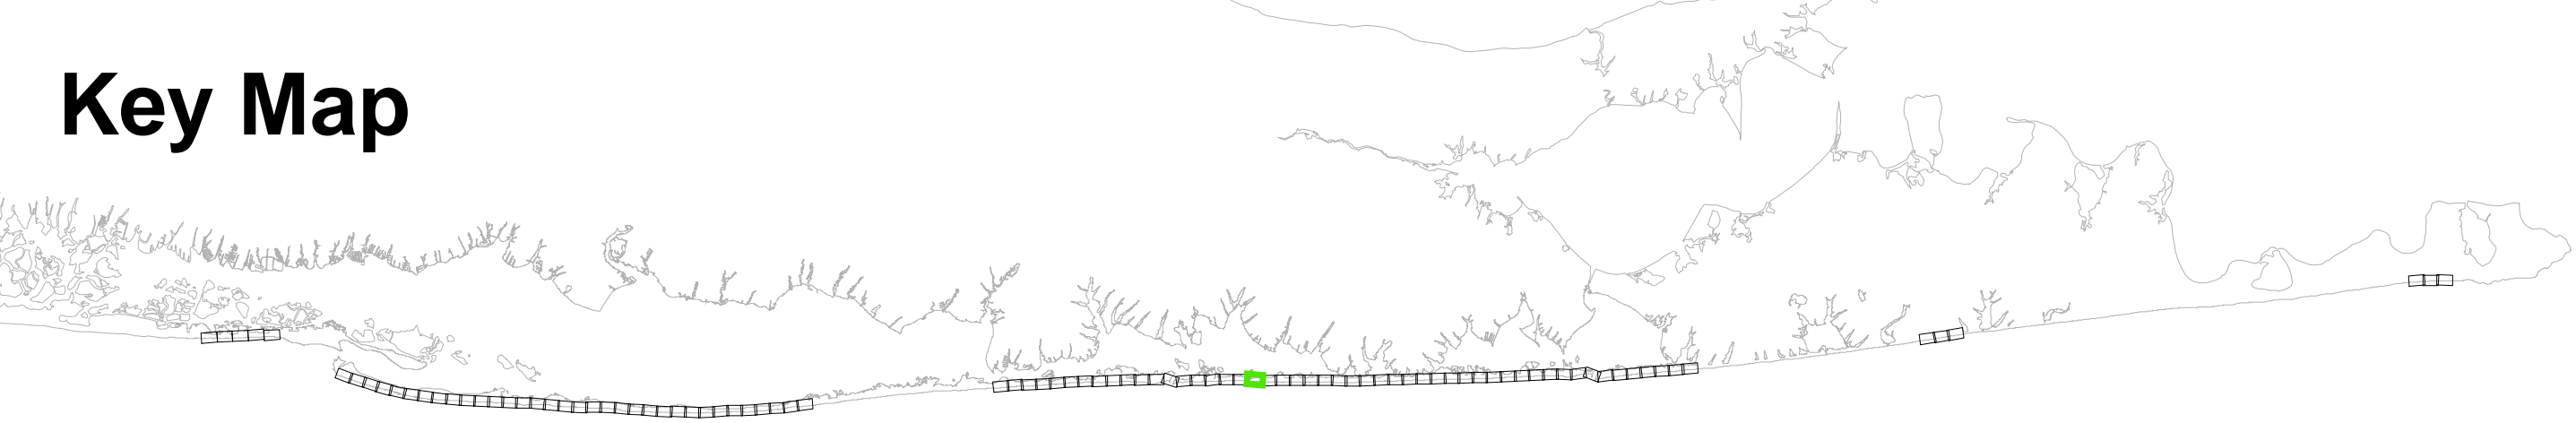

TITLE: DRAFT Fire Island Inlet to Montauk Point, NY Reformulation Study	Reference Files:		Designed by:	RWH	Checked by:	
	Drawn by:		RWH	Reviewed by:		
	Date:		Nov. 24, 2015	Submitted by:		
	Proj. Scale:		AS NOTED	Comm. No.:	XXXXX	
DRAWING NO.		RE-71				
SHEET 71 OF 95						




- Notes:**
- Parcel data: District - Section
Block - Lot
 - GRR Parcel Number: **11**
 - FIMI Parcel Number: **11**
 - Montauk Parcel Number: **11**
 - Westhampton Parcel Number: **11**


Legend:

- CEHA
- MIDU_Baseline_20151022
- Parcels
- Easement Area
- Impacted Parcels

- GRR Plan Features
- Landward Toe of Dune
 - Seaward Toe of Dune
 - Seaward Berm Crest
 - Design MHW (2 ft NGVD)
 - Dune - 1st Construction
 - Berm - 1st Construction

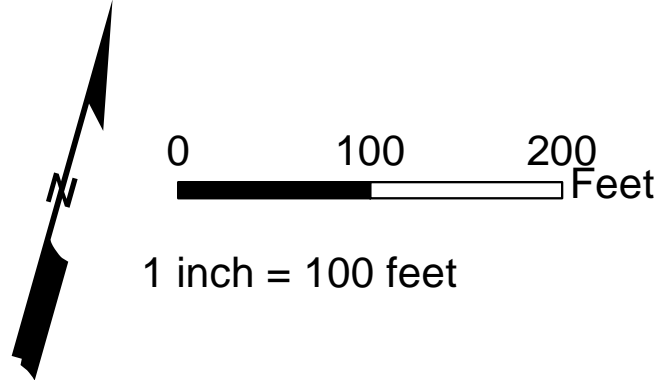

Key Map

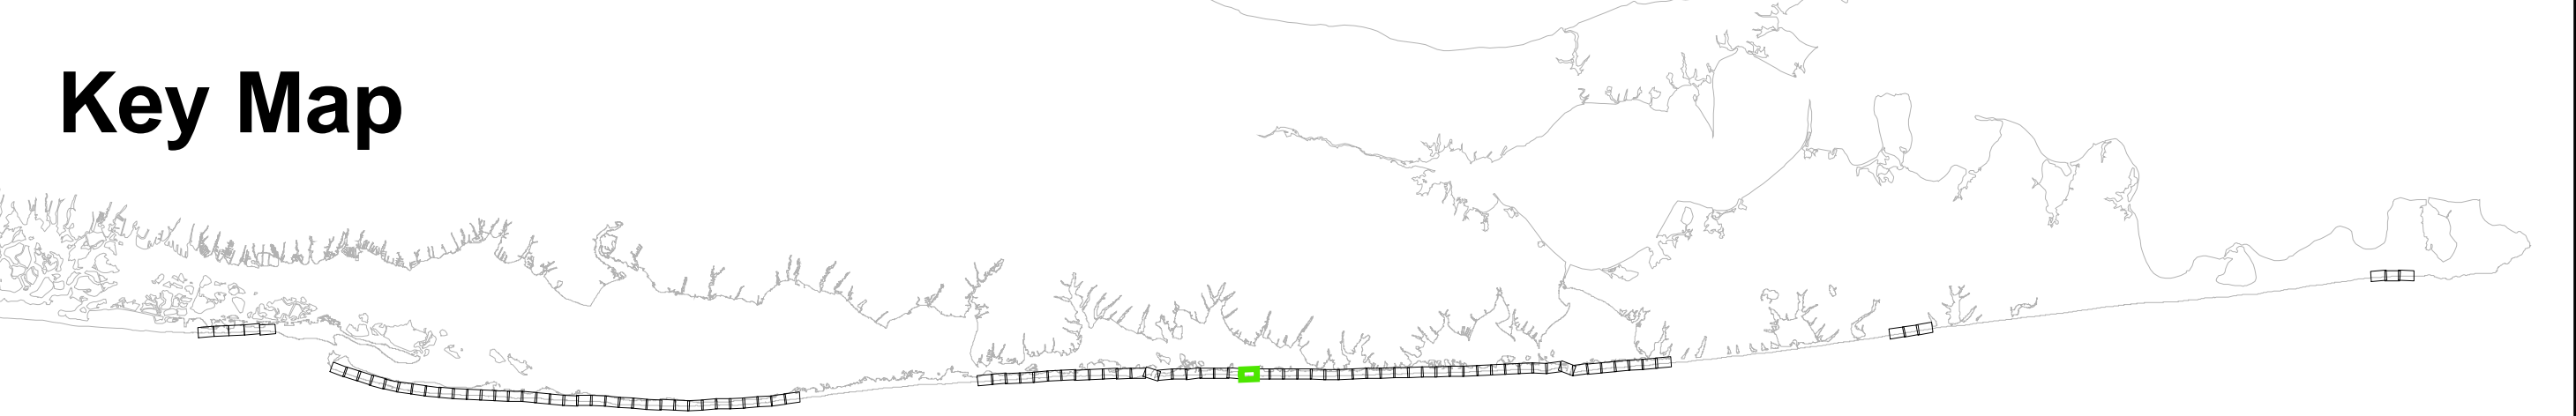

Checked by:		Reviewed by:		Submitted by:		Comm. No.:	
RW		RW		Nov. 24, 2015		XXXXX	
Designed by:		Drawn by:		Date:		Proj. Scale:	
RW		RW		Nov. 24, 2015		AS NOTED	
Reference Files:		Title:		Drawing No.:		Sheet:	
		DRAFT		Fire Island Inlet to Montauk Point, NY		RE-72	
		Reformulation Study				SHEET 72 OF 95	




Notes:

1. Parcel data: District - Section
Block - Lot
2. GRR Parcel Number: **11**
3. FIMI Parcel Number: **11**
4. Montauk Parcel Number: **11**
5. Westhampton Parcel Number: **11**


Legend:

- CEHA
- MIDU_Baseline_20151022
- Parcels
- Easement Area
- Impacted Parcels

- GRR Plan Features
- Landward Toe of Dune
 - Seaward Toe of Dune
 - Seaward Berm Crest
 - Design MHW (2 ft NGVD)
 - Dune - 1st Construction
 - Berm - 1st Construction

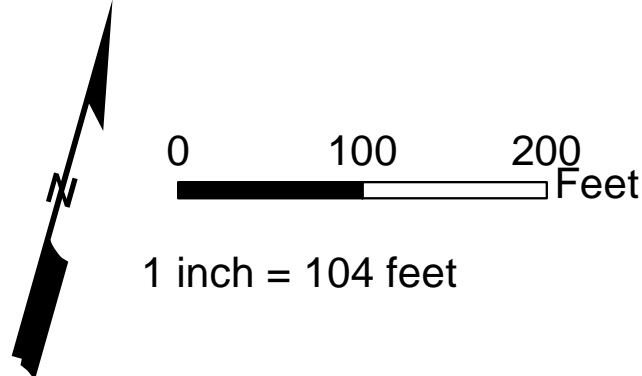

Key Map

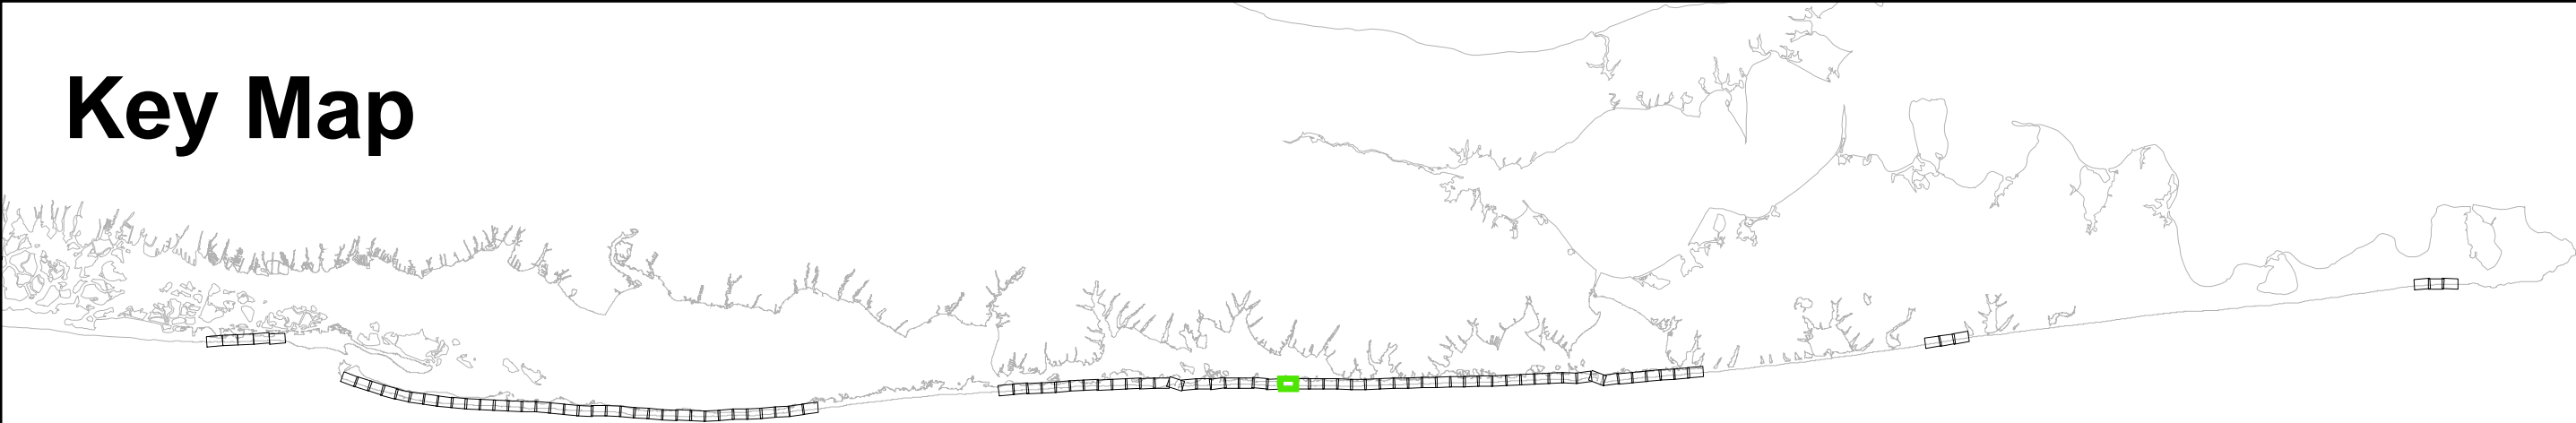

TITLE:		DRAFT		Fire Island Inlet to Montauk Point, NY Reformulation Study	
DRAWING NO.		RE-73		SHEET 73 OF 95	
Reference Files:		Designed by: RWH		Checked by:	
Drawn by: RWH		Reviewed by:		Submitted by:	
Date: Nov. 18, 2015		Comm. No. : XXXXX		No. : 001	
Proj. Scale: 1" = 104'		AS NOTED			




Notes:


1. Parcel data: District - Section
Block - Lot
2. GRR Parcel Number: 11
3. FIMI Parcel Number: 11
4. Montauk Parcel Number: 11
5. Westhampton Parcel Number: 11

Legend:

- CEHA
- MIDU_Baseline_20151022
- Parcels
- Easement Area
- Impacted Parcels
- GRR Plan Features
- Landward Toe of Dune
- Seaward Toe of Dune
- Seaward Berm Crest
- Design MHW (2 ft NGVD)
- Dune - 1st Construction
- Berm - 1st Construction

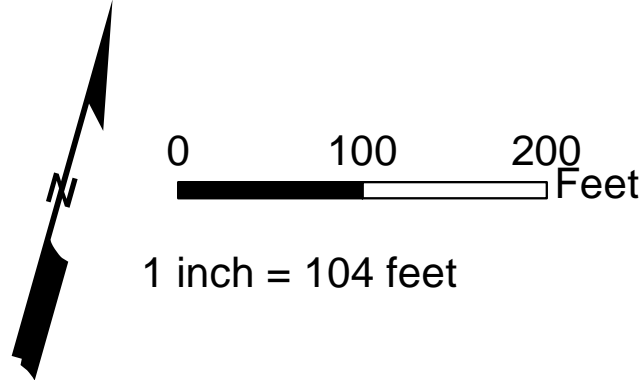

Key Map

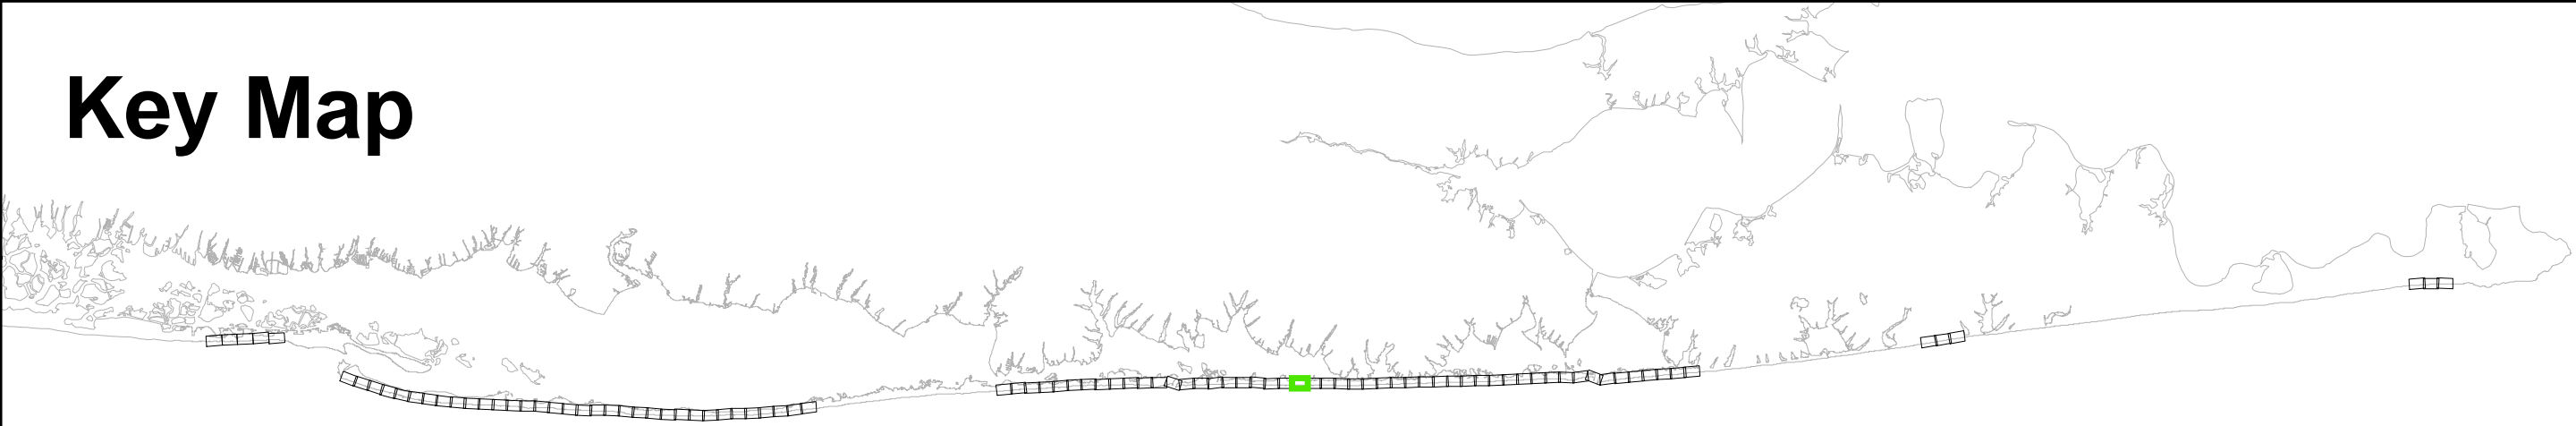

TITLE:		DRAFT		Fire Island Inlet to Montauk Point, NY Reformulation Study	
DRAWING NO.		RE-74		SHEET 74 OF 95	
Reference Files:		Designed by: RWH		Checked by:	
Drawn by: RWH		Reviewed by:		Submitted by:	
Date: Nov. 18, 2015		Comm. No.: XXXXX		No. Date	
Proj. Scale: AS NOTED					



DRAWING NO.		TITLE:		Reference Files:											
RE-75		DRAFT		Designed by: RWH		Checked by:									
SHEET 75 OF 95		Fire IslandInlet to Montauk Point, NY Reformulation Study		Drawn by: RWH		Reviewed by:									
				Date: Nov 18, 2015		Submitted by:									
				Plot Scale: AS NOTED		Comm. No.:									
						XXXXX		No.		Date					



Notes:

1. Parcel data: District - Section
Block - Lot

2. GRR Parcel Number: 11

3. FIMI Parcel Number: 11

4. Montauk Parcel Number: 11

5. Westhampton Parcel Number: 11

Legend:

CEHA

MIDU_Baseline_20151022

Parcels

Easement Area

Impacted Parcels

GRR Plan Features

Landward Toe of Dune

Seaward Toe of Dune

Seaward Berm Crest

Design MHW (2 ft NGVD)

Dune - 1st Construction

Berm - 1st Construction


0

100

200

Feet

1 inch = 104 feet

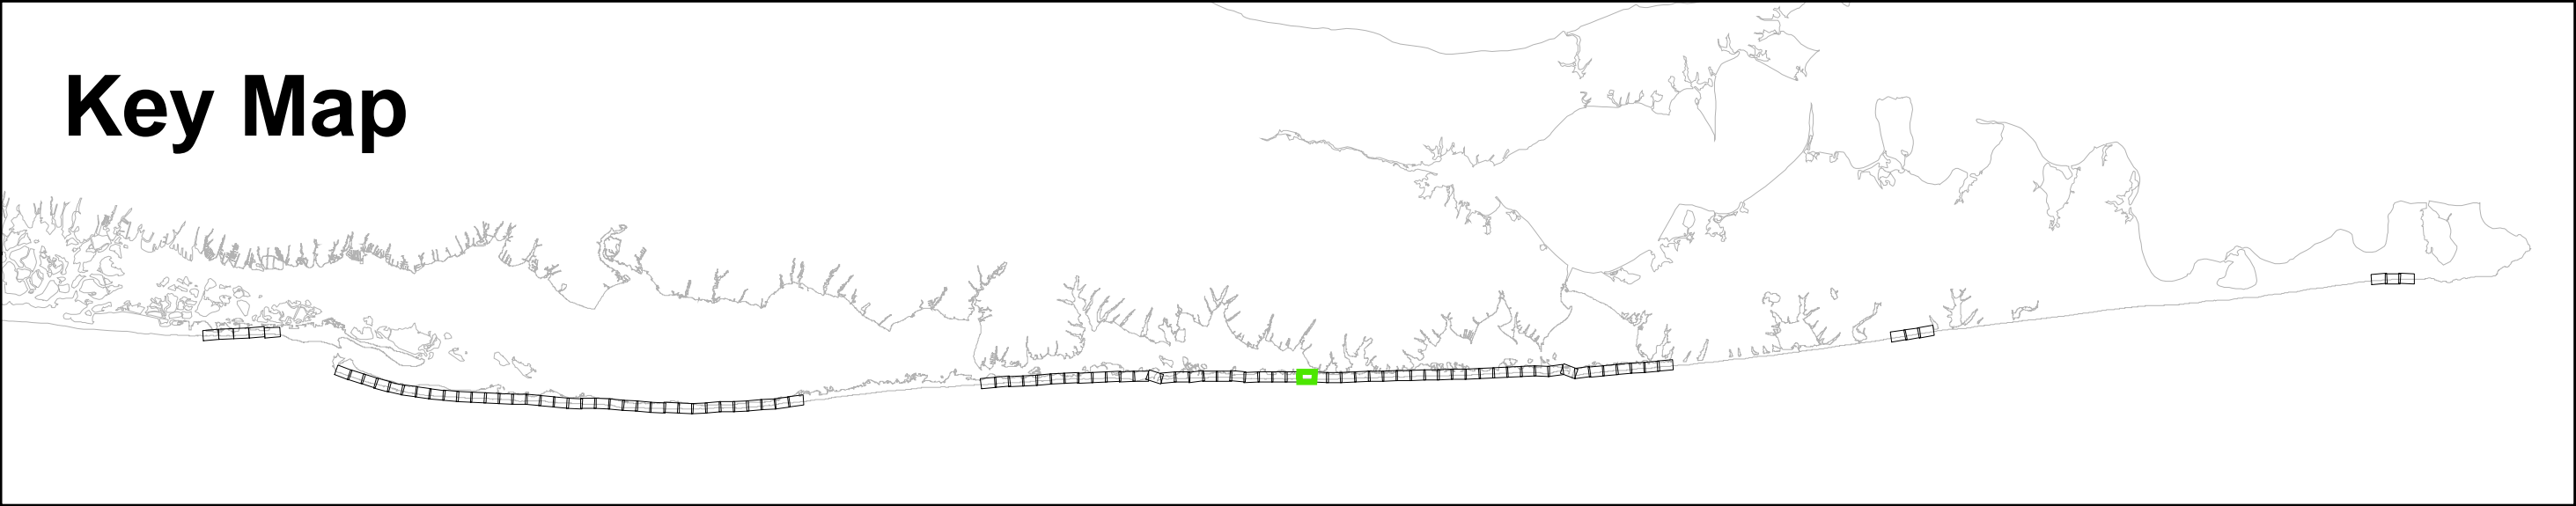



DRAFT		Fire Island Inlet to Montauk Point, NY Reformulation Study	
TITLE:		DRAWING NO.	
RE-76		SHEET 76 OF 95	
Designed by:	RWH	Checked by:	
Drawn by:	RWH	Reviewed by:	
Date:	Nov. 18, 2015	Submitted by:	
Proj. Scale:	AS NOTED	Comm. No.:	XXXXX





- Notes:**
1. Parcel data: District - Section
Block - Lot
 2. GRR Parcel Number: 11
 3. FIMI Parcel Number: 11
 4. Montauk Parcel Number: 11
 5. Westhampton Parcel Number: 11



Legend:


-  CEHA


 MIDU_Baseline_20151022


 Parcels


 Easement Area


 Impacted Parcels
-  Landward Toe of Dune


 Seaward Toe of Dune

 Seaward Berm Crest


 Design MHW (2 ft NGVD)

 Dune - 1st Construction

 Berm - 1st Construction

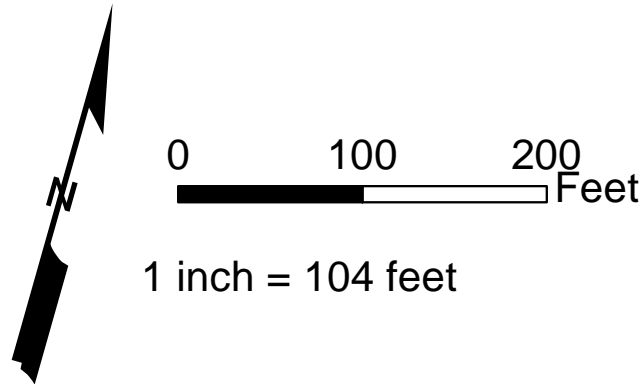

Key Map

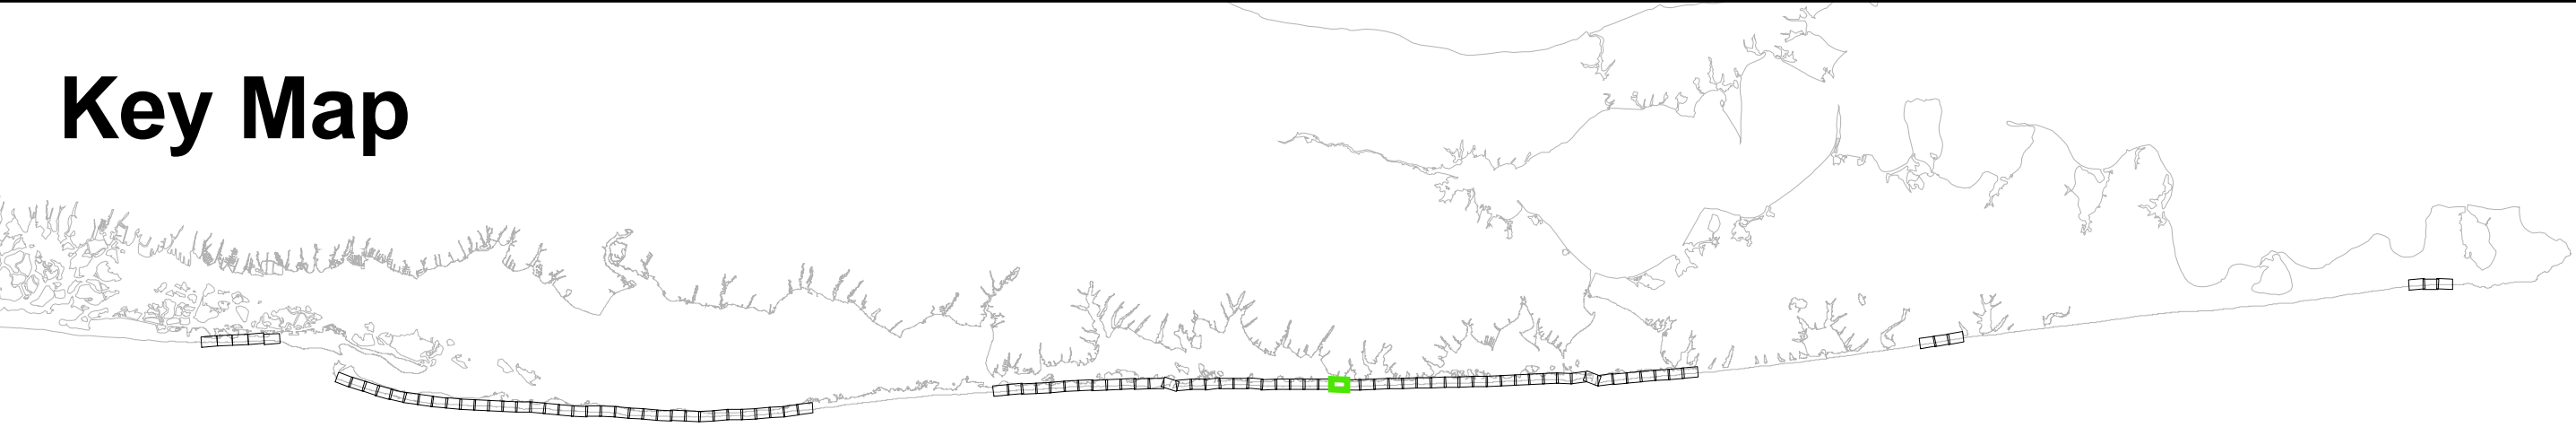

TITLE:		DRAFT		Fire Island Inlet to Montauk Point, NY Reformulation Study	
DRAWING NO.		RE-77		SHEET 77 OF 95	
Reference Files:		Designed by: RWH		Checked by:	
Drawn by: RWH		Reviewed by:		No.	
Date: Nov. 18, 2015		Submitted by:		Date:	
Proj. Scale: PLS NOTED		Comm. No.: XXXXX		No.	




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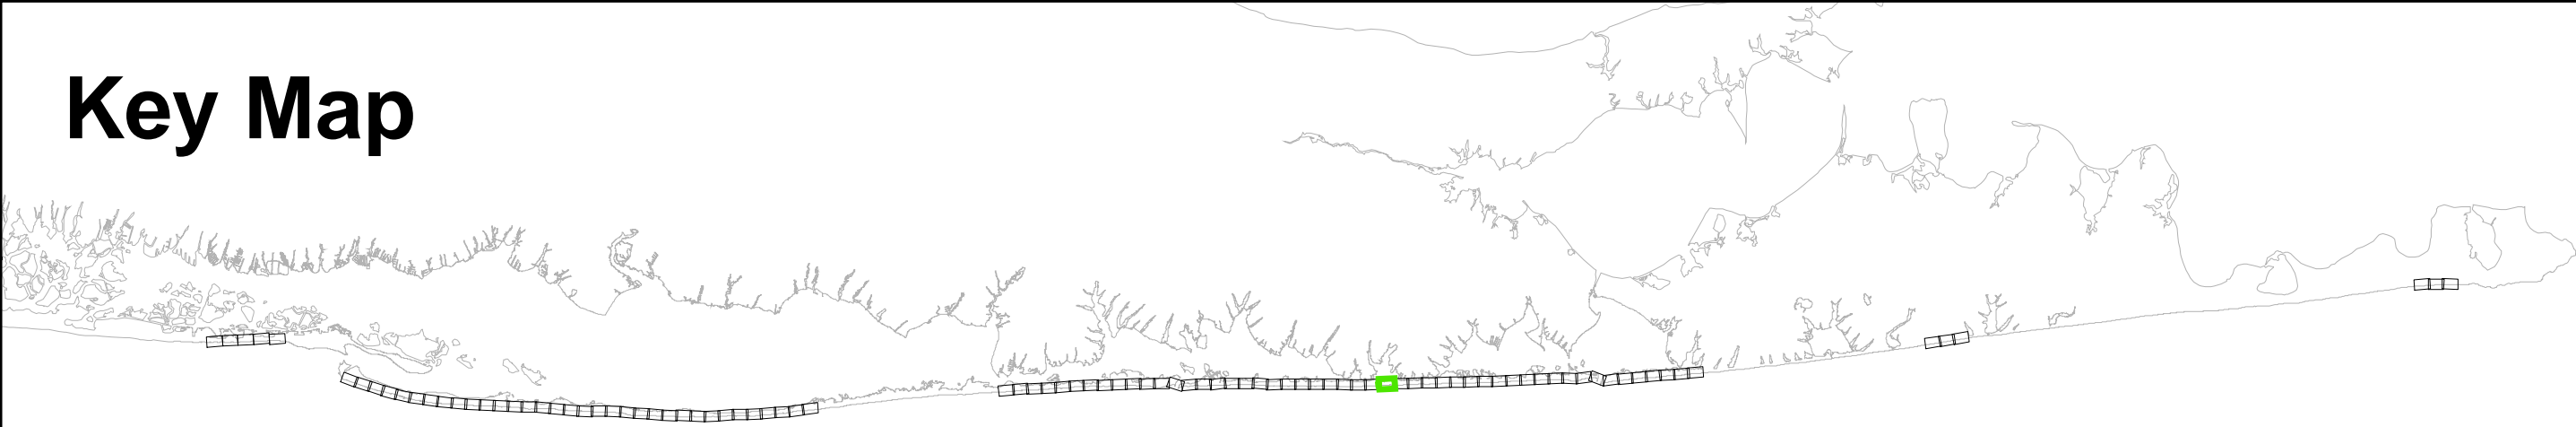
1. Parcel data: District - Section
Block - Lot
2. GRR Parcel Number: 11
3. FIMI Parcel Number: 11
4. Montauk Parcel Number: 11
5. Westhampton Parcel Number: 11

Legend:

- CEHA
- MIDU_Baseline_20151022
- Parcels
- Easement Area
- Impacted Parcels
- GRR Plan Features
- Landward Toe of Dune
- Seaward Toe of Dune
- Seaward Berm Crest
- Design MHW (2 ft NGVD)
- Dune - 1st Construction
- Berm - 1st Construction

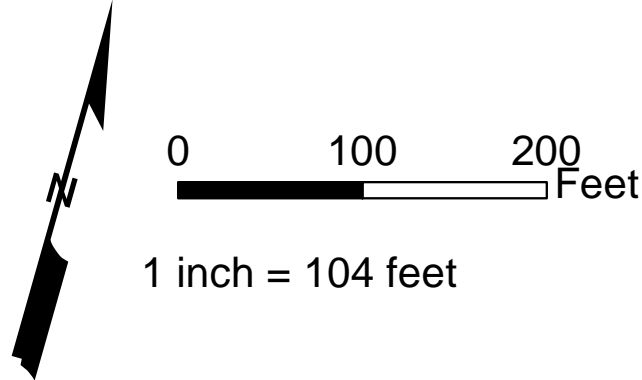

Key Map



TITLE:		DRAFT		Fire Island Inlet to Montauk Point, NY Reformulation Study	
DRAWING NO.		RE-80		SHEET 80 OF 95	
Reference Files:		Designed by: RWH		Checked by:	
Drawn by: RWH		Reviewed by:		No.	
Date: Nov. 18, 2015		Submitted by:		Date:	
Proj. Scale: AS NOTED		Comm. No.: XXXXX		No.	




Notes:

1. Parcel data: District - Section
Block - Lot
2. GRR Parcel Number: 11
3. FIMI Parcel Number: 11
4. Montauk Parcel Number: 11
5. Westhampton Parcel Number: 11

Legend:

- CEHA
- MIDU_Baseline_20151022
- Parcels
- Easement Area
- Impacted Parcels
- GRR Plan Features
- Landward Toe of Dune
- Seaward Toe of Dune
- Seaward Berm Crest
- Design MHW (2 ft NGVD)
- Dune - 1st Construction
- Berm - 1st Construction

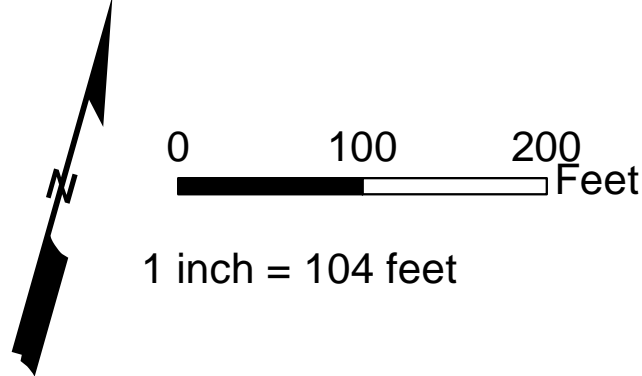

Key Map




DRAFT		Fire Island Inlet to Montauk Point, NY Reformulation Study	
TITLE:		DRAWING NO.	
RE-81		SHEET 81 OF 95	
Designed by:	RWH	Checked by:	
Drawn by:	RWH	Reviewed by:	
Date:	Nov. 18, 2015	Submitted by:	
Proj. Status:	PLS NOTED	Comm. No.:	XXXXX




- Notes:**
1. Parcel data: District - Section
Block - Lot
 2. GRR Parcel Number: **11**
 3. FIMI Parcel Number: **11**
 4. Montauk Parcel Number: **11**
 5. Westhampton Parcel Number: **11**

Legend:

- CEHA
 - MIDU_Baseline_20151022
 - Parcels
 - Easement Area
 - Impacted Parcels
- GRR Plan Features
- Landward Toe of Dune
 - Seaward Toe of Dune
 - Seaward Berm Crest
 - Design MHW (2 ft NGVD)
 - Dune - 1st Construction
 - Berm - 1st Construction

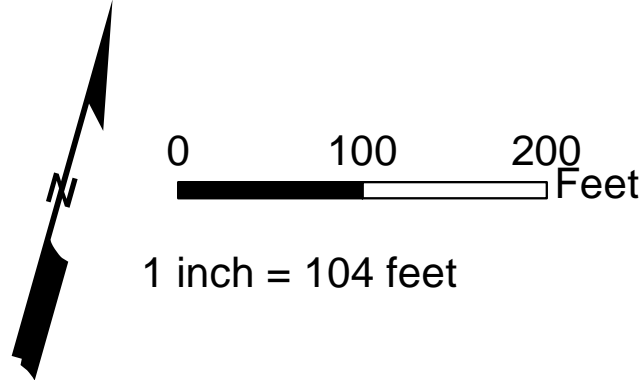

Key Map

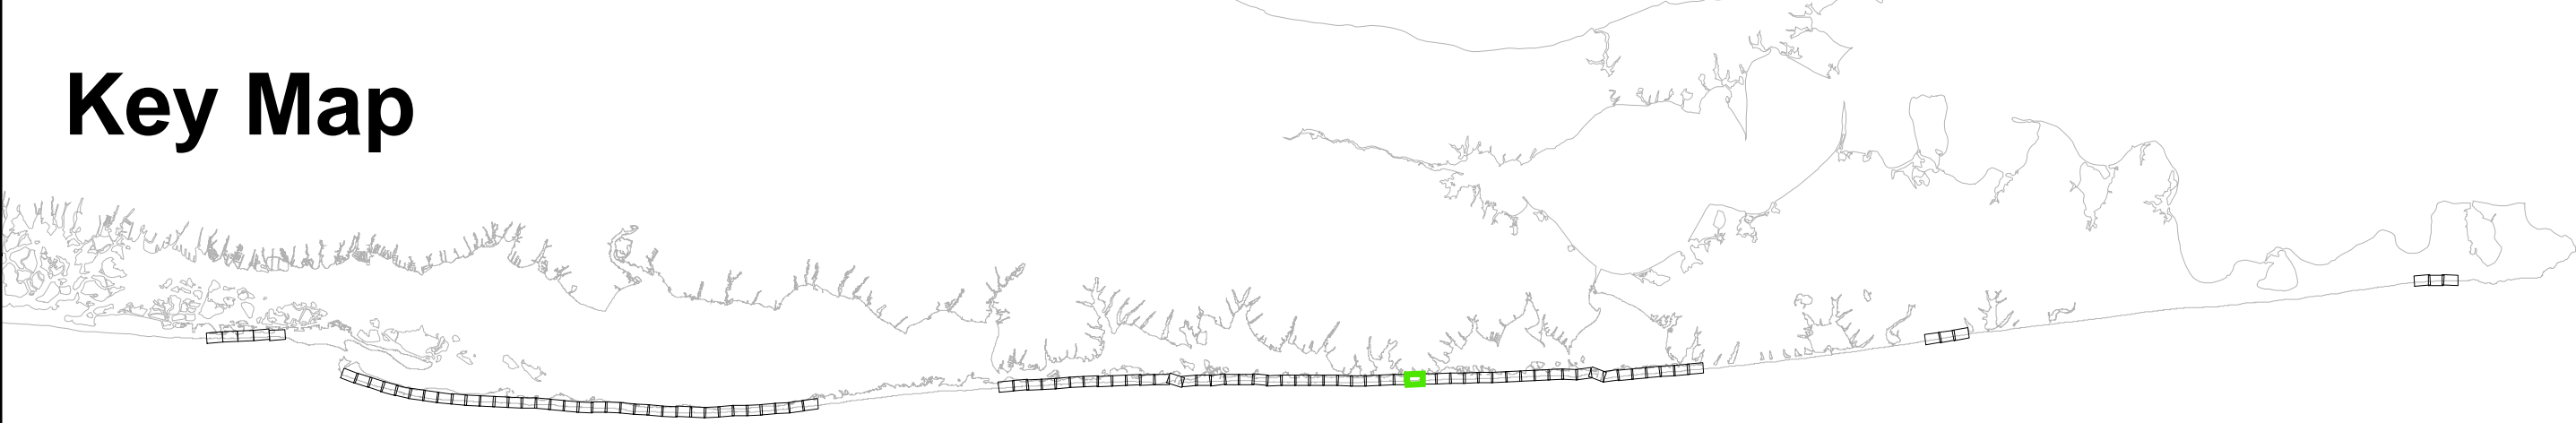

TITLE:		DRAFT		Fire Island Inlet to Montauk Point, NY Reformulation Study	
DRAWING NO.		RE-82		SHEET 82 OF 95	
Reference Files:		Designed by: RWH		Checked by:	
		Drawn by: RWH		Reviewed by:	
		Date: Nov. 18, 2015		Submitted by:	
		Proj. Scale: AS NOTED		Comm. No.: XXXXX	



Notes:

1. Parcel data: District - Section
Block - Lot
2. GRR Parcel Number: **11**
3. FIMI Parcel Number: **11**
4. Montauk Parcel Number: **11**
5. Westhampton Parcel Number: **11**

Legend:


- CEHA
- MIDU_Baseline_20151022
- Parcels
- Easement Area
- Impacted Parcels

- GRR Plan Features
- Landward Toe of Dune
 - Seaward Toe of Dune
 - Seaward Berm Crest
 - Design MHW (2 ft NGVD)
 - Dune - 1st Construction
 - Berm - 1st Construction



0 100 200 Feet
1 inch = 104 feet

Key Map

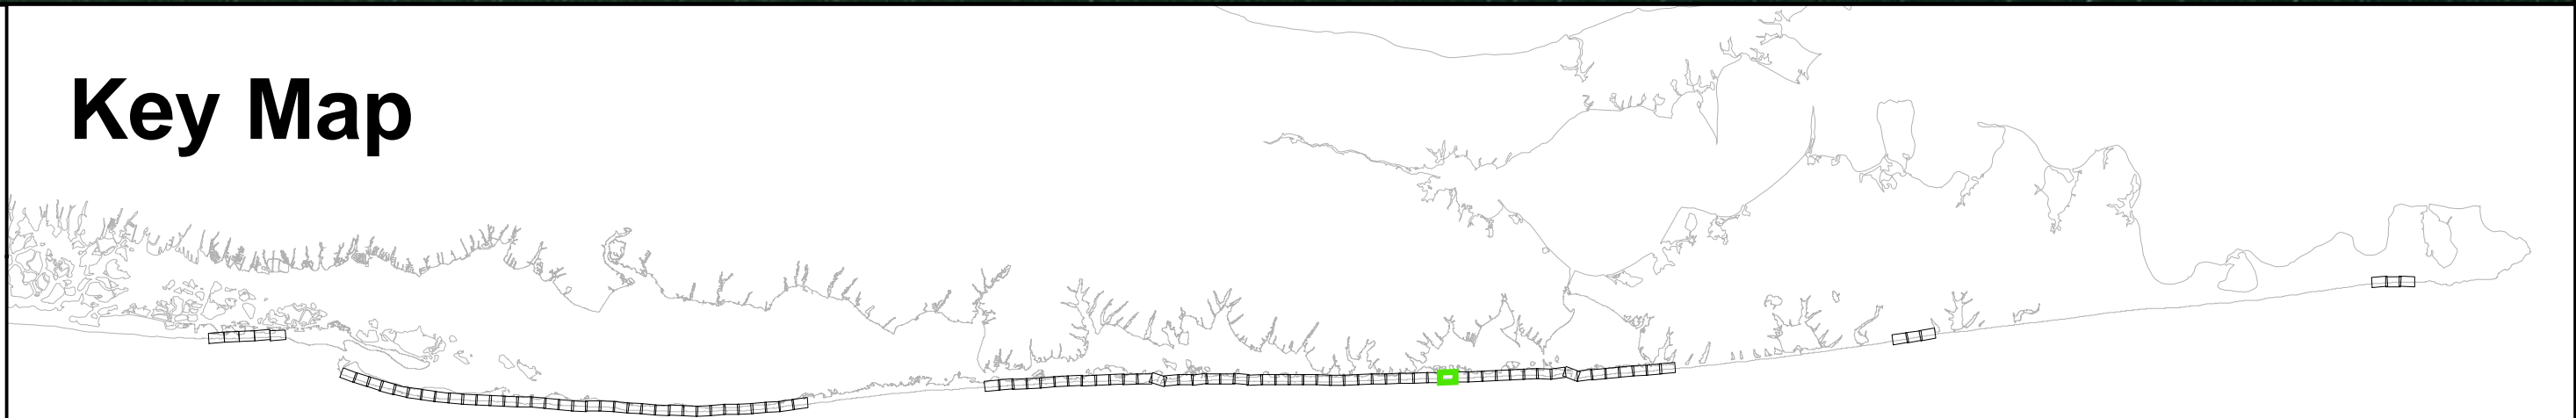

TITLE:		DRAFT		Fire Island Inlet to Montauk Point, NY Reformulation Study	
DRAWING NO.		RE-86		SHEET 86 OF 95	
Reference Files:		Designed by: RWH		Checked by:	
Drawn by: RWH		Reviewed by:		No.	
Date: Nov. 18, 2015		Submitted by:		Date:	
Proj. Scale: AS NOTED		Comm. No.: XXXXX		No.	




Notes:


1. Parcel data: District - Section
Block - Lot
2. GRR Parcel Number: **11**
3. FIMI Parcel Number: **11**
4. Montauk Parcel Number: **11**
5. Westhampton Parcel Number: **11**

Legend:

- CEHA
 - MIDU_Baseline_20151022
 - Parcels
 - Easement Area
 - Impacted Parcels
- GRR Plan Features
- Landward Toe of Dune
 - Seaward Toe of Dune
 - Seaward Berm Crest
 - Design MHW (2 ft NGVD)
 - Dune - 1st Construction
 - Berm - 1st Construction

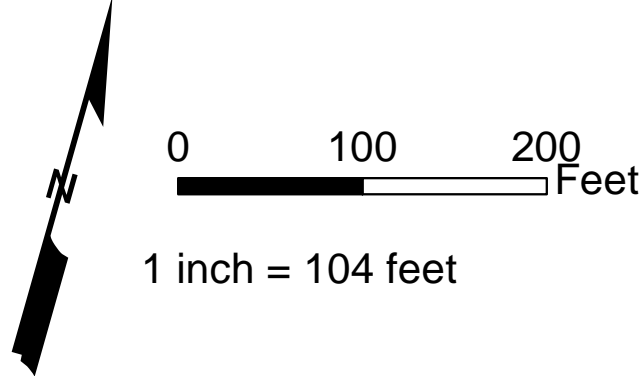

Key Map

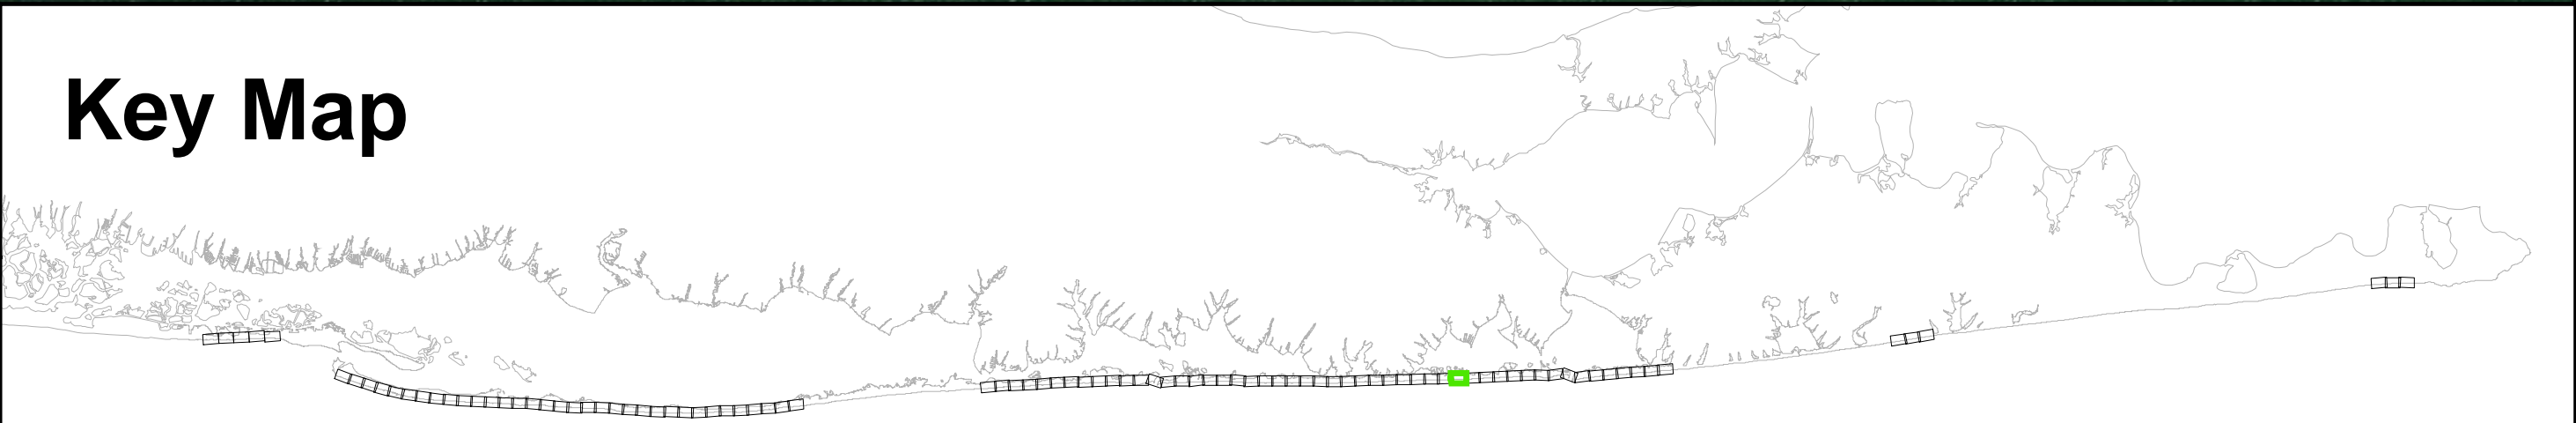

TITLE:		DRAFT		Fire Island Inlet to Montauk Point, NY Reformulation Study	
DRAWING NO.		RE-87		SHEET 87 OF 95	
Reference Files:		Designed by: RWH		Checked by:	
		Drawn by: RWH		Reviewed by:	
		Date: Nov. 18, 2015		Submitted by:	
		Proj. Scale: AS NOTED		Comm. No.: XXXXX	




Notes:


1. Parcel data: District - Section
Block - Lot
2. GRR Parcel Number: **11**
3. FIMI Parcel Number: **11**
4. Montauk Parcel Number: **11**
5. Westhampton Parcel Number: **11**

Legend:

- CEHA
- MIDU_Baseline_20151022
- Parcels
- Easement Area
- Impacted Parcels
- GRR Plan Features
- Landward Toe of Dune
- Seaward Toe of Dune
- Seaward Berm Crest
- Design MHW (2 ft NGVD)
- Dune - 1st Construction
- Berm - 1st Construction

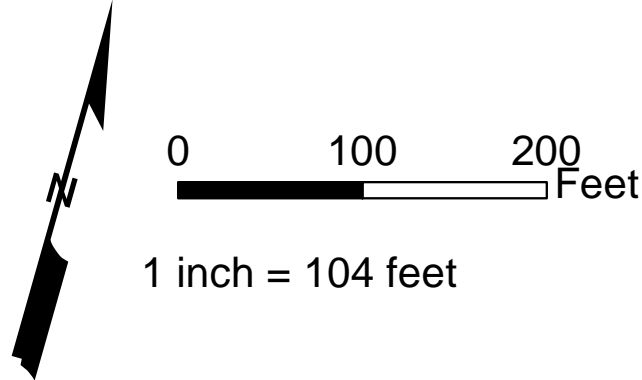

Key Map

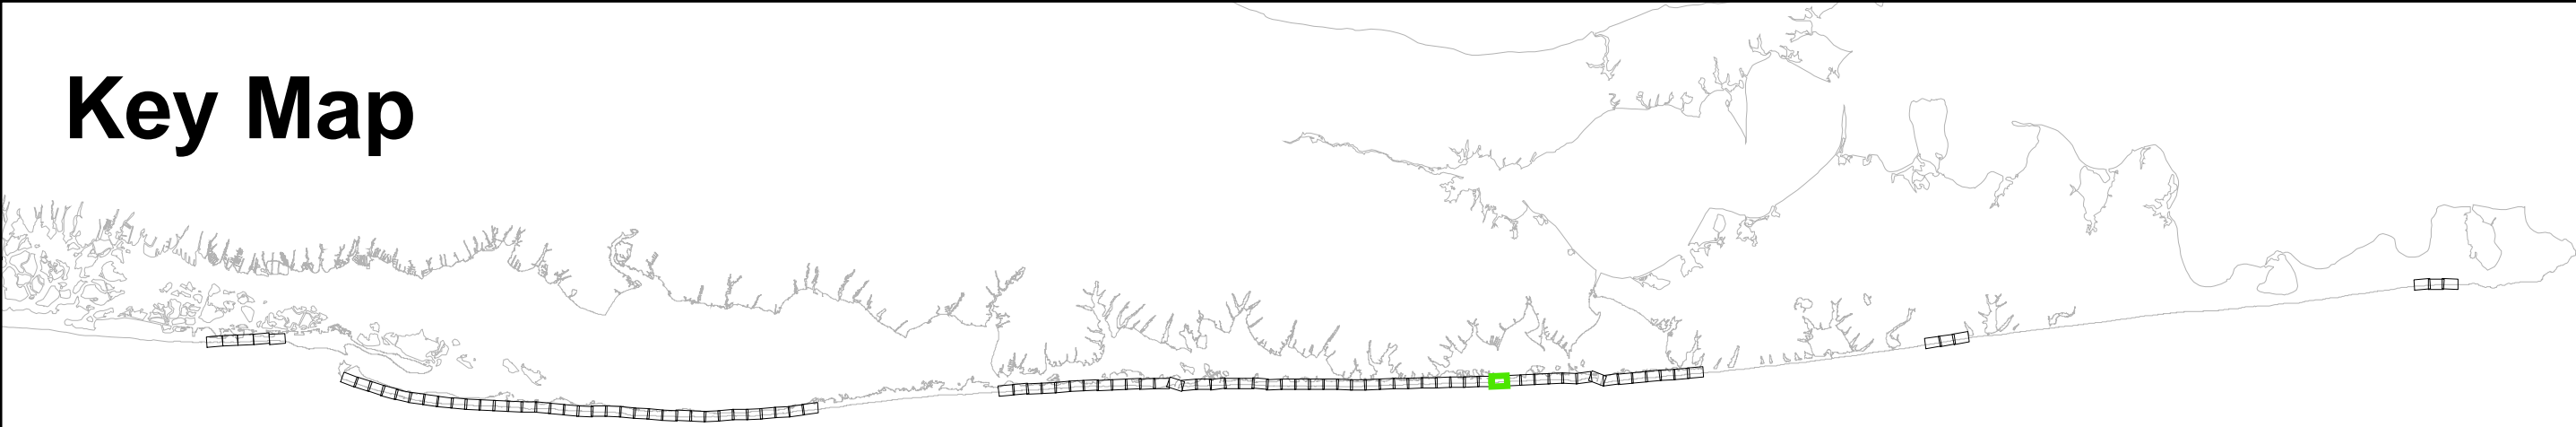

DRAFT		Fire Island Inlet to Montauk Point, NY Reformulation Study	
TITLE:		DRAWING NO.	
RE-88		SHEET 88 OF 95	
Designed by:	RWH	Checked by:	
Drawn by:	RWH	Reviewed by:	
Date:	Nov. 18, 2015	Submitted by:	
Proj. Scale:	AS NOTED	Comm. No.:	XXXXX




Notes:


1. Parcel data: District - Section
Block - Lot
2. GRR Parcel Number: **11**
3. FIMI Parcel Number: **11**
4. Montauk Parcel Number: **11**
5. Westhampton Parcel Number: **11**

Legend:

- CEHA
 - MIDU_Baseline_20151022
 - Parcels
 - Easement Area
 - Impacted Parcels
- GRR Plan Features
- Landward Toe of Dune
 - Seaward Toe of Dune
 - Seaward Berm Crest
 - Design MHW (2 ft NGVD)
 - Dune - 1st Construction
 - Berm - 1st Construction

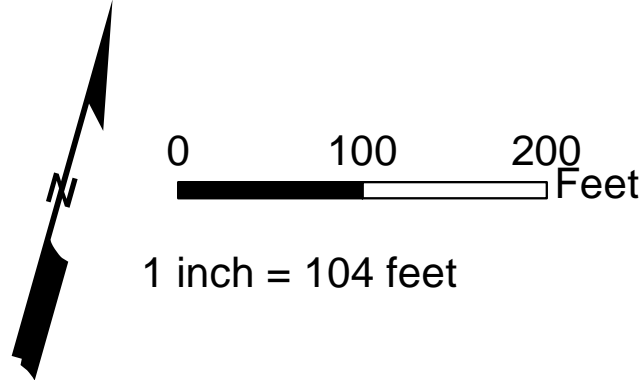

Key Map

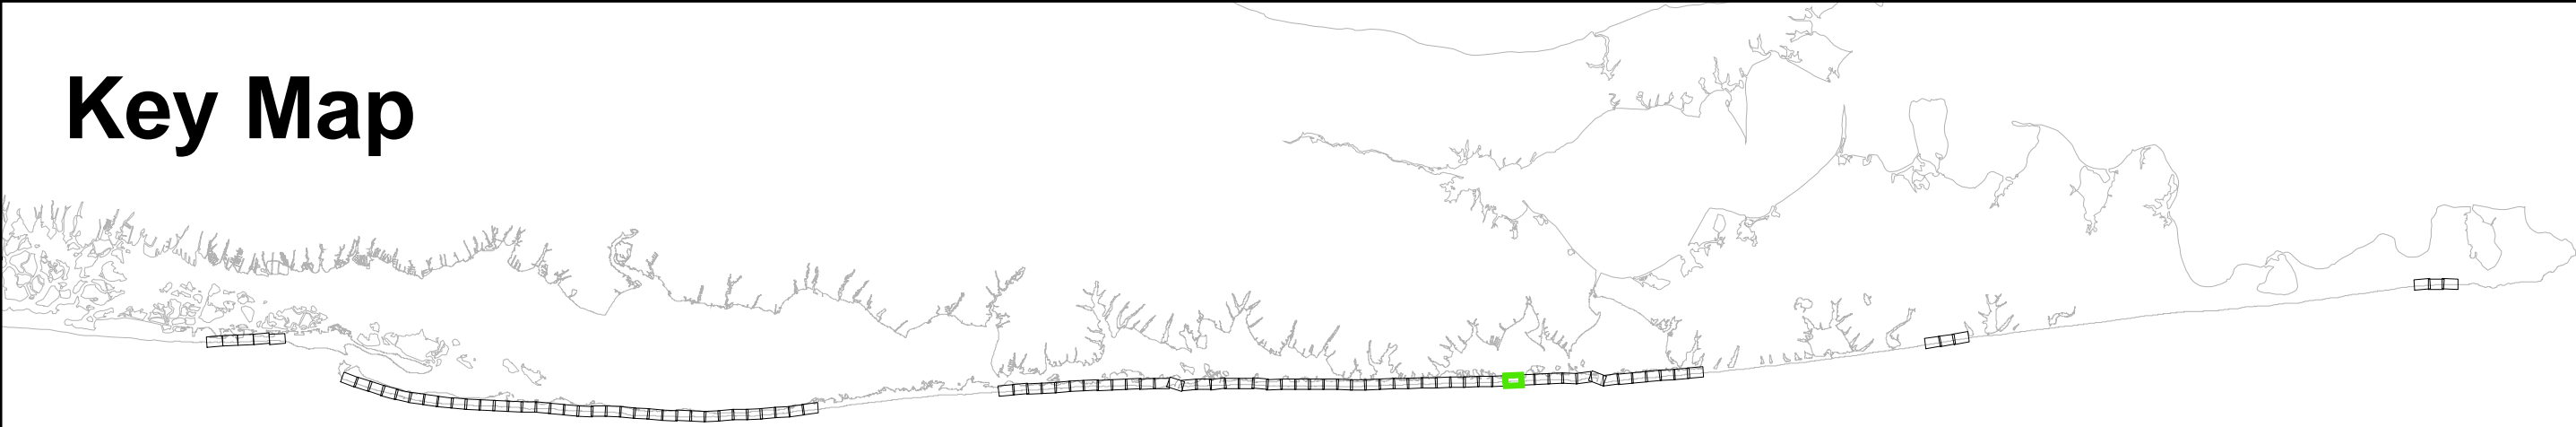

TITLE:		DRAFT		Fire Island Inlet to Montauk Point, NY Reformulation Study	
DRAWING NO.		RE-89		SHEET 89 OF 95	
Reference Files:		Designed by: RWH		Checked by:	
		Drawn by: RWH		Reviewed by:	
		Date: Nov. 18, 2015		Submitted by:	
		Proj. Scale: AS NOTED		Comm. No.: XXXXX	




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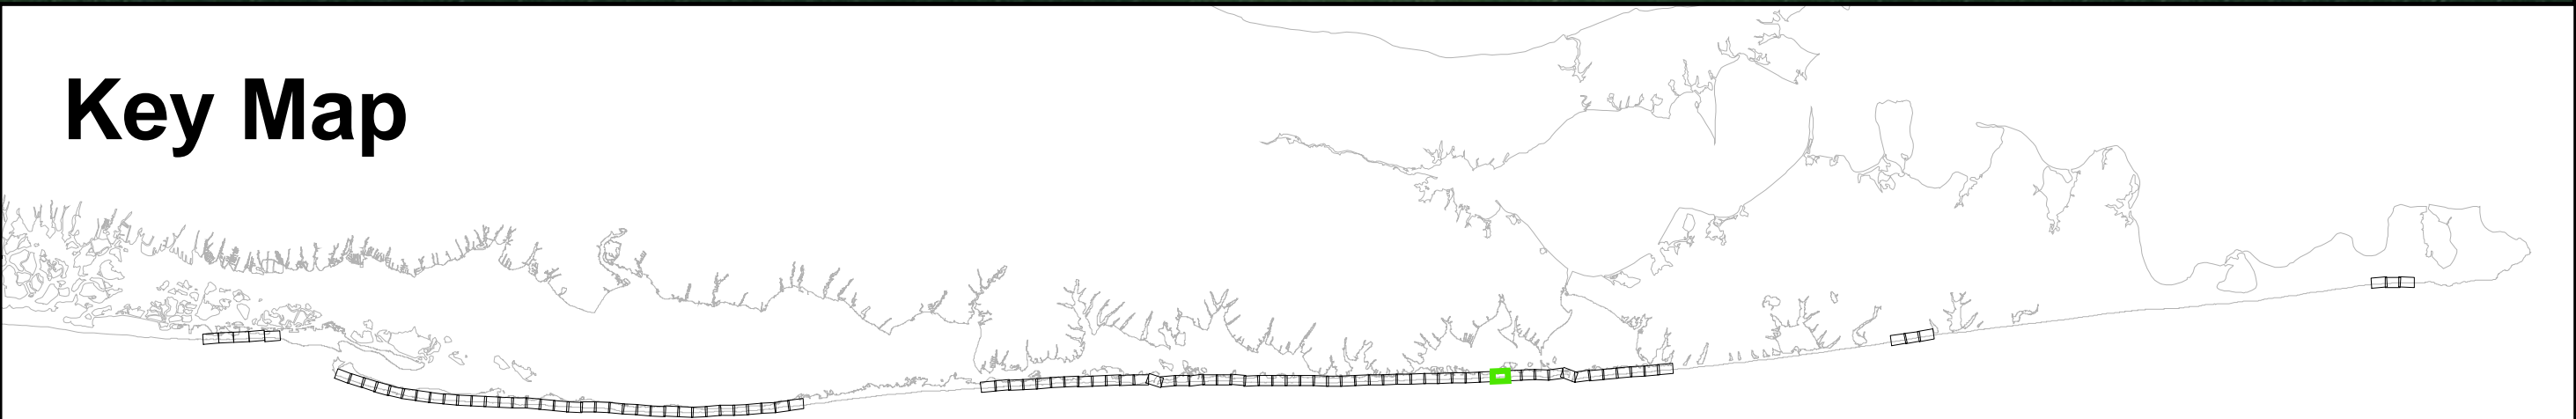
1. Parcel data: District - Section
Block - Lot
2. GRR Parcel Number: **11**
3. FIMI Parcel Number: **11**
4. Montauk Parcel Number: **11**
5. Westhampton Parcel Number: **11**

Legend:

- | | |
|------------------------|-------------------------|
| CEHA | Landward Toe of Dune |
| MIDU_Baseline_20151022 | Seaward Toe of Dune |
| Parcels | Seaward Berm Crest |
| Easement Area | Design MHW (2 ft NGVD) |
| Impacted Parcels | Dune - 1st Construction |
| | Berm - 1st Construction |

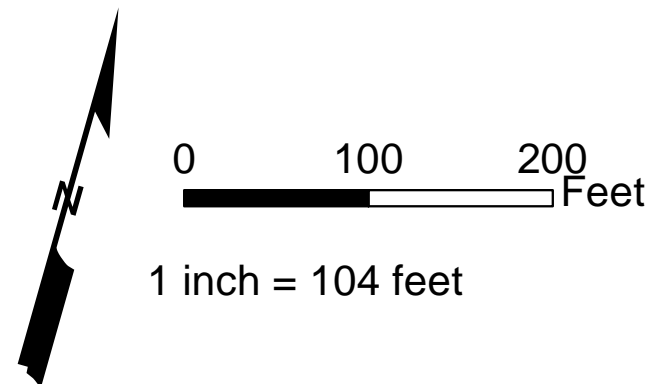

Key Map



DRAFT				TITLE: Fire Island Inlet to Montauk Point, NY Reformulation Study			
DRAWING NO. RE-90				SHEET 90 OF 95			
Designed by:		Checked by:		Reference Files:		Revision	
Drawn by:		Reviewed by:		No.		Date	
Date:		Submitted by:		Comm. No.:		XXXXX	
Proj. Scale:		AS NOTED					




Notes:

1. Parcel data: District - Section
Block - Lot
2. GRR Parcel Number: **11**
3. FIMI Parcel Number: **11**
4. Montauk Parcel Number: **11**
5. Westhampton Parcel Number: **11**

Legend:

- | | |
|------------------------|-------------------------|
| CEHA | Landward Toe of Dune |
| MIDU_Baseline_20151022 | Seaward Toe of Dune |
| Parcels | Seaward Berm Crest |
| Easement Area | Design MHW (2 ft NGVD) |
| Impacted Parcels | Dune - 1st Construction |
| | Berm - 1st Construction |

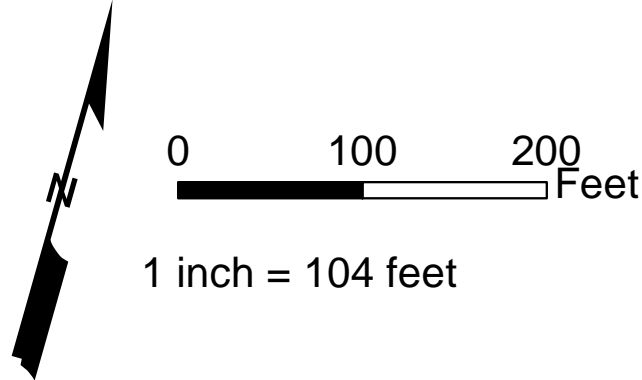

Key Map




TITLE: DRAFT Fire Island Inlet to Montauk Point, NY Reformulation Study				DRAWING NO. RE-91			
Reference Files:				SHEET 91 OF 95			
Designed by:		Checked by:		Drawn by:		Reviewed by:	
RW		RW		RW		RW	
Date:		Date:		Date:		Date:	
Nov. 18, 2015		Nov. 18, 2015		Nov. 18, 2015		Nov. 18, 2015	
Proj. Scale:		Comm. No.:		Proj. Scale:		Comm. No.:	
AS NOTED		XXXX		AS NOTED		XXXX	




- Notes:**
- Parcel data: District - Section
Block - Lot
 - GRR Parcel Number: 11
 - FIMI Parcel Number: 11
 - Montauk Parcel Number: 11
 - Westhampton Parcel Number: 11

- Legend:**
- CEHA
 - MIDU_Baseline_20151022
 - Parcels
 - Easement Area
 - Impacted Parcels
 - GRR Plan Features
 - Landward Toe of Dune
 - Seaward Toe of Dune
 - Seaward Berm Crest
 - Design MHW (2 ft NGVD)
 - Dune - 1st Construction
 - Berm - 1st Construction

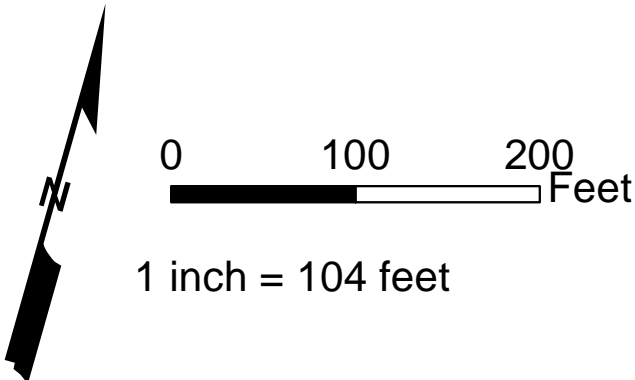

Key Map

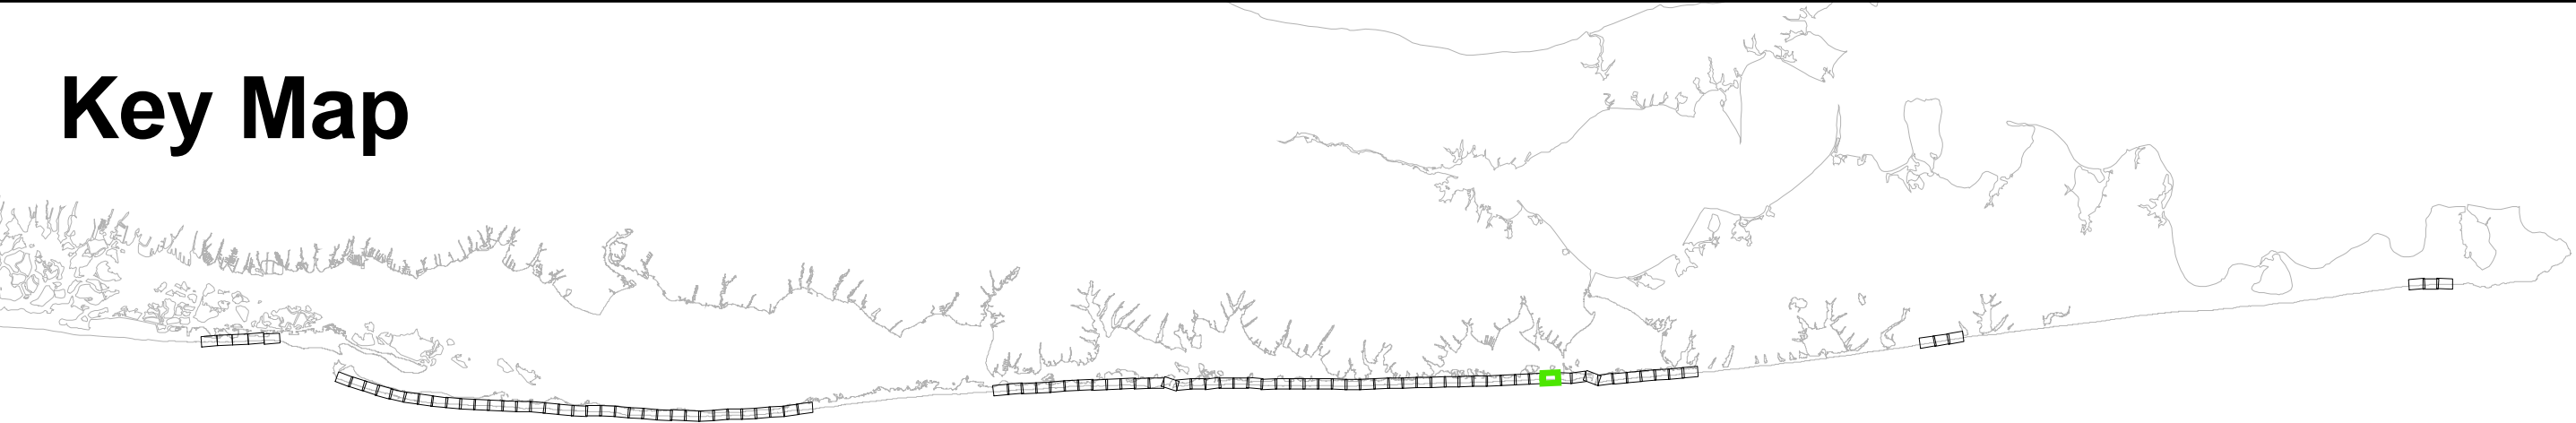

DRAFT									
TITLE: Fire Island Inlet to Montauk Point, NY Reformulation Study									
DRAWING NO. RE-92									
SHEET 92 OF 95									
Reference Files:		Designed by:		Checked by:		Drawn by:		Reviewed by:	
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		Date:		Date:		Date:		Date:	
		Nov. 18, 2015		Nov. 18, 2015		Nov. 18, 2015		Nov. 18, 2015	
		Proj. Scale:		Proj. Scale:		Proj. Scale:		Proj. Scale:	
		AS NOTED		AS NOTED		AS NOTED		AS NOTED	
		Comm. No.:		Comm. No.:		Comm. No.:		Comm. No.:	
		XXXX		XXXX		XXXX		XXXX	




Notes:


1. Parcel data: District - Section
Block - Lot
2. GRR Parcel Number: **11**
3. FIMI Parcel Number: **11**
4. Montauk Parcel Number: **11**
5. Westhampton Parcel Number: **11**

Legend:

- CEHA
- MIDU_Baseline_20151022
- Parcels
- Easement Area
- Impacted Parcels
- GRR Plan Features
- Landward Toe of Dune
- Seaward Toe of Dune
- Seaward Berm Crest
- Design MHW (2 ft NGVD)
- Dune - 1st Construction
- Berm - 1st Construction

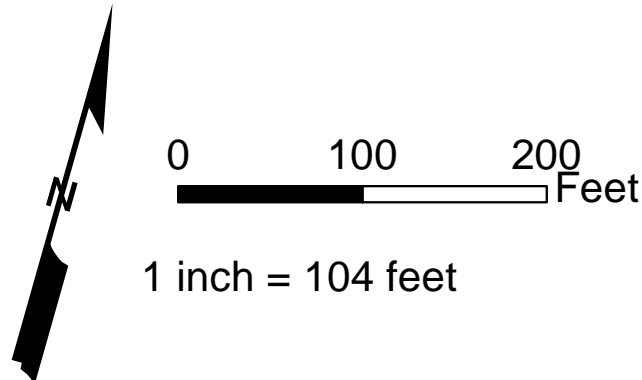

Key Map

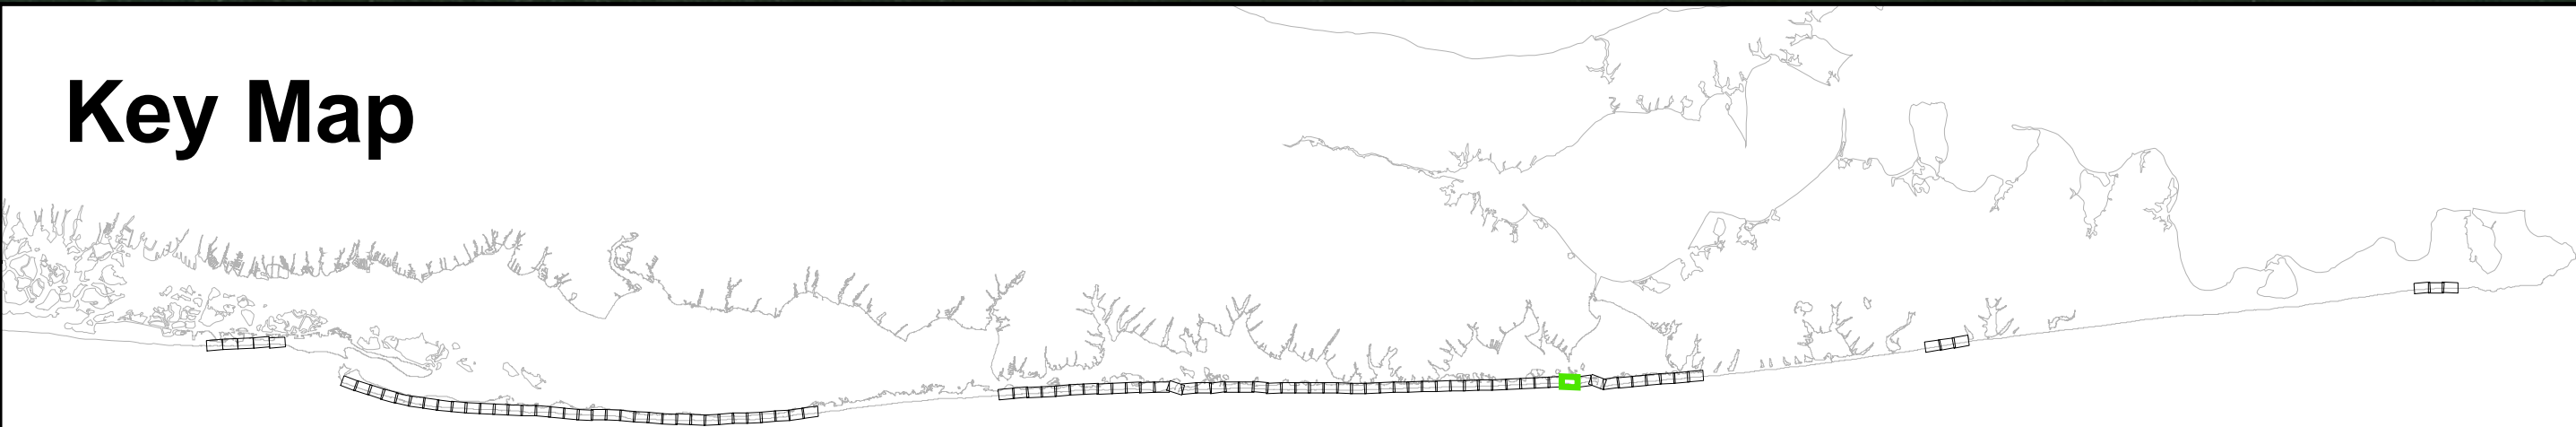

TITLE:		DRAFT		Fire Island Inlet to Montauk Point, NY Reformulation Study	
DRAWING NO.		RE-93		SHEET 93 OF 95	
Reference Files:		Designed by: RWH		Checked by:	
		Drawn by: RWH		Reviewed by:	
		Date: Nov. 18, 2015		Submitted by:	
		Proj. Scale: AS NOTED		Comm. No.: XXXX	
				No.:	
				Date:	




Notes:

1. Parcel data: District - Section
Block - Lot
2. GRR Parcel Number: **11**
3. FIMI Parcel Number: **11**
4. Montauk Parcel Number: **11**
5. Westhampton Parcel Number: **11**

Legend:

- | | |
|------------------------|-------------------------|
| CEHA | Landward Toe of Dune |
| MIDU_Baseline_20151022 | Seaward Toe of Dune |
| Parcels | Seaward Berm Crest |
| Easement Area | Design MHW (2 ft NGVD) |
| Impacted Parcels | Dune - 1st Construction |
| | Berm - 1st Construction |

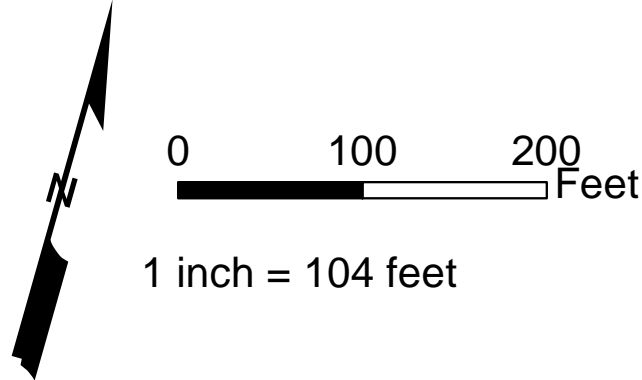

Key Map



DRAFT				TITLE: Fire Island Inlet to Montauk Point, NY Reformulation Study			
DRAWING NO. RE-94				SHEET 94 OF 95			
Designed by: RWH		Checked by:		Reference Files:		No. Date	
Drawn by: RWH		Reviewed by:		AS NOTED			
Date: Nov. 18, 2015		Submitted by:		Comm. No. : XXXXX			




Notes:

1. Parcel data: District - Section
Block - Lot
2. GRR Parcel Number: **11**
3. FIMI Parcel Number: **11**
4. Montauk Parcel Number: **11**
5. Westhampton Parcel Number: **11**

Legend:

- | | |
|------------------------|-------------------------|
| CEHA | Landward Toe of Dune |
| MIDU_Baseline_20151022 | Seaward Toe of Dune |
| Parcels | Seaward Berm Crest |
| Easement Area | Design MHW (2 ft NGVD) |
| Impacted Parcels | Dune - 1st Construction |
| | Berm - 1st Construction |

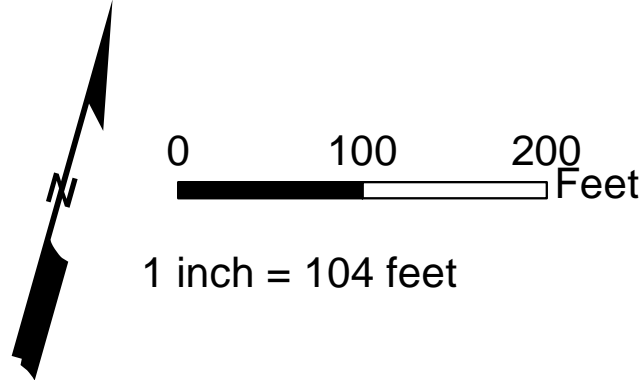

Key Map



SHEET 95 OF 95		DRAWING NO.		TITLE:	
RE-95		DRAFT		Fire Island Inlet to Montauk Point, NY Reformulation Study	
Reference Files:		Designed by:		Checked by:	
		RW			
		Drawn by:		Reviewed by:	
		RW			
		Date:		Submitted by:	
		Nov 18, 2015			
		Comm. No.:			
		AS NOTED			
		Plot Scale:			
		XXXXX			
		No.:			
		Date:			




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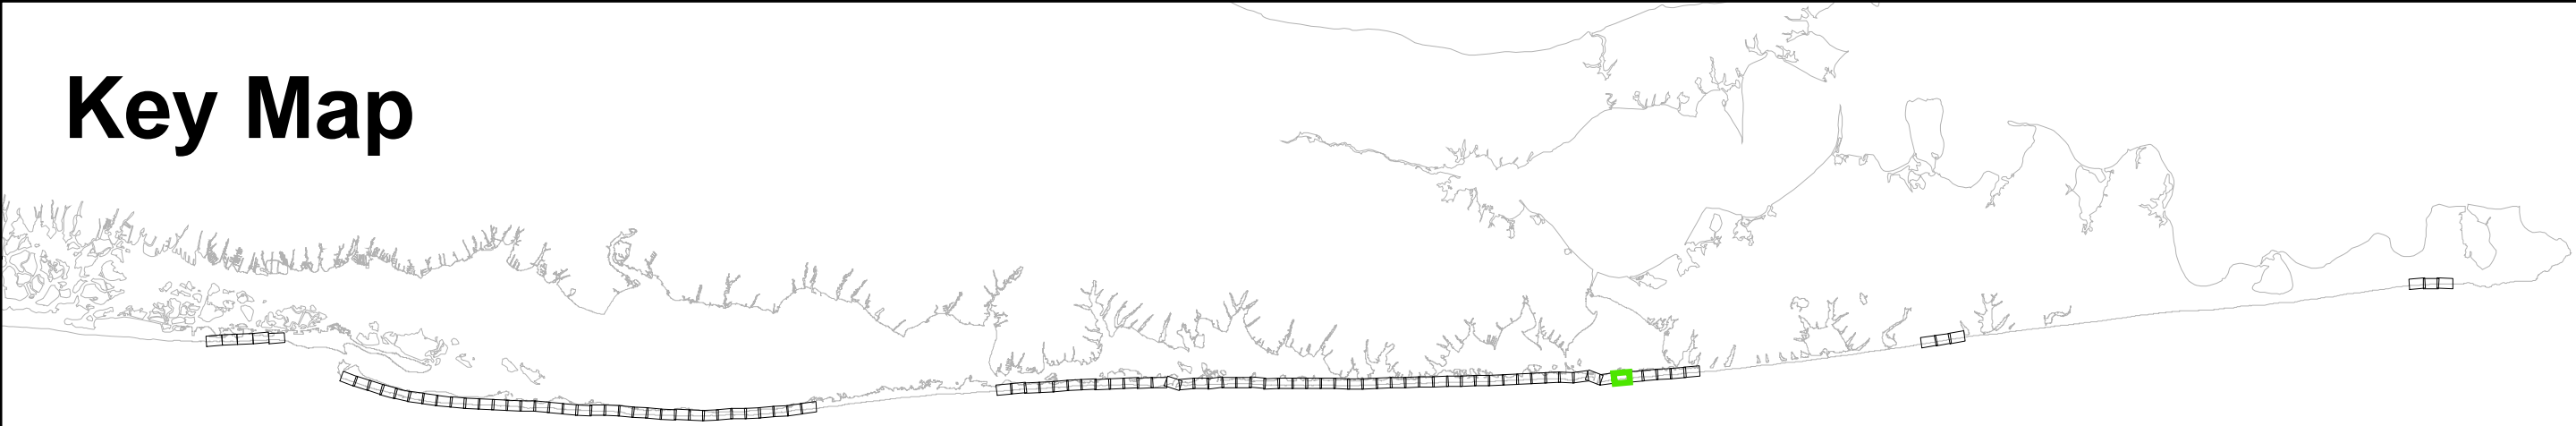
1. Parcel data: District - Section
Block - Lot
2. GRR Parcel Number: 11
3. FIMI Parcel Number: 11
4. Montauk Parcel Number: 11
5. Westhampton Parcel Number: 11

Legend:

- CEHA
- MIDU_Baseline_20151022
- Parcels
- Easement Area
- Impacted Parcels
- GRR Plan Features
- Landward Toe of Dune
- Seaward Toe of Dune
- Seaward Berm Crest
- Design MHW (2 ft NGVD)
- Dune - 1st Construction
- Berm - 1st Construction

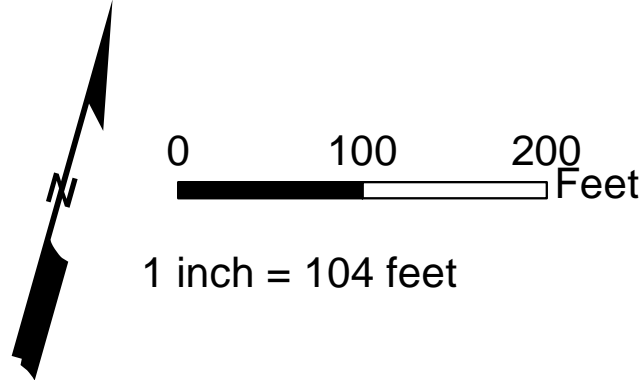

Key Map



TITLE:		DRAFT		Fire Island Inlet to Montauk Point, NY Reformulation Study	
DRAWING NO.		RE-97		SHEET 97 OF 95	
Reference Files:		Designed by: RWH		Checked by:	
Drawn by: RWH		Reviewed by:		No.	
Date: Nov. 18, 2015		Submitted by:		Date:	
Proj. Scale: AS NOTED		Comm. No.: XXXXX		No.	




Notes:

1. Parcel data: District - Section
Block - Lot
2. GRR Parcel Number: **11**
3. FIMI Parcel Number: **11**
4. Montauk Parcel Number: **11**
5. Westhampton Parcel Number: **11**

Legend:

- CEHA
- MIDU_Baseline_20151022
- Parcels
- Easement Area
- Impacted Parcels
- GRR Plan Features
- Landward Toe of Dune
- Seaward Toe of Dune
- Seaward Berm Crest
- Design MHW (2 ft NGVD)
- Dune - 1st Construction
- Berm - 1st Construction

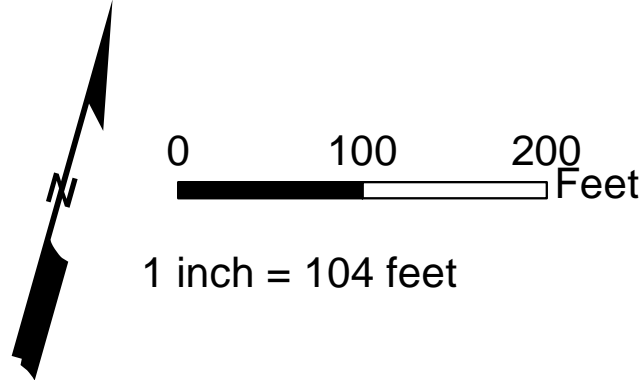

Key Map




Checked by:		Reviewed by:		Submitted by:		Comm. No.:	
RW		RW		Nov. 18, 2015		XXXXX	
Designed by:		Drawn by:		Date:		Proj. Scale:	
RW		RW		Nov. 18, 2015		AS NOTED	
Reference Files:		Title:		Drawing No.:		Sheet 98 of 95	
DRAFT		Fire Island Inlet to Montauk Point, NY		RE-98		SHEET 98 OF 95	
Reformulation Study							



- Notes:**
1. Parcel data: District - Section
Block - Lot
 2. GRR Parcel Number: 11
 3. FIMI Parcel Number: 11
 4. Montauk Parcel Number: 11
 5. Westhampton Parcel Number: 11

Legend:

- | | |
|------------------------|-------------------------|
| CEHA | Landward Toe of Dune |
| MIDU_Baseline_20151022 | Seaward Toe of Dune |
| Parcels | Seaward Berm Crest |
| Easement Area | Design MHW (2 ft NGVD) |
| Impacted Parcels | Dune - 1st Construction |
| | Berm - 1st Construction |

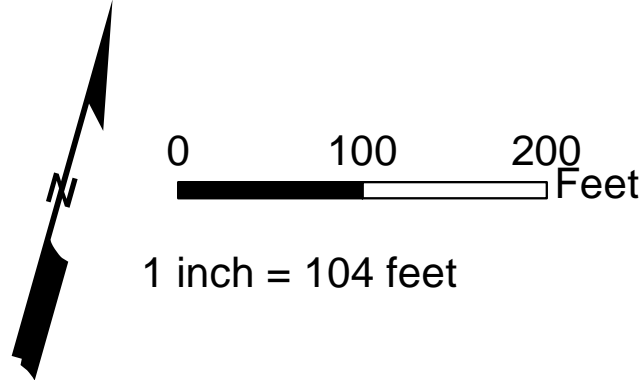

Key Map



TITLE: DRAFT Fire Island Inlet to Montauk Point, NY Reformulation Study				DRAWING NO. RE-99			
Reference Files:				SHEET 99 OF 95			
Designed by:		Checked by:		Drawn by:		Reviewed by:	
RWI		RWI		RWI		RWI	
Date:		Date:		Date:		Date:	
Nov. 18, 2015		Nov. 18, 2015		Nov. 18, 2015		Nov. 18, 2015	
Proj. Scale:		Comm. No.:		Proj. Scale:		Comm. No.:	
AS NOTED		XXXXX		AS NOTED		XXXXX	



- Notes:**
1. Parcel data: District - Section
Block - Lot
2. GRR Parcel Number: 11
3. FIMI Parcel Number: 11
4. Montauk Parcel Number: 11
5. Westhampton Parcel Number: 11

- Legend:**
- CEHA

MIDU_Baseline_20151022

Parcels

Easement Area

Impacted Parcels
- Landward Toe of Dune


Seaward Toe of Dune

Seaward Berm Crest

Design MHW (2 ft NGVD)

Dune - 1st Construction

Berm - 1st Construction

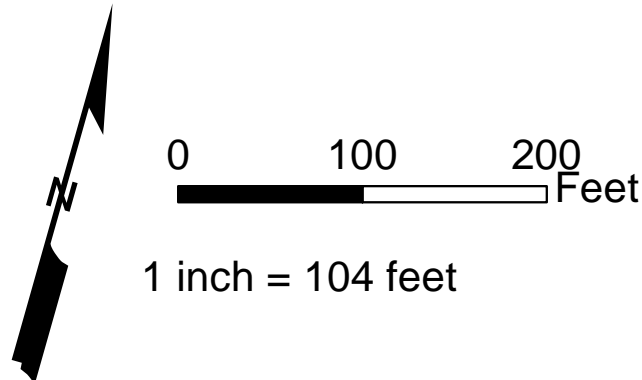

Key Map



Reference Files:	Designed by:	RWH	Checked by:				
	Drawn by:	RWH	Reviewed by:				
	Date:	Nov. 18, 2015	Submitted by:				
	Proj. Scale:	AS NOTED	Comm. No.:	XXXXX			
TITLE:				DRAFT			
Fire Island Inlet to Montauk Point, NY Reformulation Study							
DRAWING NO.				RE-100			
SHEET 100 OF 95							




Notes:

1. Parcel data: District - Section
Block - Lot
2. GRR Parcel Number: **11**
3. FIMI Parcel Number: **11**
4. Montauk Parcel Number: **11**
5. Westhampton Parcel Number: **11**

Legend:

- CEHA
- MIDU_Baseline_20151022
- Parcels
- Easement Area
- Impacted Parcels
- GRR Plan Features
- Landward Toe of Dune
- Seaward Toe of Dune
- Seaward Berm Crest
- Design MHW (2 ft NGVD)
- Dune - 1st Construction
- Berm - 1st Construction

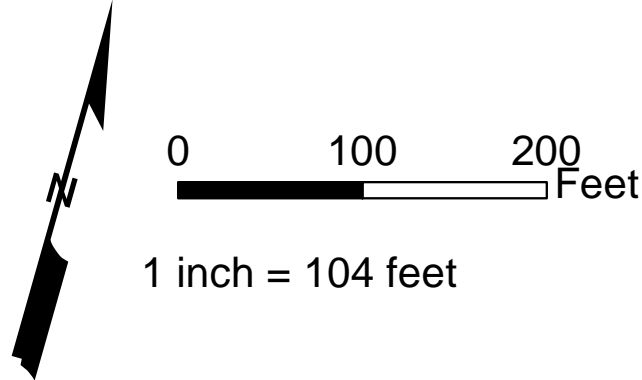

Key Map



Checked by:				Reviewed by:				Submitted by:				Comm. No.:			
RW				RW				Nov. 18, 2015				XXXX			
Designed by:				Drawn by:				Date:				Proj. Scale:			
Reference Files:				AS NOTED				PLS NOTED				PLS NOTED			
TITLE:				DRAFT				Fire Island Inlet to Montauk Point, NY				Reformulation Study			
DRAWING NO.				RE-120				SHEET 120 OF 95							




Notes:


1. Parcel data: District - Section
Block - Lot
2. GRR Parcel Number: **11**
3. FIMI Parcel Number: **11**
4. Montauk Parcel Number: **11**
5. Westhampton Parcel Number: **11**

Legend:

- CEHA
- MIDU_Baseline_20151022
- Parcels
- Easement Area
- Impacted Parcels
- GRR Plan Features
- Landward Toe of Dune
- Seaward Toe of Dune
- Seaward Berm Crest
- Design MHW (2 ft NGVD)
- Dune - 1st Construction
- Berm - 1st Construction

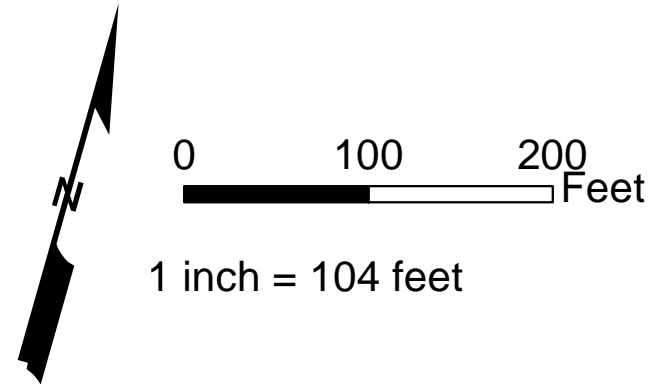

Key Map

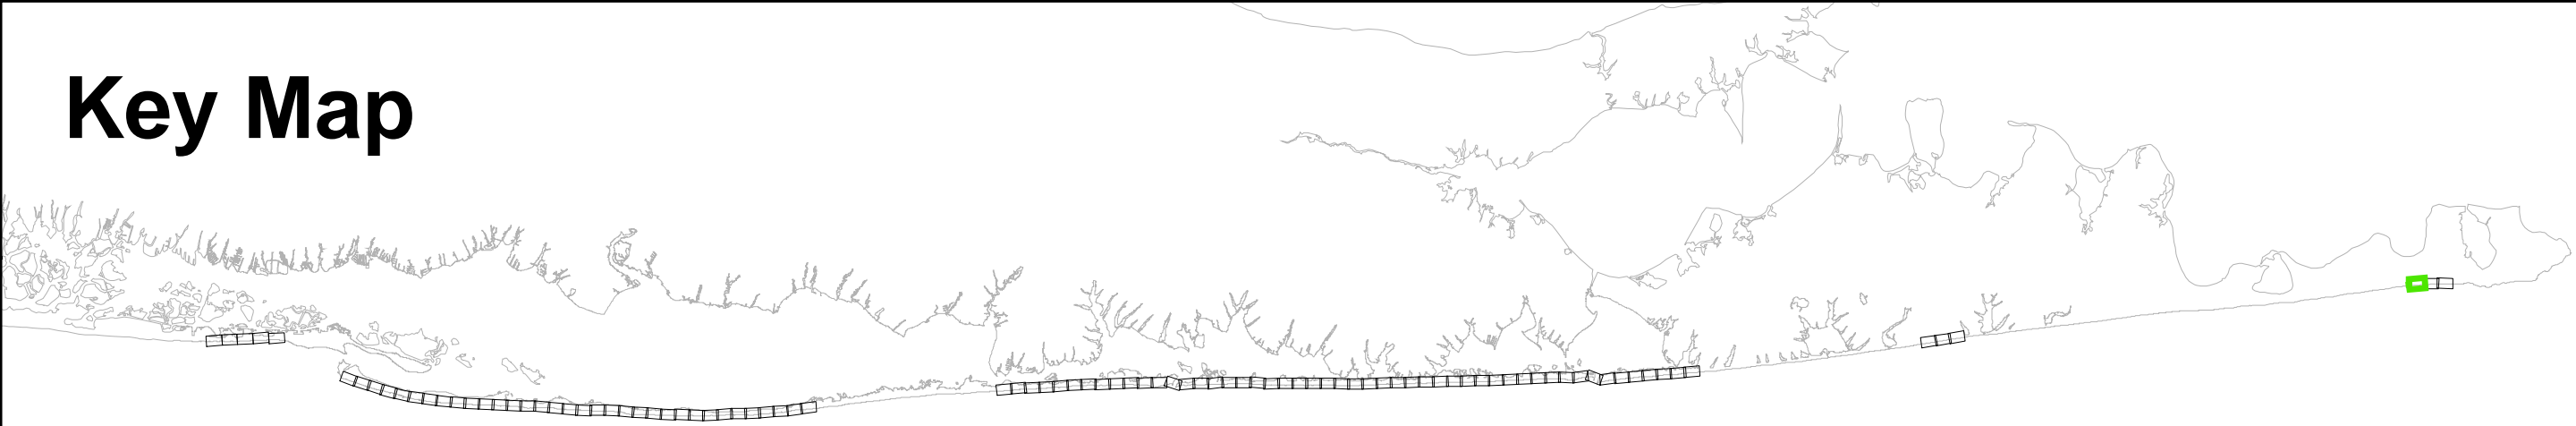


DRAWING NO.		TITLE:		Reference Files:		Designed by: RWH		Checked by:			
						Drawn by: RWH		Reviewed by:			
						Date: Nov 18, 2015		Submitted by:			
						Plot Scale: AS NOTED		Comm. No.:			
								XXXXX		No. Date	




- Notes:**
1. Parcel data: District - Section
Block - Lot
2. GRR Parcel Number: 11
3. FIMI Parcel Number: 11
4. Montauk Parcel Number: 11
5. Westhampton Parcel Number: 11

- Legend:**
- CEHA
MIDU_Baseline_20151022
Parcels
Easement Area
Impacted Parcels
- GRR Plan Features
Landward Toe of Dune
Seaward Toe of Dune
Seaward Berm Crest
Design MHW (2 ft NGVD)
Dune - 1st Construction
Berm - 1st Construction

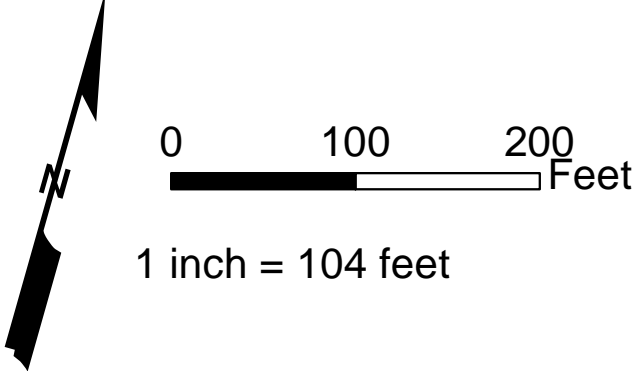

Key Map

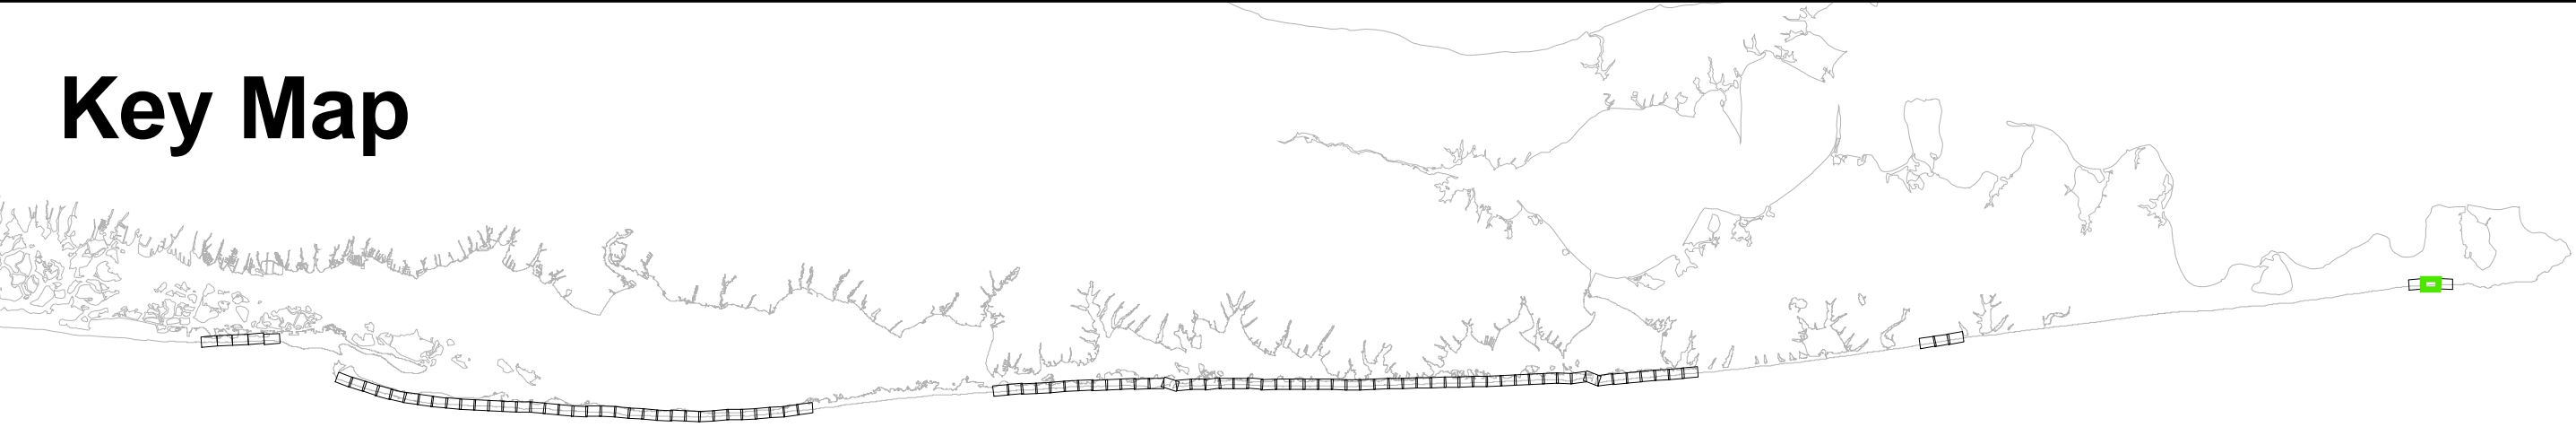


DRAFT				TITLE: Fire Island Inlet to Montauk Point, NY Reformulation Study			
DRAWING NO. RE-155				SHEET 155 OF 95			
Reference Files:				Designed by: RWH			
Checked by:				Reviewed by: RWH			
Drawn by:				Submitted by:			
Date: Nov. 18, 2015				Comm. No.: XXXXX			
Proj. Scale: PLS NOTED				No. 100			




- Notes:**
1. Parcel data: District - Section
Block - Lot
 2. GRR Parcel Number: 11
 3. FIMI Parcel Number: 11
 4. Montauk Parcel Number: 11
 5. Westhampton Parcel Number: 11

- Legend:**
- CEHA
 - MIDU_Baseline_20151022
 - Parcels
 - Easement Area
 - Impacted Parcels
 - GRR Plan Features
 - Landward Toe of Dune
 - Seaward Toe of Dune
 - Seaward Berm Crest
 - Design MHW (2 ft NGVD)
 - Dune - 1st Construction
 - Berm - 1st Construction

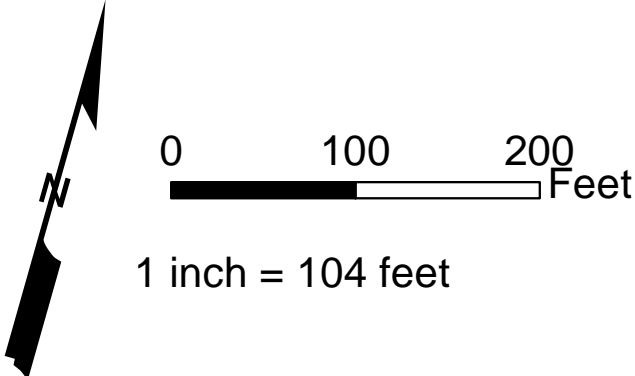

Key Map

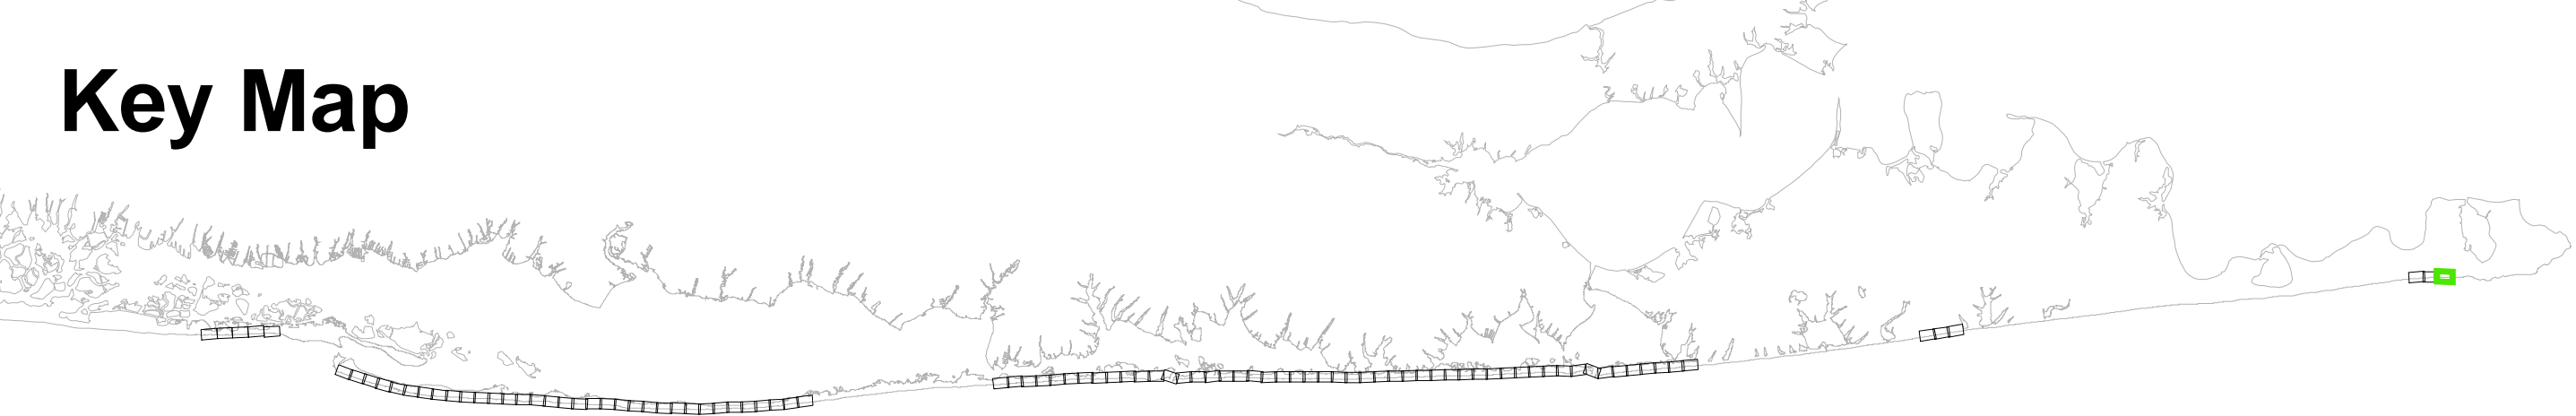

TITLE: DRAFT Fire Island Inlet to Montauk Point, NY Reformulation Study	Designed by:		RWH	Checked by:			
	Drawn by:		RWH	Reviewed by:			
	Date:		Nov. 18, 2015	Submitted by:			
	Proj. Scale:		AS NOTED	Comm. No.:		XXXXX	
DRAWING NO.		RE-156		SHEET 156 OF 95			

FIRE ISLAND TO MONTAUK POINT GENERAL REFORMULATION REPORT

No.	District	Section	Block	Lot	Owner	Parcel Area (AC)	Acquisition Area (AC)	Estate	Reach	Status
1	100	240.00	1.00	6.000	Public	103.02	16.41	Access Agreement	Gilgo Beach	New
2	100	240.00	1.00	7.000	Public	56.50	8.83	Access Agreement	Gilgo Beach	New
3	100	241.00	1.00	1.002	Public	3322.39	39.66	Access Agreement	Gilgo Beach	New
4	200	988.70	1.00	1.000	Public	218.51	30.94	Easement	Cupsogue	New
5	200	985.50	2.00	1.000	Public	44080.46	9.49	Access Agreement	Cupsogue	New
6	902	12.00	2.00	1.000	Private	1.30	0.01	Easement	Hampton	New
7	902	12.00	2.00	2.000	Private	1.32	0.04	Easement	Hampton	New
8	902	12.00	2.00	3.000	Private	1.55	0.29	Easement	Hampton	New
9	902	12.00	2.00	6.001	Private	2.48	0.23	Easement	Hampton	New
10	902	12.00	2.00	7.000	Private	2.13	0.26	Easement	Hampton	New
11	902	12.00	2.00	9.004	Private	1.18	0.01	Easement	Hampton	New
12	902	12.00	2.00	9.006	Private	1.71	0.03	Easement	Hampton	New
13	902	12.00	2.00	10.000	Private	1.44	0.03	Easement	Hampton	New
14	902	12.00	2.00	11.000	Private	1.97	0.06	Easement	Hampton	New
15	902	12.00	2.00	12.000	Private	2.05	0.33	Easement	Hampton	New
16	902	12.00	2.00	13.000	Private	0.03	0.01	Easement	Hampton	New
17	902	12.00	2.00	14.000	Private	0.03	0.01	Easement	Hampton	New
18	902	12.00	2.00	15.000	Private	0.09	0.01	Easement	Hampton	New
19	902	12.00	2.00	16.000	Private	2.23	0.77	Easement	Hampton	New
20	902	12.00	2.00	17.000	Private	2.08	0.65	Easement	Hampton	New
21	902	12.00	2.00	18.000	Private	2.11	0.71	Easement	Hampton	New
22	902	12.00	2.00	19.000	Private	1.66	0.27	Easement	Hampton	New
23	902	15.00	2.00	1.000	Private	1.48	0.58	Easement	Hampton	New
24	902	15.00	2.00	2.000	Private	0.51	0.14	Easement	Hampton	New
25	902	15.00	2.00	3.000	Private	0.40	0.08	Easement	Hampton	New
26	902	15.00	2.00	4.000	Private	0.20	0.04	Easement	Hampton	New
27	902	15.00	2.00	5.000	Private	0.62	0.12	Easement	Hampton	New
28	902	15.00	2.00	6.000	Private	0.54	0.18	Easement	Hampton	New
29	902	15.00	2.00	7.000	Private	0.91	0.18	Easement	Hampton	New

FIRE ISLAND TO MONTAUK POINT GENERAL REFORMULATION REPORT										
No.	District	Section	Block	Lot	Owner	Parcel Area (AC)	Acquisition Area (AC)	Estate	Reach	Status
30	902	15.00	2.00	8.000	Private	0.92	0.14	Easement	Hampton	New
31	902	15.00	2.00	9.004	Private	0.92	0.07	Easement	Hampton	New
32	902	15.00	2.00	9.003	Private	1.04	0.14	Easement	Hampton	New
33	902	15.00	2.00	9.002	Private	0.98	0.08	Easement	Hampton	New
34	902	15.00	2.00	10.000	Private	1.70	0.17	Easement	Hampton	New
35	902	15.00	2.00	11.000	Private	1.56	0.26	Easement	Hampton	New
36	902	15.00	2.00	12.000	Private	1.62	0.26	Easement	Hampton	New
37	902	15.00	2.00	13.000	Private	1.59	0.32	Easement	Hampton	New
38	902	15.00	2.00	14.000	Private	2.08	0.21	Easement	Hampton	New
39	902	15.00	2.00	15.000	Private	2.09	0.17	Easement	Hampton	New
40	902	15.00	2.00	16.000	Private	2.49	0.12	Easement	Hampton	New
41	902	15.00	2.00	17.000	Private	2.15	0.17	Easement	Hampton	New
42	902	15.00	2.00	18.000	Private	1.43	0.13	Easement	Hampton	New
43	902	15.00	2.00	19.000	Private	8.60	1.04	Easement	Hampton	New
44	902	15.00	2.00	21.000	Private	1.44	0.12	Easement	Hampton	New
45	905	20.00	2.00	29.001	Private	2.01	0.20	Easement	Hampton	New
46	905	21.00	3.00	11.001	Private	1.01	0.20	Easement	Hampton	New
47	905	21.00	3.00	11.002	Private	0.97	0.19	Easement	Hampton	New
48	905	21.00	3.00	12.000	Public	1.58	0.09	Access Agreement	Hampton	New
49	905	21.00	4.00	1.000	Public	1.79	0.13	Access Agreement	Hampton	New
50	905	22.00	2.00	4.000	Private	0.61	0.00	Easement	Hampton	New
51	905	22.00	2.00	8.001	Private	1.04	0.03	Easement	Hampton	New
52	905	22.00	2.00	13.003	Private	3.13	0.65	Easement	Hampton	New
53	905	22.00	2.00	15.001	Private	0.96	0.30	Easement	Hampton	New
54	905	22.00	2.00	16.000	Private	0.51	0.04	Easement	Hampton	New
55	905	22.00	2.00	17.001	Private	0.74	0.01	Easement	Hampton	New
56	905	22.00	2.00	20.000	Private	0.98	0.30	Easement	Hampton	New
57	905	22.00	2.00	21.000	Private	0.96	0.27	Easement	Hampton	New
58	905	22.00	2.00	22.000	Private	0.98	0.25	Easement	Hampton	New

FIRE ISLAND TO MONTAUK POINT GENERAL REFORMULATION REPORT

No.	District	Section	Block	Lot	Owner	Parcel Area (AC)	Acquisition Area (AC)	Estate	Reach	Status
59	905	22.00	2.00	23.000	Private	1.17	0.28	Easement	Hampton	New
60	905	22.00	2.00	24.000	Private	1.14	0.24	Easement	Hampton	New
61	905	22.00	2.00	25.000	Private	0.93	0.18	Easement	Hampton	New
62	902	13.00	2.00	1.000	Private	2.23	0.42	Easement	Hampton	New
63	902	13.00	2.00	2.000	Private	0.37	0.07	Easement	Hampton	New
64	902	13.00	2.00	3.000	Private	1.35	0.28	Easement	Hampton	New
65	902	13.00	2.00	7.000	Private	2.06	0.49	Easement	Hampton	New
66	902	13.00	2.00	8.000	Private	2.09	0.55	Easement	Hampton	New
67	902	13.00	3.00	7.000	Private	1.39	0.29	Easement	Hampton	New
68	902	13.00	3.00	8.000	Private	0.22	0.05	Easement	Hampton	New
69	902	13.00	3.00	9.000	Private	0.95	0.20	Easement	Hampton	New
70	902	13.00	3.00	10.000	Private	0.73	0.18	Easement	Hampton	New
71	902	13.00	3.00	11.000	Private	1.06	0.44	Easement	Hampton	New
72	902	13.00	3.00	13.001	Private	0.56	0.24	Easement	Hampton	New
73	905	22.00	2.00	27.001	Private	1.60	0.22	Easement	Hampton	New
74	902	13.00	3.00	14.000	Private	1.34	0.14	Easement	Hampton	New
75	902	13.00	3.00	15.000	Private	0.92	0.11	Easement	Hampton	New
76	902	13.00	3.00	16.000	Private	1.10	0.01	Easement	Hampton	New
77	902	13.00	3.00	17.000	Private	0.09	0.01	Easement	Hampton	New
78	902	13.00	3.00	18.000	Private	0.73	0.11	Easement	Hampton	New
79	902	13.00	3.00	19.000	Private	0.90	0.23	Easement	Hampton	New
80	902	16.00	2.00	1.001	Private	1.83	0.56	Easement	Hampton	New
81	902	16.00	2.00	1.002	Private	2.02	0.56	Easement	Hampton	New
82	902	16.00	2.00	1.003	Private	2.24	0.62	Easement	Hampton	New
83	902	16.00	2.00	1.004	Private	3.75	1.02	Easement	Hampton	New
84	902	16.00	2.00	2.001	Private	2.95	0.83	Easement	Hampton	New
85	902	16.00	2.00	2.003	Private	2.90	0.71	Easement	Hampton	New
86	902	16.00	2.00	2.004	Private	2.84	0.67	Easement	Hampton	New
87	902	16.00	2.00	2.005	Private	2.93	0.63	Easement	Hampton	New

FIRE ISLAND TO MONTAUK POINT GENERAL REFORMULATION REPORT

No.	District	Section	Block	Lot	Owner	Parcel Area (AC)	Acquisition Area (AC)	Estate	Reach	Status
88	902	16.00	2.00	3.000	Private	0.72	0.00	Easement	Hampton	New
89	902	16.00	2.00	4.001	Private	3.95	0.18	Easement	Hampton	New
90	902	16.00	2.00	4.002	Private	3.25	0.12	Easement	Hampton	New
91	902	16.00	2.00	5.000	Private	1.75	0.32	Easement	Hampton	New
92	902	16.00	2.00	6.000	Public	1.68	0.31	Access Agreement	Hampton	New
93	902	16.00	2.00	7.002	Public	0.15	0.02	Access Agreement	Hampton	New
94	902	16.00	2.00	7.001	Private	0.17	0.02	Easement	Hampton	New
95	902	16.00	2.00	8.000	Private	1.98	0.28	Easement	Hampton	New
96	902	16.00	2.00	10.003	Private	1.71	0.20	Easement	Hampton	New
97	902	16.00	2.00	10.001	Private	2.08	0.40	Easement	Hampton	New
98	902	16.00	2.00	11.000	Private	2.60	0.65	Easement	Hampton	New
99	902	16.00	2.00	12.000	Private	1.50	0.14	Easement	Hampton	New
100	902	16.00	2.00	13.000	Private	1.31	0.03	Easement	Hampton	New
101	902	16.00	2.00	14.000	Private	3.05	0.15	Easement	Hampton	New
102	902	16.00	2.00	2.002	Private	2.93	0.78	Easement	Hampton	New
103	902	16.00	2.00	17.000	Private	1.08	0.51	Easement	Sedge	New
104	902	16.00	2.00	18.000	Private	0.63	0.11	Easement	Sedge	New
105	902	16.00	2.00	21.000	Private	0.89	0.45	Easement	Sedge	New
106	902	16.00	2.00	19.000	Private	1.38	0.15	Easement	Sedge	New
107	902	16.00	2.00	22.000	Private	1.46	0.41	Easement	Sedge	New
108	902	16.00	3.00	16.000	Private	0.89	0.04	Easement	Sedge	New
109	902	16.00	3.00	17.000	Private	2.33	0.18	Easement	Sedge	New
110	902	16.00	3.00	18.000	Private	2.91	0.41	Easement	Sedge	New
111	902	16.00	3.00	19.000	Private	1.41	0.46	Easement	Sedge	New
112	902	16.00	3.00	20.000	Private	2.24	0.77	Easement	Sedge	New
113	902	16.00	3.00	21.000	Private	1.57	0.18	Easement	Sedge	New
114	902	16.00	3.00	22.000	Private	1.35	0.36	Easement	Sedge	New
115	902	16.00	3.00	30.000	Private	0.07	0.04	Easement	Sedge	New
116	902	16.00	3.00	23.000	Private	1.71	0.17	Easement	Sedge	New

FIRE ISLAND TO MONTAUK POINT GENERAL REFORMULATION REPORT

No.	District	Section	Block	Lot	Owner	Parcel Area (AC)	Acquisition Area (AC)	Estate	Reach	Status
117	902	16.00	3.00	24.000	Private	1.76	0.15	Easement	Sedge	New
118	902	16.00	3.00	25.000	Private	2.18	0.56	Easement	Sedge	New
119	902	16.00	3.00	26.000	Private	1.43	0.07	Easement	Sedge	New
120	902	16.00	3.00	27.001	Private	1.10	0.19	Easement	Sedge	New
121	902	16.00	3.00	28.002	Private	1.83	0.17	Easement	Sedge	New
122	902	16.00	3.00	28.003	Private	2.09	0.21	Easement	Sedge	New
123	900	385.00	2.00	4.000	Private	1.78	0.21	Easement	Sedge	New
124	900	385.00	2.00	5.000	Private	2.45	0.37	Easement	Sedge	New
125	900	385.00	2.00	11.001	Private	1.34	0.30	Easement	Sedge	New
126	900	385.00	2.00	13.001	Private	1.30	0.32	Easement	Sedge	New
127	900	385.00	2.00	14.000	Private	4.90	1.34	Easement	Sedge	New
128	900	385.00	2.00	15.002	Private	2.43	0.69	Easement	Sedge	New
129	900	385.00	2.00	15.003	Private	2.58	0.73	Easement	Sedge	New
130	900	385.00	2.00	15.004	Private	2.61	0.72	Easement	Sedge	New
131	900	385.00	2.00	15.005	Private	2.65	0.72	Easement	Sedge	New
132	900	385.00	2.00	19.000	Private	0.45	0.37	Easement	Sedge	New
133	900	385.00	2.00	16.000	Private	2.73	0.96	Easement	Sedge	New
134	900	385.00	2.00	20.000	Private	0.44	0.35	Easement	Sedge	New
135	900	385.00	2.00	18.006	Private	2.74	0.87	Easement	Sedge	New
136	900	385.00	2.00	18.007	Private	2.69	0.93	Easement	Sedge	New
137	900	385.00	2.00	18.008	Private	2.68	0.99	Easement	Sedge	New
138	900	385.00	2.00	18.009	Private	2.35	0.82	Easement	Sedge	New
139	900	385.00	2.00	18.014	Private	4.69	1.51	Easement	Sedge	New
140	900	385.00	2.00	66.002	Private	1.25	0.29	Easement	Sedge	New
141	900	385.00	2.00	66.003	Private	1.29	0.31	Easement	Sedge	New
142	900	385.00	2.00	66.004	Private	1.32	0.32	Easement	Sedge	New
143	900	385.00	2.00	66.005	Private	1.34	0.31	Easement	Sedge	New
144	900	385.00	2.00	66.006	Private	1.35	0.30	Easement	Sedge	New
145	900	385.00	2.00	36.000	Private	0.50	0.33	Easement	Sedge	New

FIRE ISLAND TO MONTAUK POINT GENERAL REFORMULATION REPORT

No.	District	Section	Block	Lot	Owner	Parcel Area (AC)	Acquisition Area (AC)	Estate	Reach	Status
146	900	385.00	2.00	66.012	Private	2.67	0.33	Easement	Sedge	New
147	900	385.00	2.00	37.000	Private	0.49	0.32	Easement	Sedge	New
148	900	385.00	2.00	73.002	Private	2.16	0.95	Easement	Sedge	New
149	900	385.00	2.00	73.003	Private	1.53	0.54	Easement	Sedge	New
150	900	385.00	2.00	73.004	Private	1.55	0.54	Easement	Sedge	New
151	900	385.00	2.00	73.005	Private	1.57	0.54	Easement	Sedge	New
152	900	385.00	2.00	73.006	Private	1.59	0.54	Easement	Sedge	New
153	900	385.00	2.00	73.007	Private	1.61	0.55	Easement	Sedge	New
154	900	385.00	2.00	73.008	Private	1.53	0.47	Easement	Sedge	New
155	900	385.00	2.00	73.009	Private	1.68	0.61	Easement	Sedge	New
156	900	385.00	2.00	73.010	Private	1.90	0.76	Easement	Sedge	New
157	900	385.00	2.00	76.001	Public	8.94	2.81	Access Agreement	Sedge	New
158	900	386.00	2.00	1.000	Public	3.77	1.48	Access Agreement	Sedge	New
159	900	386.00	2.00	2.000	Private	0.93	0.37	Easement	Sedge	New
160	900	386.00	2.00	3.000	Private	0.91	0.36	Easement	Sedge	New
161	900	386.00	2.00	4.000	Private	0.85	0.32	Easement	Sedge	New
162	900	386.00	2.00	5.001	Private	2.13	0.83	Easement	Sedge	New
163	900	386.00	2.00	5.002	Private	2.10	0.83	Easement	Sedge	New
164	900	386.00	2.00	5.003	Public	3.10	1.31	Access Agreement	Sedge	New
165	902	16.00	3.00	29.000	Private	0.71	0.12	Easement	Sedge	New
166	902	16.00	3.00	28.004	Private	1.13	0.10	Easement	Sedge	New
167	900	385.00	2.00	3.000	Private	1.72	0.14	Easement	Sedge	New
168	900	385.00	2.00	9.002	Private	2.00	0.48	Easement	Sedge	New
169	900	386.00	2.00	27.000	Private	0.33	0.10	Easement	Tiana	New
170	900	386.00	2.00	11.000	Private	1.38	0.55	Easement	Tiana	New
171	900	386.00	2.00	29.000	Private	0.56	0.56	Easement	Tiana	New
172	900	386.00	2.00	5.004	Public	6.28	2.42	Access Agreement	Tiana	New
173	900	386.00	2.00	8.006	Public	2.96	0.76	Access Agreement	Tiana	New
174	900	386.00	2.00	8.008	Private	5.00	2.15	Easement	Tiana	New

FIRE ISLAND TO MONTAUK POINT GENERAL REFORMULATION REPORT

No.	District	Section	Block	Lot	Owner	Parcel Area (AC)	Acquisition Area (AC)	Estate	Reach	Status
175	900	386.00	2.00	10.004	Public	6.20	2.23	Access Agreement	Tiana	New
176	900	386.00	2.00	10.002	Public	2.90	1.11	Access Agreement	Tiana	New
177	900	386.00	2.00	22.000	Public	0.61	0.60	Easement	Tiana	New
178	900	386.00	2.00	10.003	Public	3.31	1.31	Access Agreement	Tiana	New
179	900	386.00	2.00	21.000	Private	0.37	0.19	Easement	Tiana	New
180	900	386.00	2.00	12.000	Public	3.87	1.72	Access Agreement	Tiana	New
181	900	386.00	2.00	14.001	Private	1.39	0.58	Easement	Tiana	New
182	900	386.00	2.00	15.000	Private	1.02	0.44	Easement	Tiana	New
183	900	386.00	2.00	17.001	Private	0.92	0.38	Easement	Tiana	New
184	900	386.00	2.00	18.000	Private	0.24	0.10	Easement	Tiana	New
185	900	386.00	2.00	28.001	Private	1.23	0.71	Easement	Tiana	New
186	900	386.00	2.00	31.001	Private	3.09	1.69	Easement	Tiana	New
187	900	386.00	2.00	33.001	Public	2.73	0.96	Access Agreement	Tiana	New
188	900	387.00	1.00	2.000	Public	63.41	29.12	Access Agreement	Shinnecock Park West	New
189	900	386.00	2.00	34.000	Public	16.13	5.95	Access Agreement	Shinnecock Park West	New
195	900	364.00	1.00	10.002	Public	56.55	6.46	Access Agreement	Shinnecock Inlet - East	New
196	904	21.00	1.00	14.001	Private	4.27	0.45	Easement	Shinnecock Inlet - East	New
197	904	21.00	1.00	14.002	Private	3.91	0.34	Easement	Shinnecock Inlet - East	New
198	904	21.00	1.00	14.003	Private	3.93	0.24	Easement	Shinnecock Inlet - East	New
199	904	21.00	1.00	15.000	Public	30.91	6.32	Access Agreement	Shinnecock Inlet - East	New
200	904	21.00	1.00	14.004	Private	3.58	0.03	Easement	Shinnecock Inlet - East	New
201	904	21.00	1.00	8.013	Private	3.40	0.04	Easement	Shinnecock Inlet - East	New
202	904	21.00	1.00	8.011	Private	3.37	0.11	Easement	Shinnecock Inlet - East	New
203	904	21.00	1.00	8.009	Private	3.73	0.21	Easement	Shinnecock Inlet - East	New
204	904	21.00	1.00	8.008	Private	3.29	0.26	Easement	Shinnecock Inlet - East	New
205	904	21.00	1.00	8.006	Private	3.27	0.33	Easement	Shinnecock Inlet - East	New
206	904	21.00	1.00	8.004	Private	3.26	0.37	Easement	Shinnecock Inlet - East	New
207	904	21.00	1.00	8.020	Private	4.42	0.60	Easement	Shinnecock Inlet - East	New
208	904	21.00	1.00	8.021	Private	3.74	0.60	Easement	Shinnecock Inlet - East	New

FIRE ISLAND TO MONTAUK POINT GENERAL REFORMULATION REPORT

No.	District	Section	Block	Lot	Owner	Parcel Area (AC)	Acquisition Area (AC)	Estate	Reach	Status
209	904	22.00	2.00	1.003	Public	3.13	0.66	Access Agreement	Shinnecock Inlet - East	New
210	904	22.00	2.00	1.005	Public	2.91	0.60	Access Agreement	Shinnecock Inlet - East	New
211	904	22.00	2.00	1.004	Public	2.84	0.60	Access Agreement	Shinnecock Inlet - East	New
212	904	22.00	2.00	2.011	Private	7.58	1.16	Easement	Shinnecock Inlet - East	New
213	904	22.00	2.00	2.008	Private	4.57	0.89	Easement	Shinnecock Inlet - East	New
214	904	22.00	2.00	2.009	Private	3.66	0.86	Easement	Shinnecock Inlet - East	New
215	904	22.00	2.00	2.010	Private	4.78	1.32	Easement	Shinnecock Inlet - East	New
216	904	23.00	2.00	1.000	Private	2.42	0.16	Easement	Southampton Beach	New
217	904	23.00	2.00	3.001	Private	4.60	0.32	Easement	Southampton Beach	New
218	904	23.00	2.00	4.000	Private	2.56	0.03	Easement	Southampton Beach	New
219	904	23.00	2.00	5.000	Private	2.29	0.01	Easement	Southampton Beach	New
220	904	23.00	2.00	6.000	Private	2.10	0.03	Easement	Southampton Beach	New
221	904	23.00	2.00	7.000	Private	2.52	0.08	Easement	Southampton Beach	New
222	904	23.00	2.00	8.000	Private	3.18	0.10	Easement	Southampton Beach	New
223	904	23.00	2.00	9.000	Private	2.97	0.57	Easement	Southampton Beach	New
224	904	23.00	2.00	10.001	Private	4.08	0.68	Easement	Southampton Beach	New
225	904	23.00	2.00	10.002	Private	3.83	0.63	Easement	Southampton Beach	New
226	904	23.00	2.00	11.000	Private	6.03	0.33	Easement	Southampton Beach	New
227	904	24.00	1.00	20.000	Private	1.98	0.61	Easement	Southampton Beach	New
228	904	24.00	1.00	16.000	Private	2.24	0.25	Easement	Southampton Beach	New
229	904	24.00	1.00	15.001	Private	5.89	1.07	Easement	Southampton Beach	New
230	904	24.00	1.00	13.000	Private	6.64	1.69	Easement	Southampton Beach	New
231	904	24.00	1.00	12.000	Private	3.43	1.05	Easement	Southampton Beach	New
232	904	24.00	1.00	11.000	Private	1.90	0.16	Easement	Southampton Beach	New
233	904	24.00	1.00	19.000	Private	4.11	1.22	Easement	Southampton Beach	New
234	904	25.00	1.00	21.000	Private	3.74	1.19	Easement	Southampton Beach	New
235	904	24.00	1.00	18.000	Private	1.75	0.49	Easement	Southampton Beach	New
236	904	25.00	1.00	20.000	Private	3.01	0.11	Easement	Southampton Beach	New
237	904	24.00	1.00	17.000	Private	1.71	0.35	Easement	Southampton Beach	New

FIRE ISLAND TO MONTAUK POINT GENERAL REFORMULATION REPORT

No.	District	Section	Block	Lot	Owner	Parcel Area (AC)	Acquisition Area (AC)	Estate	Reach	Status
238	904	22.00	2.00	9.000	Private	1.69	0.01	Easement	Southampton Beach	New
239	904	22.00	2.00	10.000	Private	1.76	0.04	Easement	Southampton Beach	New
240	904	22.00	2.00	11.000	Private	2.27	0.09	Easement	Southampton Beach	New
241	904	22.00	2.00	12.000	Private	2.13	0.15	Easement	Southampton Beach	New
242	904	22.00	2.00	13.000	Private	1.85	0.20	Easement	Southampton Beach	New
243	904	22.00	2.00	14.000	Private	1.97	0.26	Easement	Southampton Beach	New
244	904	22.00	2.00	16.003	Private	8.12	1.31	Easement	Southampton Beach	New
245	904	22.00	2.00	16.001	Private	4.94	0.96	Easement	Southampton Beach	New
246	904	22.00	2.00	17.002	Private	3.07	0.57	Easement	Southampton Beach	New
247	904	22.00	2.00	17.001	Private	2.83	0.55	Easement	Southampton Beach	New
248	904	22.00	2.00	18.000	Private	2.62	0.35	Easement	Southampton Beach	New
249	904	22.00	2.00	20.000	Private	5.22	0.82	Easement	Southampton Beach	New
250	904	22.00	2.00	21.000	Private	3.29	0.48	Easement	Southampton Beach	New
251	904	22.00	2.00	22.000	Private	2.92	0.44	Easement	Southampton Beach	New
252	908	10.00	4.00	19.000	Private	0.36	0.10	Easement	Potato Road	New
253	908	10.00	4.00	10.000	Private	3.57	0.18	Easement	Potato Road	New
254	908	10.00	3.00	2.000	Private	18.66	0.85	Easement	Potato Road	New
255	908	10.00	4.00	5.000	Private	3.48	1.49	Easement	Potato Road	New
256	908	10.00	4.00	23.000	Private	2.49	0.75	Easement	Potato Road	New
257	908	10.00	3.00	16.000	Private	0.51	0.28	Easement	Potato Road	New
258	908	10.00	3.00	17.000	Private	0.98	0.48	Easement	Potato Road	New
259	908	10.00	3.00	18.000	Private	0.73	0.32	Easement	Potato Road	New
260	908	10.00	3.00	19.000	Private	0.90	0.43	Easement	Potato Road	New
261	908	10.00	3.00	20.000	Private	1.93	0.82	Easement	Potato Road	New
262	908	10.00	4.00	11.000	Private	0.53	0.26	Easement	Potato Road	New
263	908	10.00	3.00	26.000	Private	5.03	0.60	Easement	Potato Road	New
264	908	10.00	4.00	12.000	Private	0.50	0.26	Easement	Potato Road	New
265	908	10.00	4.00	3.000	Private	1.92	0.50	Easement	Potato Road	New
266	908	10.00	4.00	13.000	Private	0.75	0.39	Easement	Potato Road	New

FIRE ISLAND TO MONTAUK POINT GENERAL REFORMULATION REPORT										
No.	District	Section	Block	Lot	Owner	Parcel Area (AC)	Acquisition Area (AC)	Estate	Reach	Status
267	908	10.00	4.00	14.000	Private	0.92	0.62	Easement	Potato Road	New
268	908	10.00	4.00	18.000	Private	1.05	0.52	Easement	Potato Road	New
269	908	10.00	3.00	21.000	Private	1.00	0.37	Easement	Potato Road	New
270	908	10.00	3.00	22.000	Private	0.95	0.32	Easement	Potato Road	New
271	908	10.00	3.00	23.000	Private	0.64	0.19	Easement	Potato Road	New
272	908	10.00	3.00	27.000	Private	5.17	0.88	Easement	Potato Road	New
273	908	10.00	4.00	24.000	Private	2.74	0.41	Easement	Potato Road	New
274	900	395.00	2.00	1.000	Public	46474.94	177.36	Access Agreement	Potato Road	New

REQUIRED LER FOR PREVIOUSLY CONSTRUCTED PROJECTS

DOWNTOWN MONTAUK STABILIZATION PROJECT										
No.	District	Section	Block	Lot	Owner	Parcel Area (AC)	Acquisition Area (AC)	Estate	FIMP Reach	Status
1	300	50.00	1.00	30.000	Private	1.81	0.72	Easement	Montauk Beach	Acquired
2	300	50.00	1.00	29.000	Private	1.61	0.10	Easement	Montauk Beach	Acquired
3	300	51.00	4.00	1.000	Private	1.07	0.16	Easement	Montauk Beach	Acquired
4	300	50.00	2.00	27.000	Public	3.69	3.69	Access Agreement	Montauk Beach	Acquired
5	300	50.00	1.00	25.001	Private	0.13	0.01	Easement	Montauk Beach	Acquired
6	300	50.00	2.00	28.000	Public	0.77	0.78	Access Agreement	Montauk Beach	Acquired
7	300	50.00	2.00	22.000	Private	0.13	0.01	Easement	Montauk Beach	Acquired
8	300	50.00	1.00	23.005	Private	0.49	0.05	Easement	Montauk Beach	Acquired
9	300	50.00	1.00	28.000	Private	0.27	0.03	Easement	Montauk Beach	Acquired
10	300	50.00	2.00	24.001	Parcel Unnecessary for Construction					
11	300	50.00	2.00	26.001	Private	1.62	0.02	Easement	Montauk Beach	Acquired
12	300	50.00	1.00	27.001	Private	0.54	0.02	Easement	Montauk Beach	Acquired
13	300	49.00	6.00	26.000	Private	2.06	0.22	Easement	Montauk Beach	Acquired
14	300	49.00	6.00	21.000	Private	6.47	0.68	Easement	Montauk Beach	Acquired
15	300	49.00	6.00	20.013	Private	0.91	0.07	Easement	Montauk Beach	Acquired
16	300	205.00	1.00	1.000	Public	149821.34	5.49	Access Agreement	Montauk Beach	Acquired
17	300	47.00	3.00	12.000	Public	0.22	0.11	Access Agreement	Montauk Beach	Acquired
18	300	47.00	3.00	8.000	Public	0.77	0.26	Access Agreement	Montauk Beach	Acquired
19	300	47.00	3.00	1.000	Public	0.74	0.22	Access Agreement	Montauk Beach	Acquired

FIRE ISLAND INLET TO MORICHES INLET STABILIZATION PROJECT										
No.	District	Section	Block	Lot	Owner	Parcel Area (AC)	Acquisition Area (AC)	Estate	Reach	Status
1	100	246.00	1.00	1.000	Public	243.03	8.01	Access Agreement	Robert Moses State Park	In Progress
2	500	498.00	1.00	1.000	Public	12866.44	71.48	Access Agreement	Robert Moses State Park	In Progress
3	500	489.00	1.00	2.001	Public	742.87	13.15	Access Agreement	Robert Moses State Park	In Progress
4	500	490.00	1.00	1.000	Public	77.45	5.23	Special Use Permit	Fire Island Lighthouse	In Progress

FIRE ISLAND INLET TO MORICHES INLET STABILIZATION PROJECT										
No.	District	Section	Block	Lot	Owner	Parcel Area (AC)	Acquisition Area (AC)	Estate	Reach	Status
5	500	490.00	1.00	2.000	Public	134.79	8.16	Special Use Permit	Fire Island Lighthouse	In Progress
6	500	491.00	1.00	2.000	Public	13.75	0.96	Special Use Permit	Fire Island Lighthouse	In Progress
7	500	498.00	1.00	1.000	Public	12866.44	10.26	Access Agreement	Kismet to Lonelyville	In Progress
8	503	4.00	1.00	4.000	Public	0.70	0.30	Access Agreement	Kismet to Lonelyville	In Progress
9	503	4.00	1.00	5.000	Public	0.10	0.10	Access Agreement	Kismet to Lonelyville	In Progress
10	503	4.00	1.00	6.000	Public	0.31	0.31	Special Use Permit	Kismet to Lonelyville	In Progress
11	503	4.00	1.00	7.000	Public	1.27	0.33	Access Agreement	Kismet to Lonelyville	In Progress
12	500	492.00	1.00	9.002	Private	0.45	0.35	Easement	Kismet to Lonelyville	In Progress
13	500	492.00	1.00	11.001	Private	0.31	0.31	Easement	Kismet to Lonelyville	In Progress
14	503	4.00	1.00	12.000	Public	0.19	0.06	Access Agreement	Kismet to Lonelyville	In Progress
15	500	492.00	1.00	12.000	Private	0.15	0.04	Easement	Kismet to Lonelyville	In Progress
16	503	4.00	1.00	13.000	Public	0.25	0.25	Access Agreement	Kismet to Lonelyville	In Progress
17	503	4.00	1.00	14.000	Public	0.40	0.40	Special Use Permit	Kismet to Lonelyville	In Progress
18	500	494.00	1.00	15.000	Private	0.23	0.04	Easement	Kismet to Lonelyville	In Progress
19	503	4.00	1.00	15.000	Public	0.26	0.26	Access Agreement	Kismet to Lonelyville	In Progress
20	503	4.00	1.00	16.000	Public	0.61	0.05	Access Agreement	Kismet to Lonelyville	In Progress
21	500	494.00	1.00	19.000	Private	0.15	0.07	Easement	Kismet to Lonelyville	In Progress
22	503	4.00	1.00	19.000	Private	0.28	0.28	Easement	Kismet to Lonelyville	In Progress
23	500	494.00	1.00	20.000	Private	0.15	0.06	Easement	Kismet to Lonelyville	In Progress
24	503	4.00	1.00	20.000	Public	0.40	0.40	Special Use Permit	Kismet to Lonelyville	In Progress
25	500	494.00	1.00	21.000	Private	0.15	0.06	Easement	Kismet to Lonelyville	In Progress
26	503	4.00	1.00	21.000	Public	0.27	0.27	Access Agreement	Kismet to Lonelyville	In Progress
27	500	494.00	1.00	22.000	Private	0.65	0.65	Easement	Kismet to Lonelyville	In Progress
28	500	494.00	1.00	23.000	Private	0.15	0.05	Easement	Kismet to Lonelyville	In Progress
29	500	494.00	1.00	24.000	Private	0.15	0.04	Easement	Kismet to Lonelyville	In Progress
30	500	492.00	1.00	27.003	Private	0.33	0.18	Easement	Kismet to Lonelyville	In Progress
31	500	492.00	1.00	28.000	Public	0.10	0.10	Access Agreement	Kismet to Lonelyville	In Progress
32	500	492.00	1.00	29.000	Public	0.17	0.17	Access Agreement	Kismet to Lonelyville	In Progress

FIRE ISLAND INLET TO MORICHES INLET STABILIZATION PROJECT										
No.	District	Section	Block	Lot	Owner	Parcel Area (AC)	Acquisition Area (AC)	Estate	Reach	Status
33	500	492.00	1.00	30.000	Public	0.19	0.19	Special Use Permit	Kismet to Lonelyville	In Progress
34	500	492.00	1.00	32.000	Public	0.15	0.15	Access Agreement	Kismet to Lonelyville	In Progress
35	500	492.00	1.00	33.000	Private	0.11	0.02	Easement	Kismet to Lonelyville	In Progress
36	503	4.00	1.00	33.002	Private	0.31	0.14	Easement	Kismet to Lonelyville	In Progress
37	503	4.00	1.00	34.000	Public	0.17	0.17	Special Use Permit	Kismet to Lonelyville	In Progress
38	503	4.00	1.00	35.000	Public	0.42	0.42	Special Use Permit	Kismet to Lonelyville	In Progress
39	503	4.00	1.00	36.000	Private	0.17	0.17	Easement	Kismet to Lonelyville	In Progress
40	503	4.00	1.00	37.000	Public	0.23	0.13	Access Agreement	Kismet to Lonelyville	In Progress
41	503	4.00	1.00	42.003	Private	0.35	0.07	Easement	Kismet to Lonelyville	In Progress
42	500	492.00	1.00	49.000	Private	0.15	0.05	Easement	Kismet to Lonelyville	In Progress
43	500	492.00	1.00	50.000	Private	0.11	0.11	Easement	Kismet to Lonelyville	In Progress
44	500	492.00	1.00	51.000	Public	0.10	0.10	Special Use Permit	Kismet to Lonelyville	In Progress
45	503	4.00	2.00	6.001	Private	0.23	0.07	Easement	Kismet to Lonelyville	In Progress
46	503	4.00	2.00	7.000	Public	0.23	0.23	Access Agreement	Kismet to Lonelyville	In Progress
47	500	492.00	2.00	8.000	Private	0.15	0.04	Easement	Kismet to Lonelyville	In Progress
48	503	4.00	2.00	8.000	Public	0.42	0.42	Special Use Permit	Kismet to Lonelyville	In Progress
49	500	492.00	2.00	9.000	Public	0.15	0.14	Access Agreement	Kismet to Lonelyville	In Progress
50	503	4.00	2.00	9.000	Public	0.12	0.12	Access Agreement	Kismet to Lonelyville	In Progress
51	500	492.00	2.00	10.000	Public	0.08	0.08	Access Agreement	Kismet to Lonelyville	In Progress
52	503	4.00	2.00	10.000	Public	0.16	0.16	Special Use Permit	Kismet to Lonelyville	In Progress
53	500	492.00	2.00	11.000	Private	0.08	0.08	Easement	Kismet to Lonelyville	In Progress
54	500	492.00	2.00	12.000	Public	0.18	0.18	Access Agreement	Kismet to Lonelyville	In Progress
55	503	4.00	2.00	12.001	Private	0.20	0.02	Easement	Kismet to Lonelyville	In Progress
56	500	492.00	2.00	14.000	Public	0.18	0.18	Access Agreement	Kismet to Lonelyville	In Progress
57	500	492.00	2.00	15.000	Private	0.18	0.00	Easement	Kismet to Lonelyville	In Progress
58	503	4.00	2.00	22.000	Private	0.36	0.30	Easement	Kismet to Lonelyville	In Progress
59	500	494.00	2.00	23.000	Private	0.15	0.11	Fee	Kismet to Lonelyville	In Progress
60	503	4.00	2.00	23.000	Private	0.20	0.20	Easement	Kismet to Lonelyville	In Progress

FIRE ISLAND INLET TO MORICHES INLET STABILIZATION PROJECT										
No.	District	Section	Block	Lot	Owner	Parcel Area (AC)	Acquisition Area (AC)	Estate	Reach	Status
61	500	494.00	2.00	24.000	Private	0.15	0.10	Fee	Kismet to Lonelyville	In Progress
62	503	4.00	2.00	24.000	Public	0.20	0.20	Access Agreement	Kismet to Lonelyville	In Progress
63	500	494.00	2.00	25.000	Private	0.11	0.11	Easement	Kismet to Lonelyville	In Progress
64	503	4.00	2.00	25.001	Private	0.25	0.25	Easement	Kismet to Lonelyville	In Progress
65	500	494.00	2.00	26.000	Private	0.12	0.12	Easement	Kismet to Lonelyville	In Progress
66	500	494.00	2.00	27.000	Private	0.12	0.12	Easement	Kismet to Lonelyville	In Progress
67	500	492.00	2.00	28.000	Private	0.14	0.02	Easement	Kismet to Lonelyville	In Progress
68	500	494.00	2.00	28.000	Private	0.13	0.13	Easement	Kismet to Lonelyville	In Progress
69	500	494.00	2.00	29.000	Private	0.13	0.13	Easement	Kismet to Lonelyville	In Progress
70	500	492.00	2.00	29.000	Public	0.14	0.14	Access Agreement	Kismet to Lonelyville	In Progress
71	500	494.00	2.00	30.000	Private	0.15	0.09	Easement	Kismet to Lonelyville	In Progress
72	500	492.00	2.00	30.000	Private	0.18	0.18	Easement	Kismet to Lonelyville	In Progress
73	500	494.00	2.00	31.000	Private	0.15	0.09	Easement	Kismet to Lonelyville	In Progress
74	500	492.00	2.00	31.000	Public	0.08	0.08	Access Agreement	Kismet to Lonelyville	In Progress
75	500	494.00	2.00	32.000	Private	0.15	0.08	Easement	Kismet to Lonelyville	In Progress
76	500	492.00	2.00	32.000	Public	0.08	0.08	Access Agreement	Kismet to Lonelyville	In Progress
77	500	492.00	2.00	33.000	Public	0.08	0.08	Special Use Permit	Kismet to Lonelyville	In Progress
78	503	4.00	2.00	34.000	Private	0.12	0.03	Easement	Kismet to Lonelyville	In Progress
79	500	492.00	2.00	34.000	Public	0.08	0.08	Special Use Permit	Kismet to Lonelyville	In Progress
80	500	492.00	2.00	35.000	Private	0.23	0.05	Easement	Kismet to Lonelyville	In Progress
81	503	4.00	2.00	35.000	Public	0.23	0.23	Access Agreement	Kismet to Lonelyville	In Progress
82	503	4.00	2.00	36.000	Public	0.29	0.29	Access Agreement	Kismet to Lonelyville	In Progress
83	503	4.00	2.00	37.000	Private	0.12	0.02	Easement	Kismet to Lonelyville	In Progress
84	503	4.00	2.00	42.000	Public	0.27	0.27	Access Agreement	Kismet to Lonelyville	In Progress
85	503	4.00	2.00	43.000	Private	0.12	0.01	Easement	Kismet to Lonelyville	In Progress
86	500	494.00	2.00	46.001	Private	0.89	0.24	Easement	Kismet to Lonelyville	In Progress
87	500	492.00	2.00	50.000	Public	0.15	0.11	Access Agreement	Kismet to Lonelyville	In Progress
88	500	492.00	2.00	52.000	Private	0.07	0.07	Easement	Kismet to Lonelyville	In Progress

FIRE ISLAND INLET TO MORICHES INLET STABILIZATION PROJECT										
No.	District	Section	Block	Lot	Owner	Parcel Area (AC)	Acquisition Area (AC)	Estate	Reach	Status
89	503	4.00	2.00	52.000	Public	0.42	0.42	Special Use Permit	Kismet to Lonelyville	In Progress
90	500	492.00	2.00	53.000	Public	0.08	0.08	Special Use Permit	Kismet to Lonelyville	In Progress
91	503	4.00	2.00	53.000	Public	0.41	0.41	Special Use Permit	Kismet to Lonelyville	In Progress
92	500	492.00	2.00	54.000	Public	0.08	0.08	Access Agreement	Kismet to Lonelyville	In Progress
93	500	492.00	2.00	55.000	Public	0.08	0.08	Access Agreement	Kismet to Lonelyville	In Progress
94	500	492.00	2.00	56.000	Private	0.08	0.08	Easement	Kismet to Lonelyville	In Progress
95	500	492.00	2.00	57.000	Public	0.07	0.07	Special Use Permit	Kismet to Lonelyville	In Progress
96	503	4.00	2.00	57.002	Private	0.51	0.27	Easement	Kismet to Lonelyville	In Progress
97	500	492.00	2.00	59.001	Private	0.29	0.10	Easement	Kismet to Lonelyville	In Progress
98	503	4.00	2.00	71.000	Public	0.12	0.11	Access Agreement	Kismet to Lonelyville	In Progress
99	503	4.00	2.00	72.000	Public	0.16	0.16	Access Agreement	Kismet to Lonelyville	In Progress
100	503	4.00	2.00	73.000	Public	0.21	0.21	Special Use Permit	Kismet to Lonelyville	In Progress
101	503	4.00	2.00	74.001	Private	0.23	0.04	Easement	Kismet to Lonelyville	In Progress
102	500	491.00	3.00	6.000	Private	0.14	0.02	Easement	Kismet to Lonelyville	In Progress
103	500	491.00	3.00	7.000	Public	0.31	0.31	Special Use Permit	Kismet to Lonelyville	In Progress
104	500	491.00	3.00	8.000	Public	0.15	0.15	Special Use Permit	Kismet to Lonelyville	In Progress
105	500	492.00	3.00	9.000	Private	0.07	0.01	Easement	Kismet to Lonelyville	In Progress
106	500	491.00	3.00	9.000	Public	0.23	0.23	Access Agreement	Kismet to Lonelyville	In Progress
107	500	491.00	3.00	10.000	Private	0.14	0.01	Easement	Kismet to Lonelyville	In Progress
108	500	492.00	3.00	11.001	Public	0.15	0.15	Access Agreement	Kismet to Lonelyville	In Progress
109	500	492.00	3.00	12.000	Public	0.09	0.09	Access Agreement	Kismet to Lonelyville	In Progress

FIRE ISLAND INLET TO MORICHES INLET STABILIZATION PROJECT										
No.	District	Section	Block	Lot	Owner	Parcel Area (AC)	Acquisition Area (AC)	Estate	Reach	Status
110	500	494.00	3.00	13.000	Private	0.30	0.15	Easement	Kismet to Lonelyville	In Progress
111	500	492.00	3.00	13.000	Private	0.08	0.08	Easement	Kismet to Lonelyville	In Progress
112	500	494.00	3.00	14.000	Public	0.09	0.09	Special Use Permit	Kismet to Lonelyville	In Progress
113	500	492.00	3.00	14.000	Private	0.08	0.08	Easement	Kismet to Lonelyville	In Progress
114	500	494.00	3.00	15.000	Private	0.46	0.46	Easement	Kismet to Lonelyville	In Progress
115	500	492.00	3.00	15.000	Public	0.08	0.08	Access Agreement	Kismet to Lonelyville	In Progress
116	500	492.00	3.00	16.000	Public	0.14	0.14	Access Agreement	Kismet to Lonelyville	In Progress
117	500	492.00	3.00	17.000	Private	0.11	0.00	Easement	Kismet to Lonelyville	In Progress
118	500	494.00	3.00	20.001	Private	0.68	0.24	Easement	Kismet to Lonelyville	In Progress
119	500	491.00	3.00	21.000	Private	0.14	0.00	Easement	Kismet to Lonelyville	In Progress
120	500	491.00	3.00	22.000	Public	0.23	0.23	Special Use Permit	Kismet to Lonelyville	In Progress
121	500	491.00	3.00	23.000	Private	0.11	0.11	Easement	Kismet to Lonelyville	In Progress
122	500	491.00	3.00	24.000	Private	0.04	0.04	Easement	Kismet to Lonelyville	In Progress
123	500	491.00	3.00	25.000	Public	0.23	0.23	Access Agreement	Kismet to Lonelyville	In Progress
124	500	491.00	3.00	28.001	Private	0.41	0.00	Easement	Kismet to Lonelyville	In Progress
125	500	492.00	3.00	33.001	Private	0.22	0.14	Easement	Kismet to Lonelyville	In Progress

FIRE ISLAND INLET TO MORICHES INLET STABILIZATION PROJECT										
No.	District	Section	Block	Lot	Owner	Parcel Area (AC)	Acquisition Area (AC)	Estate	Reach	Status
126	500	492.00	3.00	34.000	Public	0.09	0.09	Special Use Permit	Kismet to Lonelyville	In Progress
127	500	492.00	3.00	35.000	Public	0.08	0.08	Special Use Permit	Kismet to Lonelyville	In Progress
128	500	491.00	3.00	36.000	Public	0.11	0.07	Access Agreement	Kismet to Lonelyville	In Progress
129	500	492.00	3.00	36.000	Public	0.09	0.09	Special Use Permit	Kismet to Lonelyville	In Progress
130	500	492.00	3.00	37.000	Public	0.08	0.08	Special Use Permit	Kismet to Lonelyville	In Progress
131	500	491.00	3.00	37.000	Private	0.11	0.11	Easement	Kismet to Lonelyville	In Progress
132	500	491.00	3.00	38.000	Private	0.11	0.11	Easement	Kismet to Lonelyville	In Progress
133	500	492.00	3.00	39.000	Private	0.22	0.12	Easement	Kismet to Lonelyville	In Progress
134	500	491.00	3.00	39.000	Private	0.07	0.07	Easement	Kismet to Lonelyville	In Progress
135	500	491.00	3.00	40.000	Public	0.15	0.15	Special Use Permit	Kismet to Lonelyville	In Progress
136	500	491.00	3.00	41.000	Public	0.14	0.14	Special Use Permit	Kismet to Lonelyville	In Progress
137	500	491.00	3.00	42.000	Public	0.07	0.07	Access Agreement	Kismet to Lonelyville	In Progress
138	500	494.00	3.00	42.005	Private	0.35	0.37	Easement	Kismet to Lonelyville	In Progress
139	500	494.00	3.00	43.000	Public	0.11	0.11	Access Agreement	Kismet to Lonelyville	In Progress
140	500	491.00	3.00	43.000	Private	0.07	0.07	Easement	Kismet to Lonelyville	In Progress
141	500	494.00	3.00	44.000	Private	0.23	0.33	Easement	Kismet to Lonelyville	In Progress

FIRE ISLAND INLET TO MORICHES INLET STABILIZATION PROJECT										
No.	District	Section	Block	Lot	Owner	Parcel Area (AC)	Acquisition Area (AC)	Estate	Reach	Status
14 2	500	491.00	3.00	44.000	Public	0.07	0.07	Special Use Permit	Kismet to Lonelyville	In Progress
14 3	500	494.00	3.00	45.000	Private	0.33	0.52	Easement	Kismet to Lonelyville	In Progress
14 4	500	491.00	3.00	45.000	Private	0.07	0.07	Easement	Kismet to Lonelyville	In Progress
14 5	500	491.00	3.00	46.002	Public	0.09	0.07	Special Use Permit	Kismet to Lonelyville	In Progress
14 6	500	492.00	3.00	51.000	Public	0.15	0.08	Access Agreement	Kismet to Lonelyville	In Progress
14 7	500	492.00	3.00	52.000	Private	0.14	0.14	Easement	Kismet to Lonelyville	In Progress
14 8	500	491.00	3.00	52.002	Public	0.10	0.07	Access Agreement	Kismet to Lonelyville	In Progress
14 9	500	492.00	3.00	53.000	Public	0.23	0.23	Special Use Permit	Kismet to Lonelyville	In Progress
15 0	500	491.00	3.00	53.000	Public	0.07	0.07	Access Agreement	Kismet to Lonelyville	In Progress
15 1	500	491.00	3.00	54.000	Private	0.07	0.07	Easement	Kismet to Lonelyville	In Progress
15 2	500	491.00	3.00	55.000	Public	0.08	0.08	Access Agreement	Kismet to Lonelyville	In Progress
15 3	500	492.00	3.00	55.001	Private	0.18	0.07	Easement	Kismet to Lonelyville	In Progress
15 4	500	491.00	3.00	56.000	Private	0.07	0.07	Easement	Kismet to Lonelyville	In Progress
15 5	500	491.00	3.00	57.000	Public	0.15	0.15	Special Use Permit	Kismet to Lonelyville	In Progress
15 6	500	494.00	3.00	58.001	Private	0.41	0.09	Easement	Kismet to Lonelyville	In Progress
15 7	500	491.00	3.00	64.000	Public	0.17	0.14	Access Agreement	Kismet to Lonelyville	In Progress

FIRE ISLAND INLET TO MORICHES INLET STABILIZATION PROJECT										
No.	District	Section	Block	Lot	Owner	Parcel Area (AC)	Acquisition Area (AC)	Estate	Reach	Status
158	500	491.00	3.00	65.000	Public	0.15	0.15	Special Use Permit	Kismet to Lonelyville	In Progress
159	500	491.00	3.00	66.000	Private	0.08	0.07	Easement	Kismet to Lonelyville	In Progress
160	500	491.00	3.00	67.001	Public	0.18	0.06	Access Agreement	Kismet to Lonelyville	In Progress
161	500	491.00	3.00	68.001	Public	0.17	0.05	Access Agreement	Kismet to Lonelyville	In Progress
162	500	491.00	4.00	1.000	Public	7.66	0.51	Special Use Permit	Kismet to Lonelyville	In Progress
163	503	2.00	4.00	6.000	Public	0.13	0.13	Access Agreement	Kismet to Lonelyville	In Progress
164	503	2.00	4.00	7.000	Public	0.27	0.15	Access Agreement	Kismet to Lonelyville	In Progress
165	503	2.00	4.00	8.000	Public	0.51	0.31	Access Agreement	Kismet to Lonelyville	In Progress
166	500	492.00	4.00	9.000	Public	0.08	0.02	Special Use Permit	Kismet to Lonelyville	In Progress
167	503	2.00	4.00	9.000	Public	0.26	0.26	Special Use Permit	Kismet to Lonelyville	In Progress
168	500	492.00	4.00	10.000	Public	0.07	0.07	Access Agreement	Kismet to Lonelyville	In Progress
169	500	494.00	4.00	10.006	Private	0.68	0.66	Easement	Kismet to Lonelyville	In Progress
170	500	494.00	4.00	11.000	Private	0.27	0.03	Easement	Kismet to Lonelyville	In Progress
171	500	492.00	4.00	11.000	Public	0.17	0.17	Special Use Permit	Kismet to Lonelyville	In Progress
172	503	2.00	4.00	11.001	Private	0.31	0.11	Easement	Kismet to Lonelyville	In Progress
173	500	494.00	4.00	12.000	Private	0.07	0.07	Easement	Kismet to Lonelyville	In Progress

FIRE ISLAND INLET TO MORICHES INLET STABILIZATION PROJECT										
No.	District	Section	Block	Lot	Owner	Parcel Area (AC)	Acquisition Area (AC)	Estate	Reach	Status
17 4	500	492.00	4.00	12.000	Public	0.09	0.09	Access Agreement	Kismet to Lonelyville	In Progress
17 5	503	2.00	4.00	12.001	Public	0.23	0.22	Special Use Permit	Kismet to Lonelyville	In Progress
17 6	500	494.00	4.00	13.000	Public	0.12	0.12	Special Use Permit	Kismet to Lonelyville	In Progress
17 7	500	492.00	4.00	13.000	Public	0.09	0.09	Special Use Permit	Kismet to Lonelyville	In Progress
17 8	500	494.00	4.00	14.000	Private	0.11	0.11	Easement	Kismet to Lonelyville	In Progress
17 9	500	492.00	4.00	16.001	Private	0.22	0.08	Easement	Kismet to Lonelyville	In Progress
18 0	503	2.00	4.00	21.000	Private	0.12	0.03	Easement	Kismet to Lonelyville	In Progress
18 1	503	2.00	4.00	22.000	Public	0.23	0.23	Special Use Permit	Kismet to Lonelyville	In Progress
18 2	503	2.00	4.00	23.000	Public	0.11	0.11	Access Agreement	Kismet to Lonelyville	In Progress
18 3	503	2.00	4.00	24.000	Public	0.19	0.19	Access Agreement	Kismet to Lonelyville	In Progress
18 4	503	2.00	4.00	25.000	Private	0.27	0.17	Easement	Kismet to Lonelyville	In Progress
18 5	500	491.00	4.00	25.000	Private	0.14	0.02	Easement	Kismet to Lonelyville	In Progress
18 6	500	491.00	4.00	26.000	Public	0.14	0.14	Special Use Permit	Kismet to Lonelyville	In Progress
18 7	500	491.00	4.00	27.000	Public	0.18	0.17	Special Use Permit	Kismet to Lonelyville	In Progress
18 8	500	491.00	4.00	28.000	Public	0.17	0.17	Access Agreement	Kismet to Lonelyville	In Progress
18 9	500	491.00	4.00	29.000	Public	0.03	0.03	Special Use Permit	Kismet to Lonelyville	In Progress

FIRE ISLAND INLET TO MORICHES INLET STABILIZATION PROJECT										
No.	District	Section	Block	Lot	Owner	Parcel Area (AC)	Acquisition Area (AC)	Estate	Reach	Status
190	500	491.00	4.00	30.000	Private	0.25	0.15	Easement	Kismet to Lonelyville	In Progress
191	503	2.00	4.00	34.001	Private	0.23	0.13	Easement	Kismet to Lonelyville	In Progress
192	503	2.00	4.00	35.000	Public	0.23	0.23	Access Agreement	Kismet to Lonelyville	In Progress
193	500	492.00	4.00	36.000	Private	0.18	0.10	Easement	Kismet to Lonelyville	In Progress
194	503	2.00	4.00	36.000	Public	0.45	0.33	Access Agreement	Kismet to Lonelyville	In Progress
195	500	492.00	4.00	37.000	Public	0.17	0.17	Access Agreement	Kismet to Lonelyville	In Progress
196	503	2.00	4.00	37.000	Public	0.43	0.35	Access Agreement	Kismet to Lonelyville	In Progress
197	503	2.00	4.00	38.000	Public	0.44	0.36	Access Agreement	Kismet to Lonelyville	In Progress
198	500	492.00	4.00	38.000	Public	0.09	0.09	Access Agreement	Kismet to Lonelyville	In Progress
199	500	492.00	4.00	39.000	Public	0.09	0.09	Access Agreement	Kismet to Lonelyville	In Progress
200	500	492.00	4.00	40.000	Private	0.21	0.09	Easement	Kismet to Lonelyville	In Progress
201	503	2.00	4.00	42.001	Private	0.38	0.11	Easement	Kismet to Lonelyville	In Progress
202	500	494.00	4.00	42.005	Public	0.59	0.51	Special Use Permit	Kismet to Lonelyville	In Progress
203	503	2.00	4.00	43.000	Public	0.25	0.25	Access Agreement	Kismet to Lonelyville	In Progress
204	503	2.00	4.00	44.002	Public	0.13	0.74	Special Use Permit	Kismet to Lonelyville	In Progress
205	500	491.00	4.00	54.000	Public	8.46	0.78	Special Use Permit	Kismet to Lonelyville	In Progress

FIRE ISLAND INLET TO MORICHES INLET STABILIZATION PROJECT										
No.	District	Section	Block	Lot	Owner	Parcel Area (AC)	Acquisition Area (AC)	Estate	Reach	Status
206	500	491.00	4.00	55.000	Public	4.28	0.39	Special Use Permit	Kismet to Lonelyville	In Progress
207	500	494.00	4.00	57.000	Private	0.69	0.53	Easement	Kismet to Lonelyville	In Progress
208	500	494.00	4.00	59.000	Private	0.57	0.52	Easement	Kismet to Lonelyville	In Progress
209	500	494.00	4.00	63.000	Private	0.52	0.10	Easement	Kismet to Lonelyville	In Progress
210	503	2.00	5.00	5.000	Private	0.23	0.10	Easement	Kismet to Lonelyville	In Progress
211	503	2.00	5.00	6.000	Public	0.12	0.12	Access Agreement	Kismet to Lonelyville	In Progress
212	500	492.00	5.00	6.002	Private	0.51	0.18	Easement	Kismet to Lonelyville	In Progress
213	500	492.00	5.00	7.000	Public	0.19	0.17	Special Use Permit	Kismet to Lonelyville	In Progress
214	503	2.00	5.00	7.000	Public	0.14	0.14	Access Agreement	Kismet to Lonelyville	In Progress
215	503	2.00	5.00	8.000	Public	0.32	0.25	Access Agreement	Kismet to Lonelyville	In Progress
216	503	2.00	5.00	9.000	Private	0.10	0.08	Easement	Kismet to Lonelyville	In Progress
217	503	2.00	5.00	10.000	Public	0.14	0.14	Access Agreement	Kismet to Lonelyville	In Progress
218	503	2.00	5.00	11.000	Public	0.12	0.12	Access Agreement	Kismet to Lonelyville	In Progress
219	503	2.00	5.00	13.001	Private	0.31	0.10	Easement	Kismet to Lonelyville	In Progress
220	500	492.00	5.00	15.003	Private	0.28	0.17	Easement	Kismet to Lonelyville	In Progress
221	503	2.00	5.00	23.000	Private	0.12	0.01	Easement	Kismet to Lonelyville	In Progress

FIRE ISLAND INLET TO MORICHES INLET STABILIZATION PROJECT										
No.	District	Section	Block	Lot	Owner	Parcel Area (AC)	Acquisition Area (AC)	Estate	Reach	Status
22 2	503	2.00	5.00	24.000	Public	0.12	0.12	Special Use Permit	Kismet to Lonelyville	In Progress
22 3	503	2.00	5.00	25.000	Public	0.23	0.23	Access Agreement	Kismet to Lonelyville	In Progress
22 4	503	2.00	5.00	26.000	Public	0.21	0.17	Access Agreement	Kismet to Lonelyville	In Progress
22 5	503	2.00	5.00	27.000	Public	0.10	0.08	Special Use Permit	Kismet to Lonelyville	In Progress
22 6	503	2.00	5.00	28.000	Public	0.11	0.09	Access Agreement	Kismet to Lonelyville	In Progress
22 7	503	2.00	5.00	29.000	Public	0.12	0.12	Access Agreement	Kismet to Lonelyville	In Progress
22 8	503	2.00	5.00	30.000	Public	0.12	0.12	Special Use Permit	Kismet to Lonelyville	In Progress
22 9	503	2.00	5.00	31.000	Private	0.24	0.12	Easement	Kismet to Lonelyville	In Progress
23 0	503	2.00	5.00	41.000	Public	0.24	0.24	Access Agreement	Kismet to Lonelyville	In Progress
23 1	503	2.00	5.00	42.000	Public	0.30	0.25	Access Agreement	Kismet to Lonelyville	In Progress
23 2	503	2.00	5.00	43.000	Public	0.10	0.08	Access Agreement	Kismet to Lonelyville	In Progress
23 3	503	2.00	5.00	44.000	Public	0.29	0.29	Access Agreement	Kismet to Lonelyville	In Progress
23 4	503	2.00	5.00	45.006	Private	0.44	0.17	Easement	Kismet to Lonelyville	In Progress
23 5	503	2.00	6.00	5.000	Public	0.23	0.62	Access Agreement	Kismet to Lonelyville	In Progress
23 6	503	2.00	6.00	6.000	Public	0.14	0.14	Special Use Permit	Kismet to Lonelyville	In Progress
23 7	503	2.00	6.00	7.000	Public	0.40	0.31	Access Agreement	Kismet to Lonelyville	In Progress

FIRE ISLAND INLET TO MORICHES INLET STABILIZATION PROJECT										
No.	District	Section	Block	Lot	Owner	Parcel Area (AC)	Acquisition Area (AC)	Estate	Reach	Status
23 8	503	2.00	6.00	8.000	Public	0.10	0.10	Special Use Permit	Kismet to Lonelyville	In Progress
23 9	503	2.00	6.00	9.000	Public	0.23	0.23	Access Agreement	Kismet to Lonelyville	In Progress
24 0	503	2.00	6.00	10.000	Private	0.18	0.01	Easement	Kismet to Lonelyville	In Progress
24 1	503	2.00	6.00	21.000	Public	0.23	0.23	Access Agreement	Kismet to Lonelyville	In Progress
24 2	503	2.00	6.00	22.000	Public	0.45	0.37	Access Agreement	Kismet to Lonelyville	In Progress
24 3	503	2.00	6.00	23.000	Public	0.12	0.12	Access Agreement	Kismet to Lonelyville	In Progress
24 4	503	2.00	6.00	24.000	Public	0.12	0.12	Special Use Permit	Kismet to Lonelyville	In Progress
24 5	503	2.00	6.00	25.001	Private	0.27	0.21	Easement	Kismet to Lonelyville	In Progress
24 6	503	2.00	6.00	32.001	Public	0.48	0.34	Access Agreement	Kismet to Lonelyville	In Progress
24 7	503	2.00	6.00	33.000	Public	0.45	0.45	Access Agreement	Kismet to Lonelyville	In Progress
24 8	503	2.00	6.00	34.000	Public	0.25	0.25	Access Agreement	Kismet to Lonelyville	In Progress
24 9	503	2.00	6.00	35.000	Private	0.31	0.08	Easement	Kismet to Lonelyville	In Progress
25 0	500	496.00	1.00	1.000	Public	8.61	1.46	Special Use Permit	Town Beach to Corneille Estates	In Progress
25 1	500	495.00	1.00	1.000	Public	29.41	3.41	Access Agreement	Town Beach to Corneille Estates	In Progress
25 2	500	498.00	1.00	1.000	Public	12866.44	0.03	Access Agreement	Town Beach to Corneille Estates	In Progress
25 3	500	498.00	1.00	1.000	Public	12866.44	2.59	Access Agreement	Town Beach to Corneille Estates	In Progress

FIRE ISLAND INLET TO MORICHES INLET STABILIZATION PROJECT										
No.	District	Section	Block	Lot	Owner	Parcel Area (AC)	Acquisition Area (AC)	Estate	Reach	Status
25 4	500	496.00	1.00	2.000	Public	10.01	1.53	Special Use Permit	Town Beach to Corneille Estates	In Progress
25 5	500	495.00	1.00	9.000	Private	0.13	0.00	Easement	Town Beach to Corneille Estates	In Progress
25 6	500	495.00	1.00	10.000	Public	0.04	0.04	Access Agreement	Town Beach to Corneille Estates	In Progress
25 7	500	495.00	1.00	11.000	Public	0.31	0.31	Special Use Permit	Town Beach to Corneille Estates	In Progress
25 8	500	495.00	1.00	12.000	Public	0.11	0.11	Special Use Permit	Town Beach to Corneille Estates	In Progress
25 9	500	495.00	1.00	13.000	Public	0.07	0.03	Special Use Permit	Town Beach to Corneille Estates	In Progress
26 0	500	496.00	1.00	13.000	Private	0.16	0.06	Easement	Town Beach to Corneille Estates	In Progress
26 1	500	496.00	1.00	14.000	Public	0.15	0.15	Special Use Permit	Town Beach to Corneille Estates	In Progress
26 2	500	496.00	1.00	15.000	Public	0.22	0.22	Special Use Permit	Town Beach to Corneille Estates	In Progress
26 3	500	496.00	1.00	16.000	Private	0.26	0.26	Easement	Town Beach to Corneille Estates	In Progress
26 4	500	496.00	1.00	17.000	Public	0.26	0.26	Access Agreement	Town Beach to Corneille Estates	In Progress
26 5	500	496.00	1.00	18.000	Private	0.13	0.13	Fee	Town Beach to Corneille Estates	In Progress
26 6	500	496.00	1.00	19.000	Private	0.13	0.13	Easement	Town Beach to Corneille Estates	In Progress
26 7	500	496.00	1.00	20.000	Private	0.13	0.05	Easement	Town Beach to Corneille Estates	In Progress
26 8	500	495.00	1.00	32.000	Private	0.11	0.02	Easement	Town Beach to Corneille Estates	In Progress
26 9	500	495.00	1.00	33.000	Public	0.15	0.15	Access Agreement	Town Beach to Corneille Estates	In Progress

FIRE ISLAND INLET TO MORICHES INLET STABILIZATION PROJECT										
No.	District	Section	Block	Lot	Owner	Parcel Area (AC)	Acquisition Area (AC)	Estate	Reach	Status
27 0	500	495.00	1.00	34.000	Public	0.32	0.32	Special Use Permit	Town Beach to Corneille Estates	In Progress
27 1	500	495.00	1.00	35.000	Private	0.14	0.13	Easement	Town Beach to Corneille Estates	In Progress
27 2	500	496.00	1.00	36.000	Private	0.13	0.13	Easement	Town Beach to Corneille Estates	In Progress
27 3	500	495.00	1.00	36.000	Public	0.34	0.34	Special Use Permit	Town Beach to Corneille Estates	In Progress
27 4	500	496.00	1.00	52.000	Private	0.13	0.01	Easement	Town Beach to Corneille Estates	In Progress
27 5	500	496.00	1.00	53.000	Public	0.13	0.12	Special Use Permit	Town Beach to Corneille Estates	In Progress
27 6	500	496.00	2.00	2.000	Public	16.20	1.47	Special Use Permit	Town Beach to Corneille Estates	In Progress
27 7	500	495.00	2.00	4.000	Private	0.18	0.00	Easement	Town Beach to Corneille Estates	In Progress
27 8	500	495.00	2.00	5.000	Public	0.15	0.14	Special Use Permit	Town Beach to Corneille Estates	In Progress
27 9	500	495.00	2.00	6.000	Public	0.33	0.33	Special Use Permit	Town Beach to Corneille Estates	In Progress
28 0	500	495.00	2.00	7.001	Public	0.23	0.47	Special Use Permit	Town Beach to Corneille Estates	In Progress
28 1	500	496.00	2.00	8.012	Private	0.28	0.58	Easement	Town Beach to Corneille Estates	In Progress
28 2	500	496.00	2.00	8.040	Private	0.14	0.64	Easement	Town Beach to Corneille Estates	In Progress
28 3	500	495.00	2.00	19.000	Private	0.22	0.15	Easement	Town Beach to Corneille Estates	In Progress
28 4	500	495.00	2.00	20.000	Public	0.31	0.31	Special Use Permit	Town Beach to Corneille Estates	In Progress
28 5	500	495.00	2.00	21.000	Private	0.14	0.04	Easement	Town Beach to Corneille Estates	In Progress

FIRE ISLAND INLET TO MORICHES INLET STABILIZATION PROJECT										
No.	District	Section	Block	Lot	Owner	Parcel Area (AC)	Acquisition Area (AC)	Estate	Reach	Status
28 6	500	496.00	2.00	27.000	Private	0.24	0.14	Easement	Town Beach to Corneille Estates	In Progress
28 7	500	495.00	2.00	27.000	Private	0.14	0.02	Easement	Town Beach to Corneille Estates	In Progress
28 8	500	496.00	2.00	28.000	Private	0.31	0.31	Easement	Town Beach to Corneille Estates	In Progress
28 9	500	495.00	2.00	28.000	Public	0.14	0.14	Special Use Permit	Town Beach to Corneille Estates	In Progress
29 0	500	495.00	2.00	29.000	Public	0.29	0.29	Access Agreement	Town Beach to Corneille Estates	In Progress
29 1	500	495.00	2.00	30.000	Public	0.07	0.07	Special Use Permit	Town Beach to Corneille Estates	In Progress
29 2	500	495.00	2.00	31.000	Public	0.07	0.07	Special Use Permit	Town Beach to Corneille Estates	In Progress
29 3	500	495.00	2.00	32.001	Public	0.29	0.29	Special Use Permit	Town Beach to Corneille Estates	In Progress
29 4	500	495.00	2.00	41.000	Public	0.73	0.29	Special Use Permit	Town Beach to Corneille Estates	In Progress
29 5	500	495.00	2.00	42.000	Public	0.08	0.08	Special Use Permit	Town Beach to Corneille Estates	In Progress
29 6	500	495.00	2.00	43.000	Public	0.09	0.09	Special Use Permit	Town Beach to Corneille Estates	In Progress
29 7	500	495.00	2.00	47.000	Public	0.41	0.41	Special Use Permit	Town Beach to Corneille Estates	In Progress
29 8	500	496.00	3.00	14.000	Private	0.29	0.29	Easement	Town Beach to Corneille Estates	In Progress
29 9	500	496.00	3.00	23.001	Private	0.80	0.42	Easement	Town Beach to Corneille Estates	In Progress
30 0	500	496.00	3.00	24.000	Private	0.44	0.41	Easement	Town Beach to Corneille Estates	In Progress
30 1	500	496.00	3.00	71.000	Private	0.17	0.11	Easement	Town Beach to Corneille Estates	In Progress

FIRE ISLAND INLET TO MORICHES INLET STABILIZATION PROJECT										
No.	District	Section	Block	Lot	Owner	Parcel Area (AC)	Acquisition Area (AC)	Estate	Reach	Status
30 2	500	498.00	1.00	1.000	Public	12866.44	21.26	Access Agreement	Ocean Beach & Seaview	In Progress
30 3	502	2.00	1.00	14.000	Private	0.11	0.01	Easement	Ocean Beach & Seaview	In Progress
30 4	502	2.00	1.00	15.000	Public	0.11	0.11	Access Agreement	Ocean Beach & Seaview	In Progress
30 5	502	2.00	1.00	16.000	Public	0.12	0.12	Special Use Permit	Ocean Beach & Seaview	In Progress
30 6	502	2.00	1.00	17.000	Public	0.09	0.09	Access Agreement	Ocean Beach & Seaview	In Progress
30 7	502	2.00	1.00	18.000	Public	0.10	0.10	Access Agreement	Ocean Beach & Seaview	In Progress
30 8	502	2.00	1.00	19.000	Private	0.11	0.09	Easement	Ocean Beach & Seaview	In Progress
30 9	200	985.70	1.00	39.000	Private	0.10	0.00	Easement	Ocean Beach & Seaview	In Progress
31 0	502	2.00	1.00	50.001	Private	0.12	0.07	Easement	Ocean Beach & Seaview	In Progress
31 1	502	2.00	1.00	51.000	Public	0.12	0.12	Access Agreement	Ocean Beach & Seaview	In Progress
31 2	502	2.00	1.00	52.000	Public	0.12	0.12	Access Agreement	Ocean Beach & Seaview	In Progress
31 3	502	2.00	1.00	53.000	Public	0.09	0.09	Access Agreement	Ocean Beach & Seaview	In Progress
31 4	502	2.00	1.00	54.001	Private	0.12	0.04	Easement	Ocean Beach & Seaview	In Progress
31 5	502	2.00	2.00	13.000	Private	0.29	0.01	Easement	Ocean Beach & Seaview	In Progress
31 6	502	2.00	2.00	15.001	Public	0.20	0.20	Access Agreement	Ocean Beach & Seaview	In Progress
31 7	502	2.00	2.00	16.000	Public	0.17	0.17	Access Agreement	Ocean Beach & Seaview	In Progress

FIRE ISLAND INLET TO MORICHES INLET STABILIZATION PROJECT										
No.	District	Section	Block	Lot	Owner	Parcel Area (AC)	Acquisition Area (AC)	Estate	Reach	Status
318	500	497.00	2.00	17.000	Private	0.24	0.05	Easement	Ocean Beach & Seaview	In Progress
319	500	497.00	2.00	19.003	Private	0.38	0.05	Easement	Ocean Beach & Seaview	In Progress
320	500	497.00	2.00	47.000	Private	0.21	0.05	Easement	Ocean Beach & Seaview	In Progress
321	502	2.00	2.00	54.000	Public	0.18	0.17	Access Agreement	Ocean Beach & Seaview	In Progress
322	502	2.00	2.00	55.000	Private	0.20	0.18	Easement	Ocean Beach & Seaview	In Progress
323	500	497.00	2.00	64.000	Private	0.23	0.05	Easement	Ocean Beach & Seaview	In Progress
324	500	497.00	3.00	19.000	Private	0.06	0.06	Easement	Ocean Beach & Seaview	In Progress
325	502	2.00	3.00	20.000	Public	0.19	0.14	Access Agreement	Ocean Beach & Seaview	In Progress
326	500	497.00	3.00	20.003	Private	0.00	0.06	Easement	Ocean Beach & Seaview	In Progress
327	500	497.00	3.00	21.001	Private	0.33	0.03	Easement	Ocean Beach & Seaview	In Progress
328	502	2.00	3.00	22.001	Public	0.21	0.14	Access Agreement	Ocean Beach & Seaview	In Progress
329	500	497.00	3.00	50.000	Private	0.26	0.04	Easement	Ocean Beach & Seaview	In Progress
330	500	497.00	3.00	51.000	Private	0.15	0.15	Easement	Ocean Beach & Seaview	In Progress
331	500	497.00	3.00	53.003	Private	0.34	0.03	Easement	Ocean Beach & Seaview	In Progress
332	502	2.00	3.00	61.000	Private	0.10	0.06	Easement	Ocean Beach & Seaview	In Progress
333	502	2.00	3.00	62.000	Private	0.10	0.06	Easement	Ocean Beach & Seaview	In Progress

FIRE ISLAND INLET TO MORICHES INLET STABILIZATION PROJECT										
No.	District	Section	Block	Lot	Owner	Parcel Area (AC)	Acquisition Area (AC)	Estate	Reach	Status
33 4	502	2.00	3.00	63.000	Private	0.07	0.04	Easement	Ocean Beach & Seaview	In Progress
33 5	502	2.00	3.00	64.000	Public	0.14	0.07	Special Use Permit	Ocean Beach & Seaview	In Progress
33 6	500	497.00	4.00	12.000	Private	0.29	0.03	Easement	Ocean Beach & Seaview	In Progress
33 7	500	497.00	4.00	13.000	Private	0.09	0.09	Easement	Ocean Beach & Seaview	In Progress
33 8	500	497.00	4.00	14.000	Private	0.23	0.04	Easement	Ocean Beach & Seaview	In Progress
33 9	502	2.00	4.00	19.000	Public	0.20	0.10	Access Agreement	Ocean Beach & Seaview	In Progress
34 0	502	2.00	4.00	20.000	Public	0.24	0.10	Access Agreement	Ocean Beach & Seaview	In Progress
34 1	500	497.00	4.00	43.001	Private	0.18	0.06	Easement	Ocean Beach & Seaview	In Progress
34 2	500	497.00	4.00	44.000	Private	0.14	0.14	Easement	Ocean Beach & Seaview	In Progress
34 3	500	497.00	4.00	45.000	Private	0.25	0.07	Easement	Ocean Beach & Seaview	In Progress
34 4	502	2.00	4.00	56.000	Private	0.17	0.06	Easement	Ocean Beach & Seaview	In Progress
34 5	502	2.00	4.00	57.000	Public	0.32	0.11	Access Agreement	Ocean Beach & Seaview	In Progress
34 6	500	497.00	4.00	68.000	Private	0.27	0.08	Easement	Ocean Beach & Seaview	In Progress
34 7	500	497.00	4.00	69.000	Private	0.17	0.17	Easement	Ocean Beach & Seaview	In Progress
34 8	500	497.00	4.00	70.000	Private	0.28	0.08	Easement	Ocean Beach & Seaview	In Progress
34 9	500	497.00	4.00	84.000	Private	0.09	0.09	Easement	Ocean Beach & Seaview	In Progress

FIRE ISLAND INLET TO MORICHES INLET STABILIZATION PROJECT										
No.	District	Section	Block	Lot	Owner	Parcel Area (AC)	Acquisition Area (AC)	Estate	Reach	Status
350	500	497.00	5.00	13.000	Public	0.27	0.10	Special Use Permit	Ocean Beach & Seaview	In Progress
351	500	497.00	5.00	14.000	Private	0.23	0.22	Easement	Ocean Beach & Seaview	In Progress
352	500	497.00	5.00	15.000	Private	0.26	0.11	Easement	Ocean Beach & Seaview	In Progress
353	502	2.00	5.00	20.000	Public	0.12	0.04	Access Agreement	Ocean Beach & Seaview	In Progress
354	502	2.00	5.00	21.000	Private	0.13	0.04	Easement	Ocean Beach & Seaview	In Progress
355	502	2.00	5.00	22.000	Public	0.14	0.04	Access Agreement	Ocean Beach & Seaview	In Progress
356	502	2.00	5.00	23.000	Public	0.13	0.03	Access Agreement	Ocean Beach & Seaview	In Progress
357	500	497.00	5.00	43.000	Private	0.31	0.31	Easement	Ocean Beach & Seaview	In Progress
358	500	497.00	5.00	44.002	Private	0.13	0.23	Easement	Ocean Beach & Seaview	In Progress
359	500	497.00	5.00	67.000	Private	0.03	0.00	Easement	Ocean Beach & Seaview	In Progress
360	500	497.00	5.00	68.000	Public	0.08	0.08	Access Agreement	Ocean Beach & Seaview	In Progress
361	200	985.90	1.00	27.001	Private	0.13	0.05	Easement	Ocean Bay Park to POW	In Progress
362	200	985.90	1.00	28.000	Private	0.34	0.13	Easement	Ocean Bay Park to POW	In Progress
363	200	985.80	1.00	28.000	Private	0.19	0.08	Easement	Ocean Bay Park to POW	In Progress
364	200	985.90	1.00	29.000	Private	0.33	0.13	Easement	Ocean Bay Park to POW	In Progress
365	200	985.80	1.00	29.000	Private	0.14	0.06	Easement	Ocean Bay Park to POW	In Progress

FIRE ISLAND INLET TO MORICHES INLET STABILIZATION PROJECT										
No.	District	Section	Block	Lot	Owner	Parcel Area (AC)	Acquisition Area (AC)	Estate	Reach	Status
36 6	200	985.90	1.00	30.000	Private	0.30	0.21	Easement	Ocean Bay Park to POW	In Progress
36 7	200	985.80	1.00	30.000	Private	0.14	0.06	Easement	Ocean Bay Park to POW	In Progress
36 8	200	985.80	1.00	31.000	Private	0.19	0.08	Easement	Ocean Bay Park to POW	In Progress
36 9	200	985.90	1.00	31.000	Private	0.36	0.36	Easement	Ocean Bay Park to POW	In Progress
37 0	200	985.80	1.00	32.000	Private	0.19	0.08	Easement	Ocean Bay Park to POW	In Progress
37 1	200	985.90	1.00	32.000	Private	0.37	0.37	Easement	Ocean Bay Park to POW	In Progress
37 2	200	985.90	1.00	33.000	Private	0.13	0.13	Easement	Ocean Bay Park to POW	In Progress
37 3	200	985.80	1.00	33.000	Private	0.21	0.21	Easement	Ocean Bay Park to POW	In Progress
37 4	200	985.80	1.00	34.000	Private	0.20	0.20	Easement	Ocean Bay Park to POW	In Progress
37 5	200	985.80	1.00	35.000	Private	0.15	0.15	Easement	Ocean Bay Park to POW	In Progress
37 6	200	985.80	1.00	36.000	Private	0.15	0.15	Easement	Ocean Bay Park to POW	In Progress
37 7	200	985.80	1.00	37.000	Private	0.21	0.21	Easement	Ocean Bay Park to POW	In Progress
37 8	200	985.50	2.00	1.000	Public	44080.46	32.76	Access Agreement	Ocean Bay Park to POW	In Progress
37 9	200	985.90	2.00	8.000	Private	0.37	0.12	Easement	Ocean Bay Park to POW	In Progress
38 0	200	985.90	2.00	9.000	Private	1.08	0.49	Easement	Ocean Bay Park to POW	In Progress
38 1	200	985.90	2.00	10.000	Private	0.72	0.12	Easement	Ocean Bay Park to POW	In Progress

FIRE ISLAND INLET TO MORICHES INLET STABILIZATION PROJECT										
No.	District	Section	Block	Lot	Owner	Parcel Area (AC)	Acquisition Area (AC)	Estate	Reach	Status
38 2	200	985.90	2.00	11.000	Private	0.19	0.19	Easement	Ocean Bay Park to POW	In Progress
38 3	200	985.90	2.00	12.000	Private	0.09	0.09	Easement	Ocean Bay Park to POW	In Progress
38 4	200	985.90	2.00	13.000	Private	0.18	0.18	Easement	Ocean Bay Park to POW	In Progress
38 5	200	985.90	2.00	14.000	Private	0.61	0.03	Easement	Ocean Bay Park to POW	In Progress
38 6	200	985.90	2.00	16.002	Private	0.65	0.03	Easement	Ocean Bay Park to POW	In Progress
38 7	200	985.70	2.00	17.000	Private	0.14	0.14	Fee	Ocean Bay Park to POW	In Progress
38 8	200	985.70	2.00	19.001	Private	0.28	0.08	Easement	Ocean Bay Park to POW	In Progress
38 9	200	985.70	2.00	30.001	Private	0.17	0.09	Easement	Ocean Bay Park to POW	In Progress
39 0	200	985.70	2.00	31.000	Private	2.31	2.17	Easement	Ocean Bay Park to POW	In Progress
39 1	200	985.70	2.00	50.000	Public	0.20	0.05	Access Agreement	Ocean Bay Park to POW	In Progress
39 2	200	985.80	3.00	30.000	Private	0.18	0.08	Easement	Ocean Bay Park to POW	In Progress
39 3	200	985.80	3.00	31.000	Private	0.21	0.21	Easement	Ocean Bay Park to POW	In Progress
39 4	200	985.80	3.00	32.000	Private	0.11	0.11	Easement	Ocean Bay Park to POW	In Progress
39 5	200	985.80	3.00	33.000	Private	0.13	0.13	Easement	Ocean Bay Park to POW	In Progress
39 6	200	985.80	3.00	34.000	Private	0.14	0.08	Easement	Ocean Bay Park to POW	In Progress
39 7	200	985.80	3.00	39.000	Private	0.18	0.02	Easement	Ocean Bay Park to POW	In Progress

FIRE ISLAND INLET TO MORICHES INLET STABILIZATION PROJECT										
No.	District	Section	Block	Lot	Owner	Parcel Area (AC)	Acquisition Area (AC)	Estate	Reach	Status
398	200	985.80	3.00	40.000	Private	0.12	0.12	Easement	Ocean Bay Park to POW	In Progress
399	200	985.80	3.00	41.000	Private	0.13	0.13	Easement	Ocean Bay Park to POW	In Progress
400	200	985.80	3.00	42.000	Private	0.17	0.17	Easement	Ocean Bay Park to POW	In Progress
401	200	985.80	3.00	43.000	Private	0.20	0.20	Easement	Ocean Bay Park to POW	In Progress
402	200	985.80	3.00	44.000	Private	0.16	0.09	Easement	Ocean Bay Park to POW	In Progress
403	200	985.70	4.00	39.000	Private	0.11	0.11	Easement	Ocean Bay Park to POW	In Progress
404	200	985.70	4.00	40.000	Private	0.12	0.11	Fee	Ocean Bay Park to POW	In Progress
405	200	985.70	4.00	41.000	Private	0.23	0.23	Fee	Ocean Bay Park to POW	In Progress
406	200	985.70	4.00	42.000	Private	0.17	0.17	Fee	Ocean Bay Park to POW	In Progress
407	200	985.70	4.00	43.000	Private	0.18	0.18	Fee	Ocean Bay Park to POW	In Progress
408	200	985.80	4.00	43.001	Private	0.07	0.00	Easement	Ocean Bay Park to POW	In Progress
409	200	985.70	4.00	44.000	Public	0.06	0.06	Special Use Permit	Ocean Bay Park to POW	In Progress
410	200	985.70	4.00	45.000	Private	0.05	0.05	Easement	Ocean Bay Park to POW	In Progress
411	200	985.80	4.00	47.001	Private	0.41	0.26	Easement	Ocean Bay Park to POW	In Progress
412	200	985.70	4.00	48.001	Private	0.17	0.17	Fee	Ocean Bay Park to POW	In Progress
413	200	985.80	4.00	49.003	Private	0.45	0.28	Easement	Ocean Bay Park to POW	In Progress

FIRE ISLAND INLET TO MORICHES INLET STABILIZATION PROJECT										
No.	District	Section	Block	Lot	Owner	Parcel Area (AC)	Acquisition Area (AC)	Estate	Reach	Status
41 4	200	985.70	4.00	49.003	Private	0.11	0.11	Fee	Ocean Bay Park to POW	In Progress
41 5	200	985.70	4.00	50.000	Private	0.16	0.16	Fee	Ocean Bay Park to POW	In Progress
41 6	200	985.80	4.00	50.003	Private	0.48	0.29	Easement	Ocean Bay Park to POW	In Progress
41 7	200	985.80	4.00	51.003	Private	0.55	0.29	Easement	Ocean Bay Park to POW	In Progress
41 8	200	985.80	4.00	52.001	Private	0.46	0.23	Easement	Ocean Bay Park to POW	In Progress
41 9	200	985.80	4.00	53.001	Private	3.54	1.28	Easement	Ocean Bay Park to POW	In Progress
42 0	200	985.70	5.00	8.001	Private	0.23	0.23	Fee	Ocean Bay Park to POW	In Progress
42 1	200	985.70	5.00	9.000	Public	0.12	0.12	Special Use Permit	Ocean Bay Park to POW	In Progress
42 2	200	985.70	5.00	10.000	Public	0.11	0.11	Access Agreement	Ocean Bay Park to POW	In Progress
42 3	200	985.70	5.00	27.000	Private	0.18	0.18	Fee	Ocean Bay Park to POW	In Progress
42 4	200	985.70	5.00	28.000	Public	0.18	0.18	Access Agreement	Ocean Bay Park to POW	In Progress
42 5	200	985.70	5.00	29.000	Private	0.11	0.11	Fee	Ocean Bay Park to POW	In Progress
42 6	200	985.80	7.00	32.000	Private	0.14	0.05	Easement	Ocean Bay Park to POW	In Progress
42 7	200	985.80	7.00	33.000	Private	0.15	0.15	Easement	Ocean Bay Park to POW	In Progress
42 8	200	985.80	7.00	34.000	Private	0.22	0.22	Easement	Ocean Bay Park to POW	In Progress
42 9	200	985.80	7.00	35.000	Private	0.15	0.04	Easement	Ocean Bay Park to POW	In Progress

FIRE ISLAND INLET TO MORICHES INLET STABILIZATION PROJECT										
No.	District	Section	Block	Lot	Owner	Parcel Area (AC)	Acquisition Area (AC)	Estate	Reach	Status
430	200	985.80	7.00	36.000	Private	0.30	0.08	Easement	Ocean Bay Park to POW	In Progress
431	200	985.80	7.00	37.000	Private	0.22	0.22	Easement	Ocean Bay Park to POW	In Progress
432	200	985.80	7.00	38.000	Private	0.22	0.22	Easement	Ocean Bay Park to POW	In Progress
433	200	985.80	7.00	39.000	Private	0.21	0.21	Easement	Ocean Bay Park to POW	In Progress
434	200	985.80	7.00	40.000	Private	0.27	0.07	Easement	Ocean Bay Park to POW	In Progress
435	200	985.80	7.00	41.000	Private	0.16	0.16	Easement	Ocean Bay Park to POW	In Progress
436	200	985.80	7.00	44.001	Private	0.40	0.50	Easement	Ocean Bay Park to POW	In Progress
437	200	985.80	7.00	45.000	Private	0.16	0.15	Easement	Ocean Bay Park to POW	In Progress
438	200	985.80	7.00	46.000	Private	0.15	0.15	Easement	Ocean Bay Park to POW	In Progress
439	200	985.80	7.00	49.002	Private	0.55	0.45	Easement	Ocean Bay Park to POW	In Progress
440	200	985.70	8.00	8.000	Private	0.22	0.02	Easement	Ocean Bay Park to POW	In Progress
441	200	985.70	8.00	9.000	Public	0.11	0.11	Access Agreement	Ocean Bay Park to POW	In Progress
442	200	985.70	8.00	10.000	Public	0.17	0.16	Special Use Permit	Ocean Bay Park to POW	In Progress
443	200	985.70	8.00	11.000	Public	0.09	0.09	Access Agreement	Ocean Bay Park to POW	In Progress
444	200	985.70	8.00	12.000	Public	0.05	0.05	Special Use Permit	Ocean Bay Park to POW	In Progress
445	200	985.70	8.00	13.000	Private	0.12	0.02	Easement	Ocean Bay Park to POW	In Progress

FIRE ISLAND INLET TO MORICHES INLET STABILIZATION PROJECT										
No.	District	Section	Block	Lot	Owner	Parcel Area (AC)	Acquisition Area (AC)	Estate	Reach	Status
44 6	200	985.70	8.00	27.000	Private	0.15	0.02	Easement	Ocean Bay Park to POW	In Progress
44 7	200	985.70	8.00	28.000	Private	0.12	0.12	Easement	Ocean Bay Park to POW	In Progress
44 8	200	985.70	8.00	29.000	Private	0.11	0.11	Easement	Ocean Bay Park to POW	In Progress
44 9	200	985.70	8.00	30.000	Private	0.23	0.23	Fee	Ocean Bay Park to POW	In Progress
45 0	200	985.70	8.00	31.000	Private	0.16	0.02	Easement	Ocean Bay Park to POW	In Progress
45 1	200	985.70	8.00	41.001	Private	0.13	0.04	Easement	Ocean Bay Park to POW	In Progress
45 2	200	985.70	8.00	42.001	Private	0.14	0.14	Easement	Ocean Bay Park to POW	In Progress
45 3	200	985.70	8.00	43.001	Private	0.14	0.14	Fee	Ocean Bay Park to POW	In Progress
45 4	200	985.70	9.00	10.000	Private	0.11	0.11	Fee	Ocean Bay Park to POW	In Progress
45 5	200	985.70	9.00	11.000	Private	0.06	0.06	Fee	Ocean Bay Park to POW	In Progress
45 6	200	985.70	9.00	12.000	Private	0.17	0.17	Fee	Ocean Bay Park to POW	In Progress
45 7	200	985.70	9.00	13.000	Public	0.11	0.11	Access Agreement	Ocean Bay Park to POW	In Progress
45 8	200	985.70	9.00	27.000	Private	0.14	0.01	Easement	Ocean Bay Park to POW	In Progress
45 9	200	985.70	9.00	28.000	Private	0.06	0.06	Fee	Ocean Bay Park to POW	In Progress
46 0	200	985.70	9.00	29.000	Private	0.12	0.12	Fee	Ocean Bay Park to POW	In Progress
46 1	200	985.70	9.00	30.000	Private	0.12	0.12	Fee	Ocean Bay Park to POW	In Progress

FIRE ISLAND INLET TO MORICHES INLET STABILIZATION PROJECT										
No.	District	Section	Block	Lot	Owner	Parcel Area (AC)	Acquisition Area (AC)	Estate	Reach	Status
46 2	200	985.70	9.00	31.000	Public	0.06	0.06	Special Use Permit	Ocean Bay Park to POW	In Progress
46 3	200	985.70	9.00	32.000	Public	0.11	0.11	Access Agreement	Ocean Bay Park to POW	In Progress
46 4	200	985.70	9.00	33.000	Private	0.15	0.01	Easement	Ocean Bay Park to POW	In Progress
46 5	200	986.00	1.00	1.001	Public	166.68	0.41	Special Use Permit	Sailors Haven/Sunken Forest	In Progress
46 6	200	986.20	1.00	11.000	Private	0.09	0.02	Easement	Cherry Grove	In Progress
46 7	200	986.20	1.00	12.000	Private	0.05	0.01	Easement	Cherry Grove	In Progress
46 8	200	986.20	1.00	13.000	Private	0.05	0.01	Easement	Cherry Grove	In Progress
46 9	200	986.20	1.00	14.000	Private	0.09	0.01	Easement	Cherry Grove	In Progress
47 0	200	986.20	1.00	15.000	Private	0.14	0.02	Easement	Cherry Grove	In Progress
47 1	200	986.20	1.00	28.001	Private	0.04	0.04	Easement	Cherry Grove	In Progress
47 2	200	986.20	1.00	29.000	Private	0.15	0.03	Easement	Cherry Grove	In Progress
47 3	200	985.50	2.00	1.000	Public	44080.46	35.43	Access Agreement	Cherry Grove	In Progress
47 4	200	986.20	2.00	10.000	Private	0.19	0.04	Easement	Cherry Grove	In Progress
47 5	200	986.20	2.00	11.003	Private	0.13	0.03	Easement	Cherry Grove	In Progress
47 6	200	986.20	2.00	12.001	Private	0.14	0.04	Easement	Cherry Grove	In Progress
47 7	200	986.20	2.00	30.001	Private	0.17	0.02	Easement	Cherry Grove	In Progress

FIRE ISLAND INLET TO MORICHES INLET STABILIZATION PROJECT										
No.	District	Section	Block	Lot	Owner	Parcel Area (AC)	Acquisition Area (AC)	Estate	Reach	Status
47 8	200	986.20	3.00	13.001	Private	0.17	0.02	Easement	Cherry Grove	In Progress
47 9	200	986.20	3.00	14.004	Private	0.17	0.05	Easement	Cherry Grove	In Progress
48 0	200	986.20	3.00	39.000	Private	0.22	0.04	Easement	Cherry Grove	In Progress
48 1	200	986.20	3.00	40.000	Private	0.07	0.01	Easement	Cherry Grove	In Progress
48 2	200	986.20	3.00	41.000	Private	0.08	0.01	Easement	Cherry Grove	In Progress
48 3	200	986.20	4.00	11.000	Private	0.12	0.02	Easement	Cherry Grove	In Progress
48 4	200	986.20	4.00	12.000	Private	0.15	0.03	Easement	Cherry Grove	In Progress
48 5	200	986.20	4.00	13.000	Private	0.12	0.02	Easement	Cherry Grove	In Progress
48 6	200	986.20	4.00	30.000	Private	0.09	0.01	Easement	Cherry Grove	In Progress
48 7	200	986.20	4.00	31.000	Private	0.09	0.01	Easement	Cherry Grove	In Progress
48 8	200	986.20	4.00	32.000	Private	0.02	0.00	Easement	Cherry Grove	In Progress
48 9	200	986.20	4.00	33.000	Private	0.12	0.02	Easement	Cherry Grove	In Progress
49 0	200	986.20	4.00	34.000	Private	0.18	0.01	Easement	Cherry Grove	In Progress
49 1	200	986.20	4.00	35.000	Private	0.27	0.01	Easement	Cherry Grove	In Progress
49 2	200	986.20	4.00	36.002	Private	0.25	0.12	Easement	Cherry Grove	In Progress
49 3	200	986.20	5.00	26.002	Private	0.21	0.17	Easement	Cherry Grove	In Progress

FIRE ISLAND INLET TO MORICHES INLET STABILIZATION PROJECT										
No.	District	Section	Block	Lot	Owner	Parcel Area (AC)	Acquisition Area (AC)	Estate	Reach	Status
49 4	200	986.20	6.00	16.003	Private	0.26	0.03	Easement	Cherry Grove	In Progress
49 5	200	986.20	6.00	17.000	Private	0.52	0.19	Easement	Cherry Grove	In Progress
49 6	200	986.20	6.00	22.000	Private	0.21	0.01	Easement	Cherry Grove	In Progress
49 7	200	986.20	6.00	23.000	Private	0.21	0.00	Easement	Cherry Grove	In Progress
49 8	200	986.20	6.00	24.000	Private	0.28	0.00	Easement	Cherry Grove	In Progress
49 9	200	986.20	6.00	29.000	Private	0.18	0.00	Easement	Cherry Grove	In Progress
50 0	200	986.30	1.00	1.000	Public	36.90	2.51	Special Use Permit	Carrington Tract	In Progress
50 1	200	986.20	6.00	15.000	Public	0.65	0.07	Special Use Permit	Carrington Tract	In Progress
50 2	200	985.50	2.00	1.000	Public	44080.46	38.10	Access Agreement	Fire Island Pines	In Progress
50 3	200	986.50	3.00	23.000	Public	0.24	0.16	Special Use Permit	Fire Island Pines	In Progress
50 4	200	986.50	3.00	24.000	Private	0.28	0.07	Easement	Fire Island Pines	In Progress
50 5	200	986.50	3.00	25.000	Private	0.27	0.07	Easement	Fire Island Pines	In Progress
50 6	200	986.50	3.00	26.000	Private	0.24	0.06	Easement	Fire Island Pines	In Progress
50 7	200	986.50	3.00	27.000	Private	0.21	0.03	Easement	Fire Island Pines	In Progress
50 8	200	986.50	3.00	28.000	Private	0.20	0.02	Easement	Fire Island Pines	In Progress
50 9	200	986.50	3.00	29.000	Private	0.19	0.02	Easement	Fire Island Pines	In Progress

FIRE ISLAND INLET TO MORICHES INLET STABILIZATION PROJECT										
No.	District	Section	Block	Lot	Owner	Parcel Area (AC)	Acquisition Area (AC)	Estate	Reach	Status
510	200	986.50	3.00	30.000	Private	0.19	0.03	Easement	Fire Island Pines	In Progress
511	200	986.50	3.00	31.000	Private	0.23	0.05	Easement	Fire Island Pines	In Progress
512	200	986.50	3.00	32.000	Private	0.22	0.08	Easement	Fire Island Pines	In Progress
513	200	986.50	3.00	33.000	Private	0.24	0.09	Easement	Fire Island Pines	In Progress
514	200	986.30	4.00	6.000	Private	0.23	0.07	Easement	Fire Island Pines	In Progress
515	200	986.30	4.00	7.001	Private	0.27	0.04	Easement	Fire Island Pines	In Progress
516	200	986.30	4.00	8.000	Private	0.30	0.07	Easement	Fire Island Pines	In Progress
517	200	986.30	4.00	17.000	Public	0.26	0.05	Special Use Permit	Fire Island Pines	In Progress
518	200	986.30	4.00	18.000	Private	0.27	0.05	Easement	Fire Island Pines	In Progress
519	200	986.50	4.00	40.001	Private	0.31	0.12	Easement	Fire Island Pines	In Progress
520	200	986.50	4.00	41.000	Private	0.19	0.09	Easement	Fire Island Pines	In Progress
521	200	986.50	4.00	42.000	Private	0.19	0.09	Easement	Fire Island Pines	In Progress
522	200	986.50	4.00	43.000	Private	0.20	0.10	Easement	Fire Island Pines	In Progress
523	200	986.50	4.00	44.000	Private	0.20	0.10	Easement	Fire Island Pines	In Progress
524	200	986.50	4.00	45.000	Private	0.20	0.10	Easement	Fire Island Pines	In Progress
525	200	986.50	4.00	46.000	Private	0.20	0.10	Easement	Fire Island Pines	In Progress

FIRE ISLAND INLET TO MORICHES INLET STABILIZATION PROJECT										
No.	District	Section	Block	Lot	Owner	Parcel Area (AC)	Acquisition Area (AC)	Estate	Reach	Status
52 6	200	986.50	4.00	47.000	Private	0.18	0.08	Easement	Fire Island Pines	In Progress
52 7	200	986.50	4.00	48.000	Private	0.18	0.08	Easement	Fire Island Pines	In Progress
52 8	200	986.50	4.00	49.000	Private	0.19	0.08	Easement	Fire Island Pines	In Progress
52 9	200	986.50	4.00	50.000	Private	0.18	0.07	Easement	Fire Island Pines	In Progress
53 0	200	986.50	4.00	51.000	Public	0.18	0.07	Special Use Permit	Fire Island Pines	In Progress
53 1	200	986.50	4.00	52.000	Public	0.18	0.07	Special Use Permit	Fire Island Pines	In Progress
53 2	200	986.50	4.00	53.000	Private	0.18	0.06	Easement	Fire Island Pines	In Progress
53 3	200	986.50	4.00	54.000	Private	0.18	0.07	Easement	Fire Island Pines	In Progress
53 4	200	986.30	5.00	2.000	Public	0.21	0.00	Special Use Permit	Fire Island Pines	In Progress
53 5	200	986.30	5.00	3.000	Private	0.24	0.00	Easement	Fire Island Pines	In Progress
53 6	200	986.40	5.00	6.003	Private	0.30	0.07	Easement	Fire Island Pines	In Progress
53 7	200	986.30	5.00	14.000	Private	0.21	0.00	Easement	Fire Island Pines	In Progress
53 8	200	986.30	5.00	15.000	Private	0.22	0.01	Easement	Fire Island Pines	In Progress
53 9	200	986.30	5.00	16.000	Private	0.24	0.02	Easement	Fire Island Pines	In Progress
54 0	200	986.40	5.00	22.000	Private	0.19	0.08	Easement	Fire Island Pines	In Progress
54 1	200	986.40	5.00	23.000	Private	0.20	0.08	Easement	Fire Island Pines	In Progress

FIRE ISLAND INLET TO MORICHES INLET STABILIZATION PROJECT										
No.	District	Section	Block	Lot	Owner	Parcel Area (AC)	Acquisition Area (AC)	Estate	Reach	Status
54 2	200	986.30	5.00	24.000	Private	0.11	0.02	Easement	Fire Island Pines	In Progress
54 3	200	986.40	5.00	24.000	Private	0.20	0.08	Easement	Fire Island Pines	In Progress
54 4	200	986.40	5.00	25.000	Private	0.21	0.09	Easement	Fire Island Pines	In Progress
54 5	200	986.40	5.00	26.000	Private	0.41	0.17	Easement	Fire Island Pines	In Progress
54 6	200	986.40	5.00	27.000	Private	0.22	0.08	Easement	Fire Island Pines	In Progress
54 7	200	986.30	5.00	27.002	Private	0.55	0.12	Easement	Fire Island Pines	In Progress
54 8	200	986.30	5.00	28.000	Private	0.24	0.02	Easement	Fire Island Pines	In Progress
54 9	200	986.40	5.00	28.000	Private	0.20	0.07	Easement	Fire Island Pines	In Progress
55 0	200	986.40	5.00	29.000	Private	0.15	0.07	Easement	Fire Island Pines	In Progress
55 1	200	986.40	5.00	30.000	Private	0.15	0.07	Easement	Fire Island Pines	In Progress
55 2	200	986.40	5.00	31.000	Private	0.15	0.07	Easement	Fire Island Pines	In Progress
55 3	200	986.40	5.00	32.000	Private	0.15	0.07	Easement	Fire Island Pines	In Progress
55 4	200	986.40	5.00	33.000	Private	0.15	0.06	Easement	Fire Island Pines	In Progress
55 5	200	986.40	5.00	34.000	Private	0.15	0.06	Easement	Fire Island Pines	In Progress
55 6	200	986.40	5.00	35.000	Private	0.16	0.06	Easement	Fire Island Pines	In Progress
55 7	200	986.40	6.00	63.000	Private	0.18	0.06	Easement	Fire Island Pines	In Progress

FIRE ISLAND INLET TO MORICHES INLET STABILIZATION PROJECT										
No.	District	Section	Block	Lot	Owner	Parcel Area (AC)	Acquisition Area (AC)	Estate	Reach	Status
558	200	986.40	6.00	64.000	Private	0.16	0.06	Easement	Fire Island Pines	In Progress
559	200	986.40	6.00	65.000	Private	0.17	0.07	Easement	Fire Island Pines	In Progress
560	200	986.40	6.00	66.000	Private	0.18	0.07	Easement	Fire Island Pines	In Progress
561	200	986.40	6.00	68.001	Private	0.18	0.15	Easement	Fire Island Pines	In Progress
562	200	986.40	6.00	70.001	Private	0.26	0.11	Easement	Fire Island Pines	In Progress
563	200	986.40	6.00	71.000	Private	0.23	0.07	Easement	Fire Island Pines	In Progress
564	200	986.40	6.00	72.000	Private	0.21	0.10	Easement	Fire Island Pines	In Progress
565	200	986.40	6.00	73.000	Private	0.22	0.10	Easement	Fire Island Pines	In Progress
566	200	986.40	7.00	29.000	Private	0.60	0.17	Easement	Fire Island Pines	In Progress
567	200	986.40	7.00	30.000	Public	0.16	0.03	Special Use Permit	Fire Island Pines	In Progress
568	200	986.40	7.00	31.000	Private	0.16	0.03	Easement	Fire Island Pines	In Progress
569	200	986.40	7.00	32.000	Private	0.19	0.03	Easement	Fire Island Pines	In Progress
570	200	986.40	7.00	33.000	Private	0.16	0.03	Easement	Fire Island Pines	In Progress
571	200	986.40	7.00	34.000	Private	0.15	0.03	Easement	Fire Island Pines	In Progress
572	200	986.40	7.00	35.000	Private	0.15	0.03	Easement	Fire Island Pines	In Progress
573	200	986.40	7.00	36.000	Private	0.14	0.04	Easement	Fire Island Pines	In Progress

FIRE ISLAND INLET TO MORICHES INLET STABILIZATION PROJECT										
No.	District	Section	Block	Lot	Owner	Parcel Area (AC)	Acquisition Area (AC)	Estate	Reach	Status
57 4	200	986.40	7.00	37.000	Private	0.14	0.04	Easement	Fire Island Pines	In Progress
57 5	200	986.40	8.00	29.000	Private	0.23	0.06	Easement	Fire Island Pines	In Progress
57 6	200	986.40	8.00	30.000	Private	0.14	0.03	Easement	Fire Island Pines	In Progress
57 7	200	986.40	8.00	31.000	Private	0.15	0.03	Easement	Fire Island Pines	In Progress
57 8	200	986.40	8.00	32.000	Private	0.16	0.03	Easement	Fire Island Pines	In Progress
57 9	200	986.40	8.00	33.000	Private	0.16	0.03	Easement	Fire Island Pines	In Progress
58 0	200	986.40	8.00	34.000	Private	0.16	0.03	Easement	Fire Island Pines	In Progress
58 1	200	986.40	8.00	36.001	Private	0.33	0.06	Easement	Fire Island Pines	In Progress
58 2	200	986.40	8.00	37.000	Private	0.17	0.03	Easement	Fire Island Pines	In Progress
58 3	200	986.40	8.00	38.000	Private	0.24	0.04	Easement	Fire Island Pines	In Progress
58 4	200	986.60	1.00	1.000	Public	58.89	0.07	Special Use Permit	Talisman / Barret Beach	In Progress
58 5	200	986.70	1.00	12.000	Public	3.64	0.57	Special Use Permit	Talisman / Barret Beach	In Progress
58 6	200	986.80	1.00	2.000	Private	1.94	0.44	Easement	Water Island	In Progress
58 7	200	986.80	1.00	3.000	Private	1.95	0.33	Easement	Water Island	In Progress
58 8	200	986.70	1.00	14.002	Private	0.47	0.29	Easement	Water Island	In Progress
58 9	200	986.70	1.00	15.000	Private	0.72	0.44	Easement	Water Island	In Progress

FIRE ISLAND INLET TO MORICHES INLET STABILIZATION PROJECT										
No.	District	Section	Block	Lot	Owner	Parcel Area (AC)	Acquisition Area (AC)	Estate	Reach	Status
590	200	986.70	1.00	17.000	Public	0.89	0.31	Special Use Permit	Water Island	In Progress
591	200	986.70	1.00	23.000	Public	0.97	0.68	Special Use Permit	Water Island	In Progress
592	200	985.50	2.00	1.000	Public	44080.46	13.96	Access Agreement	Water Island	In Progress
593	200	986.70	2.00	8.000	Public	6.00	1.31	Special Use Permit	Water Island	In Progress
594	200	986.70	2.00	15.000	Public	0.11	0.11	Special Use Permit	Water Island	In Progress
595	200	986.70	2.00	16.001	Private	0.00	0.17	Easement	Water Island	In Progress
596	200	986.70	2.00	17.000	Public	0.11	0.11	Special Use Permit	Water Island	In Progress
597	200	986.70	2.00	18.000	Private	0.11	0.05	Easement	Water Island	In Progress
598	200	986.70	2.00	31.000	Private	0.17	0.05	Easement	Water Island	In Progress
599	200	986.70	2.00	32.000	Public	0.22	0.22	Special Use Permit	Water Island	In Progress
600	200	986.70	2.00	33.000	Public	0.11	0.11	Special Use Permit	Water Island	In Progress
601	200	986.70	2.00	35.000	Private	0.11	0.11	Easement	Water Island	In Progress
602	200	986.70	2.00	36.005	Private	0.24	0.16	Easement	Water Island	In Progress
603	200	986.70	2.00	49.000	Public	0.11	0.11	Access Agreement	Water Island	In Progress
604	200	986.70	2.00	50.001	Private	0.34	0.16	Easement	Water Island	In Progress
605	200	986.70	2.00	51.000	Private	0.22	0.22	Easement	Water Island	In Progress

FIRE ISLAND INLET TO MORICHES INLET STABILIZATION PROJECT										
No.	District	Section	Block	Lot	Owner	Parcel Area (AC)	Acquisition Area (AC)	Estate	Reach	Status
606	200	986.70	2.00	52.000	Private	0.62	0.05	Easement	Water Island	In Progress
607	200	986.70	2.00	60.000	Private	0.11	0.06	Easement	Water Island	In Progress
608	200	986.70	2.00	61.000	Public	0.11	0.11	Access Agreement	Water Island	In Progress
609	200	986.70	2.00	62.000	Public	0.11	0.11	Special Use Permit	Water Island	In Progress
610	200	986.90	1.00	1.000	Public	34.71	1.41	Special Use Permit	Blue Point Beach	In Progress
611	200	986.80	1.00	4.000	Public	24.90	0.96	Special Use Permit	Blue Point Beach	In Progress
612	200	985.50	2.00	1.000	Public	44080.46	11.92	Access Agreement	Blue Point Beach	In Progress
613	200	985.50	2.00	1.000	Public	44080.46	18.43	Access Agreement	Davis Park	In Progress
614	200	986.90	2.00	5.000	Private	0.28	0.12	Fee	Davis Park	In Progress
615	200	987.00	2.00	5.000	Private	0.17	0.12	Easement	Davis Park	In Progress
616	200	986.90	2.00	6.000	Private	0.27	0.12	Fee	Davis Park	In Progress
617	200	987.00	2.00	6.000	Private	0.17	0.12	Easement	Davis Park	In Progress
618	200	987.00	2.00	7.000	Private	0.16	0.12	Easement	Davis Park	In Progress
619	200	987.00	2.00	15.000	Private	0.24	0.16	Easement	Davis Park	In Progress
620	200	987.00	2.00	16.000	Private	0.20	0.13	Easement	Davis Park	In Progress
621	200	986.90	2.00	17.001	Private	0.22	0.09	Fee	Davis Park	In Progress

FIRE ISLAND INLET TO MORICHES INLET STABILIZATION PROJECT										
No.	District	Section	Block	Lot	Owner	Parcel Area (AC)	Acquisition Area (AC)	Estate	Reach	Status
62 2	200	987.00	2.00	23.000	Private	0.17	0.12	Fee	Davis Park	In Progress
62 3	200	987.00	2.00	24.000	Private	0.18	0.13	Easement	Davis Park	In Progress
62 4	200	986.90	2.00	28.000	Private	0.16	0.09	Fee	Davis Park	In Progress
62 5	200	986.90	2.00	29.000	Private	0.17	0.10	Fee	Davis Park	In Progress
62 6	200	987.00	2.00	31.000	Private	0.38	0.34	Fee	Davis Park	In Progress
62 7	200	987.00	2.00	32.000	Private	0.20	0.13	Fee	Davis Park	In Progress
62 8	200	987.00	2.00	39.000	Private	0.18	0.12	Fee	Davis Park	In Progress
62 9	200	986.90	2.00	40.000	Private	0.17	0.10	Fee	Davis Park	In Progress
63 0	200	987.00	2.00	40.000	Private	0.17	0.13	Fee	Davis Park	In Progress
63 1	200	986.90	2.00	41.000	Private	0.16	0.10	Fee	Davis Park	In Progress
63 2	200	987.00	2.00	47.000	Private	0.15	0.12	Fee	Davis Park	In Progress
63 3	200	987.00	2.00	49.001	Public	1.77	0.55	Access Agreement	Davis Park	In Progress
63 4	200	987.00	2.00	51.000	Public	1.52	0.57	Access Agreement	Davis Park	In Progress
63 5	200	986.90	2.00	52.000	Private	0.16	0.09	Fee	Davis Park	In Progress
63 6	200	987.00	2.00	53.000	Private	0.60	0.26	Easement	Davis Park	In Progress
63 7	200	986.90	2.00	53.000	Private	0.18	0.10	Fee	Davis Park	In Progress

FIRE ISLAND INLET TO MORICHES INLET STABILIZATION PROJECT										
No.	District	Section	Block	Lot	Owner	Parcel Area (AC)	Acquisition Area (AC)	Estate	Reach	Status
63 8	200	987.00	2.00	54.002	Private	0.39	0.27	Easement	Davis Park	In Progress
63 9	200	987.00	2.00	55.002	Public	0.39	0.22	Special Use Permit	Davis Park	In Progress
64 0	200	987.00	2.00	56.001	Private	0.73	0.26	Easement	Davis Park	In Progress
64 1	200	986.90	2.00	64.000	Private	0.11	0.08	Fee	Davis Park	In Progress
64 2	200	986.90	2.00	66.000	Private	0.16	0.09	Fee	Davis Park	In Progress
64 3	200	987.00	5.00	15.000	Private	0.57	0.24	Easement	Davis Park	In Progress
64 4	200	987.00	5.00	16.000	Private	0.42	0.19	Easement	Davis Park	In Progress
64 5	200	987.00	5.00	17.000	Private	0.56	0.25	Easement	Davis Park	In Progress
64 6	200	987.00	5.00	18.000	Private	0.54	0.25	Easement	Davis Park	In Progress
64 7	200	987.00	5.00	19.000	Private	0.55	0.27	Easement	Davis Park	In Progress
64 8	200	987.00	5.00	20.000	Private	0.48	0.24	Easement	Davis Park	In Progress
64 9	200	987.00	6.00	3.000	Private	0.47	0.15	Easement	Davis Park	In Progress
65 0	200	987.00	6.00	4.000	Private	0.49	0.17	Easement	Davis Park	In Progress
65 1	200	987.00	6.00	5.000	Private	0.48	0.17	Easement	Davis Park	In Progress
65 2	200	987.00	6.00	6.000	Private	0.50	0.18	Easement	Davis Park	In Progress
65 3	200	987.00	6.00	7.000	Private	0.48	0.18	Easement	Davis Park	In Progress

FIRE ISLAND INLET TO MORICHES INLET STABILIZATION PROJECT										
No.	District	Section	Block	Lot	Owner	Parcel Area (AC)	Acquisition Area (AC)	Estate	Reach	Status
65 4	200	987.00	6.00	8.000	Private	0.49	0.19	Easement	Davis Park	In Progress
65 5	200	987.00	6.00	9.000	Private	0.49	0.20	Easement	Davis Park	In Progress
65 6	200	987.10	1.00	1.000	Public	27.91	2.29	Special Use Permit	Watch Hill	In Progress
65 7	200	987.80	1.00	2.000	Public	278.57	4.73	Special Use Permit	Old Inlet	In Progress
65 8	200	985.50	2.00	1.000	Public	44080.46	3.92	Access Agreement	Old Inlet	In Progress
65 9	200	987.90	1.00	2.000	Public	4.25	1.96	Access Agreement	Smith Point - West	In Progress
66 0	200	985.50	2.00	1.000	Public	44080.46	3.86	Access Agreement	Smith Point - West	In Progress
66 1	200	988.10	1.00	1.000	Public	411.97	92.71	Access Agreement	Smith Point - East	In Progress
66 2	200	985.50	2.00	1.000	Public	44080.46	16.50	Access Agreement	Smith Point - East	In Progress
66 3	200	988.30	1.00	1.001	Public	423.02	18.71	Access Agreement	Great Gun	In Progress
66 4	200	985.50	2.00	1.000	Public	44080.46	4.99	Access Agreement	Great Gun	In Progress

WESTHAMPTON										
No.	District	Section	Block	Lot	Owner	Parcel Area (AC)	Easement Area (AC)	Estate	Reach	Status
1	907	200.00	300.00	6001.000	Private	0.21	0.10	Easement	Pikes	Acquired
2	907	200.00	300.00	1001.000	Private	0.34	0.16	Easement	Pikes	Acquired

WESTHAMPTON										
No.	District	Section	Block	Lot	Owner	Parcel Area (AC)	Easement Area (AC)	Estate	Reach	Status
3	200	98870.00	100.00	1000.000	Public	218.51	0.83	Access Agreement	Pikes	Acquired
4	907	400.00	200.00	4001.000	Private	0.26	0.12	Easement	Pikes	Acquired
5	907	200.00	300.00	30001.000	Public	0.02	0.01	Access Agreement	Pikes	Acquired
6	907	200.00	300.00	2001.000	Private	0.03	0.01	Easement	Pikes	Acquired
7	907	200.00	300.00	32001.000	Private	0.28	0.12	Easement	Pikes	Acquired
8	907	200.00	300.00	27001.000	Private	0.18	0.08	Easement	Pikes	Acquired
9	907	200.00	300.00	23001.000	Private	0.06	0.03	Easement	Pikes	Acquired
10	907	200.00	300.00	4001.000	Private	0.28	0.13	Easement	Pikes	Acquired
11	907	200.00	300.00	5001.000	Private	0.26	0.12	Easement	Pikes	Acquired
12	907	200.00	300.00	31001.000	Private	0.33	0.14	Easement	Pikes	Acquired
13	907	200.00	300.00	18001.000	Private	0.02	0.01	Easement	Pikes	Acquired
14	907	200.00	300.00	11001.000	Private	0.39	0.17	Easement	Pikes	Acquired
15	907	200.00	300.00	14001.000	Private	0.25	0.11	Easement	Pikes	Acquired
16	907	200.00	300.00	28001.000	Private	0.26	0.11	Easement	Pikes	Acquired
17	907	200.00	300.00	29001.000	Private	0.18	0.08	Easement	Pikes	Acquired
18	907	200.00	300.00	20001.000	Private	0.32	0.14	Easement	Pikes	Acquired
19	907	200.00	300.00	7001.000	Private	0.22	0.10	Easement	Pikes	Acquired
20	907	200.00	300.00	10001.000	Private	0.39	0.18	Easement	Pikes	Acquired

WESTHAMPTON										
No.	District	Section	Block	Lot	Owner	Parcel Area (AC)	Easement Area (AC)	Estate	Reach	Status
21	907	200.00	300.00	57001.00 0	Private	0.22	0.10	Easement	Pikes	Acquired
22	907	200.00	300.00	25001.00 0	Private	0.21	0.09	Easement	Pikes	Acquired
23	907	200.00	300.00	24001.00 0	Private	0.18	0.08	Easement	Pikes	Acquired
24	907	200.00	300.00	17001.00 0	Private	0.27	0.12	Easement	Pikes	Acquired
25	907	200.00	300.00	33001.00 0	Private	0.04	0.02	Easement	Pikes	Acquired
26	907	200.00	300.00	3001.000	Private	0.33	0.15	Easement	Pikes	Acquired
27	907	200.00	300.00	9001.000	Private	0.43	0.20	Easement	Pikes	Acquired
28	907	200.00	300.00	15001.00 0	Private	0.34	0.15	Easement	Pikes	Acquired
29	907	200.00	300.00	22001.00 0	Private	0.33	0.15	Easement	Pikes	Acquired
30	907	200.00	300.00	8001.000	Public	0.43	0.20	Access Agreement	Pikes	Acquired
31	907	200.00	300.00	52001.00 0	Private	0.18	0.08	Easement	Pikes	Acquired
32	907	200.00	300.00	16001.00 0	Private	0.26	0.12	Easement	Pikes	Acquired
33	907	200.00	300.00	26001.00 0	Private	0.34	0.15	Easement	Pikes	Acquired
34	907	200.00	300.00	13001.00 0	Private	0.21	0.10	Easement	Pikes	Acquired
35	907	200.00	300.00	19001.00 0	Private	0.03	0.01	Easement	Pikes	Acquired
36	907	200.00	300.00	48001.00 0	Public	0.09	0.04	Access Agreement	Pikes	Acquired
37	907	200.00	300.00	44001.00 0	Private	0.17	0.08	Easement	Pikes	Acquired

WESTHAMPTON										
No.	District	Section	Block	Lot	Owner	Parcel Area (AC)	Easement Area (AC)	Estate	Reach	Status
38	907	200.00	300.00	54001.00 0	Private	0.36	0.17	Easement	Pikes	Acquired
39	907	200.00	300.00	41001.00 0	Private	0.19	0.09	Easement	Pikes	Acquired
40	907	200.00	300.00	56001.00 0	Private	0.22	0.10	Easement	Pikes	Acquired
41	907	200.00	300.00	35001.00 0	Private	0.18	0.08	Easement	Pikes	Acquired
42	907	200.00	300.00	49001.00 0	Private	0.17	0.08	Easement	Pikes	Acquired
43	907	200.00	300.00	40001.00 0	Private	0.17	0.08	Easement	Pikes	Acquired
44	907	200.00	300.00	36001.00 0	Private	0.20	0.09	Easement	Pikes	Acquired
45	907	200.00	300.00	53001.00 0	Private	0.17	0.08	Easement	Pikes	Acquired
46	907	200.00	300.00	47001.00 0	Private	0.22	0.10	Easement	Pikes	Acquired
47	907	200.00	300.00	43001.00 0	Private	0.40	0.18	Easement	Pikes	Acquired
48	907	200.00	300.00	37001.00 0	Private	0.20	0.09	Easement	Pikes	Acquired
49	907	200.00	300.00	46001.00 0	Private	0.17	0.08	Easement	Pikes	Acquired
50	907	200.00	300.00	51001.00 0	Private	0.35	0.16	Easement	Pikes	Acquired
51	907	200.00	300.00	50001.00 0	Private	0.34	0.16	Easement	Pikes	Acquired
52	907	200.00	300.00	55001.00 0	Private	0.64	0.30	Easement	Pikes	Acquired
53	907	200.00	300.00	45001.00 0	Private	0.16	0.07	Easement	Pikes	Acquired

WESTHAMPTON										
No.	District	Section	Block	Lot	Owner	Parcel Area (AC)	Easement Area (AC)	Estate	Reach	Status
54	907	400.00	200.00	2001.000	Private	0.37	0.17	Easement	Pikes	Acquired
55	907	200.00	300.00	21001.000	Private	0.31	0.14	Easement	Pikes	Acquired
56	907	200.00	300.00	34001.000	Private	0.17	0.07	Easement	Pikes	Acquired
57	907	200.00	300.00	38001.000	Private	0.17	0.08	Easement	Pikes	Acquired
58	907	400.00	200.00	9001.000	Private	0.21	0.10	Easement	Pikes	Acquired
59	907	400.00	200.00	1001.000	Private	0.24	0.11	Easement	Pikes	Acquired
60	907	200.00	300.00	42001.000	Private	0.35	0.16	Easement	Pikes	Acquired
61	907	400.00	200.00	3001.000	Private	0.31	0.14	Easement	Pikes	Acquired
62	907	400.00	200.00	5001.000	Private	0.34	0.16	Easement	Pikes	Acquired
63	907	400.00	200.00	8001.000	Private	0.22	0.10	Easement	Pikes	Acquired
64	907	400.00	200.00	10001.000	Private	0.42	0.18	Easement	Pikes	Acquired
65	907	400.00	200.00	15001.000	Private	0.34	0.09	Easement	Pikes	New
66	907	400.00	200.00	11001.000	Private	0.35	0.13	Easement	Pikes	Acquired
67	907	400.00	200.00	12001.000	Private	0.43	0.15	Easement	Pikes	Acquired
68	907	400.00	200.00	13001.000	Public	0.03	0.01	Access Agreement	Pikes	Acquired
69	907	100.00	200.00	3003.000	Private	0.28	0.14	Easement	Pikes	Acquired
70	907	100.00	200.00	22001.000	Private	0.18	0.08	Easement	Pikes	Acquired
71	907	100.00	200.00	34001.000	Private	0.32	0.15	Easement	Pikes	Acquired
72	907	100.00	200.00	15001.000	Private	0.33	0.15	Easement	Pikes	Acquired

WESTHAMPTON										
No.	District	Section	Block	Lot	Owner	Parcel Area (AC)	Easement Area (AC)	Estate	Reach	Status
73	907	100.00	200.00	21001.00 0	Private	0.04	0.02	Easement	Pikes	Acquired
74	907	100.00	200.00	28001.00 0	Private	0.28	0.13	Easement	Pikes	Acquired
75	907	100.00	200.00	1003.000	Private	0.28	0.14	Easement	Pikes	Acquired
76	907	100.00	200.00	10001.00 0	Private	0.02	0.01	Easement	Pikes	Acquired
77	907	100.00	200.00	16001.00 0	Private	0.34	0.15	Easement	Pikes	Acquired
78	907	100.00	200.00	23001.00 0	Private	0.09	0.04	Easement	Pikes	Acquired
79	907	100.00	200.00	29001.00 0	Private	0.20	0.09	Easement	Pikes	Acquired
80	907	100.00	200.00	30001.00 0	Private	0.20	0.09	Easement	Pikes	Acquired
81	907	100.00	200.00	35001.00 0	Private	0.32	0.15	Easement	Pikes	Acquired
82	907	100.00	200.00	4003.000	Private	0.28	0.14	Easement	Pikes	Acquired
83	907	100.00	200.00	17001.00 0	Private	0.41	0.18	Easement	Pikes	Acquired
84	907	100.00	200.00	11001.00 0	Private	0.34	0.15	Easement	Pikes	Acquired
85	907	100.00	200.00	31001.00 0	Private	0.17	0.08	Easement	Pikes	Acquired
86	907	100.00	200.00	36001.00 0	Private	0.35	0.16	Easement	Pikes	Acquired
87	907	100.00	200.00	25001.00 0	Private	0.34	0.15	Easement	Pikes	Acquired
88	907	100.00	200.00	12001.00 0	Private	0.26	0.12	Easement	Pikes	Acquired
89	907	100.00	200.00	18001.00 0	Private	0.35	0.15	Easement	Pikes	Acquired

WESTHAMPTON										
No.	District	Section	Block	Lot	Owner	Parcel Area (AC)	Easement Area (AC)	Estate	Reach	Status
90	907	100.00	200.00	5001.000	Private	0.35	0.20	Easement	Pikes	Acquired
91	907	100.00	200.00	4004.000	Private	0.28	0.14	Easement	Pikes	Acquired
92	907	100.00	200.00	14001.00 0	Private	0.17	0.08	Easement	Pikes	Acquired
93	907	100.00	200.00	32001.00 0	Public	0.62	0.27	Access Agreement	Pikes	Acquired
94	907	100.00	200.00	27002.00 0	Private	0.35	0.15	Easement	Pikes	Acquired
95	907	100.00	200.00	2004.000	Private	0.28	0.14	Easement	Pikes	Acquired
96	907	100.00	200.00	19001.00 0	Private	0.28	0.12	Easement	Pikes	Acquired
97	907	300.00	200.00	3002.000	Private	0.43	0.20	Easement	Pikes	Acquired
98	907	300.00	200.00	20001.00 0	Private	0.26	0.11	Easement	Pikes	Acquired
99	907	300.00	200.00	36001.00 0	Private	0.31	0.14	Easement	Pikes	Acquired
100	907	300.00	200.00	32001.00 0	Private	0.28	0.13	Easement	Pikes	Acquired
101	907	300.00	200.00	12001.00 0	Private	0.31	0.14	Easement	Pikes	Acquired
102	907	300.00	200.00	13001.00 0	Private	0.05	0.02	Easement	Pikes	Acquired
103	907	300.00	200.00	37001.00 0	Private	0.32	0.15	Easement	Pikes	Acquired
104	907	300.00	200.00	21001.00 0	Private	0.23	0.10	Easement	Pikes	Acquired
105	907	300.00	200.00	4001.000	Private	0.22	0.10	Easement	Pikes	Acquired
106	907	300.00	200.00	27001.00 0	Private	0.20	0.09	Easement	Pikes	Acquired
107	907	300.00	200.00	15001.00 0	Public	0.03	0.01	Access Agreement	Pikes	Acquired

WESTHAMPTON										
No.	District	Section	Block	Lot	Owner	Parcel Area (AC)	Easement Area (AC)	Estate	Reach	Status
108	907	300.00	200.00	22001.00 0	Private	0.26	0.11	Easement	Pikes	Acquired
109	907	300.00	200.00	14001.00 0	Private	0.26	0.11	Easement	Pikes	Acquired
110	907	300.00	200.00	33001.00 0	Private	0.27	0.12	Easement	Pikes	Acquired
111	907	300.00	200.00	28001.00 0	Private	0.34	0.15	Easement	Pikes	Acquired
112	907	300.00	200.00	34001.00 0	Private	0.28	0.13	Easement	Pikes	Acquired
113	907	300.00	200.00	6001.000	Private	0.33	0.15	Easement	Pikes	Acquired
114	907	300.00	200.00	1001.000	Public	1.72	0.80	Access Agreement	Pikes	Acquired
115	907	300.00	200.00	7001.000	Private	0.32	0.14	Easement	Pikes	Acquired
116	907	300.00	200.00	17001.00 0	Private	0.22	0.09	Easement	Pikes	Acquired
117	907	300.00	200.00	10005.00 0	Private	0.50	0.23	Easement	Pikes	Acquired
118	907	300.00	200.00	35001.00 0	Private	0.31	0.14	Easement	Pikes	Acquired
119	907	300.00	200.00	23001.00 0	Private	0.32	0.14	Easement	Pikes	Acquired
120	907	300.00	200.00	11001.00 0	Private	0.32	0.14	Easement	Pikes	Acquired
121	907	300.00	200.00	29001.00 0	Private	0.34	0.15	Easement	Pikes	Acquired
122	907	300.00	200.00	8001.000	Private	0.43	0.19	Easement	Pikes	Acquired
123	907	300.00	200.00	24001.00 0	Private	0.24	0.10	Easement	Pikes	Acquired
124	907	300.00	200.00	19001.00 0	Private	0.27	0.11	Easement	Pikes	Acquired

WESTHAMPTON										
No.	District	Section	Block	Lot	Owner	Parcel Area (AC)	Easement Area (AC)	Estate	Reach	Status
125	907	300.00	200.00	30001.000	Private	0.34	0.15	Easement	Pikes	Acquired
126	907	100.00	200.00	2003.000	Private	0.28	0.14	Easement	Pikes	Acquired
127	907	100.00	200.00	8001.000	Private	0.04	0.02	Easement	Pikes	Acquired
128	907	100.00	200.00	9001.000	Private	0.02	0.01	Easement	Pikes	Acquired
129	907	200.00	300.00	39001.000	Private	0.17	0.08	Easement	Pikes	Acquired
130	907	400.00	200.00	7001.000	Private	0.26	0.12	Easement	Pikes	Acquired
131	907	400.00	200.00	6001.000	Private	0.26	0.12	Easement	Pikes	Acquired
132	907	200.00	300.00	12001.000	Private	0.30	0.14	Easement	Pikes	Acquired
133	907	400.00	200.00	14001.000	Private	0.35	0.10	Easement	Pikes	Acquired
134	907	100.00	200.00	33001.000	Private	0.22	0.10	Easement	Pikes	Acquired
135	907	100.00	200.00	3004.000	Private	0.28	0.14	Easement	Pikes	Acquired
136	907	300.00	200.00	16001.000	Private	0.28	0.12	Easement	Pikes	Acquired
137	907	100.00	200.00	24001.000	Private	0.44	0.19	Easement	Pikes	Acquired
138	907	100.00	200.00	6001.000	Private	0.41	0.18	Easement	Pikes	Acquired
139	907	100.00	200.00	1004.000	Private	0.28	0.14	Easement	Pikes	Acquired
140	907	100.00	200.00	13001.000	Private	0.17	0.08	Easement	Pikes	Acquired
141	907	300.00	200.00	26001.000	Private	0.29	0.12	Easement	Pikes	Acquired
142	907	300.00	200.00	18001.000	Private	0.32	0.13	Easement	Pikes	Acquired
143	907	300.00	200.00	25001.000	Private	0.26	0.11	Easement	Pikes	Acquired

WESTHAMPTON										
No.	District	Section	Block	Lot	Owner	Parcel Area (AC)	Easement Area (AC)	Estate	Reach	Status
144	907	300.00	200.00	5001.000	Private	0.21	0.10	Easement	Pikes	Acquired
145	907	100.00	200.00	7001.000	Private	0.27	0.12	Easement	Pikes	Acquired
146	907	300.00	200.00	31001.000	Public	0.02	0.01	Access Agreement	Pikes	Acquired
147	907	100.00	200.00	20001.000	Private	0.30	0.13	Easement	Pikes	Acquired
148	907	300.00	200.00	10004.000	Private	0.51	0.23	Easement	Pikes	Acquired
149	907	300.00	200.00	38000.000	Public	7.14	7.01	Access Agreement	Pikes	Acquired
150	907	200.00	300.00	58000.000	Public	12.78	11.86	Access Agreement	Pikes	Acquired
151	907	400.00	200.00	18000.000	Public	0.18	0.18	Access Agreement	Pikes	Acquired
152	907	400.00	200.00	19000.000	Public	2.66	2.66	Access Agreement	Pikes	Acquired
153	907	100.00	200.00	37000.000	Public	13.74	10.50	Access Agreement	Pikes	Acquired
154	200	98550.00	200.00	1000.000	Public	44080.46	0.48	Access Agreement	Pikes	Acquired
155	900	39100.00	200.00	18000.000	Private	0.34	0.15	Easement	Westhampton	New
156	900	39100.00	200.00	19000.000	Private	0.47	0.21	Easement	Westhampton	New
157	900	39100.00	200.00	25002.000	Public	0.10	0.10	Access Agreement	Westhampton	New
158	900	39100.00	200.00	26002.000	Public	0.09	0.09	Access Agreement	Westhampton	New
159	907	400.00	200.00	16000.000	Private	0.63	0.35	Easement	Westhampton	New
160	907	400.00	200.00	17000.000	Private	0.46	0.21	Easement	Westhampton	New

WESTHAMPTON										
No.	District	Section	Block	Lot	Owner	Parcel Area (AC)	Easement Area (AC)	Estate	Reach	Status
161	900	39100.00	200.00	20000.00 0	Private	0.35	0.16	Easement	Westhampton	New
162	900	39100.00	200.00	21000.00 0	Private	0.46	0.20	Easement	Westhampton	New
163	900	39100.00	200.00	22000.00 0	Public	0.46	0.20	Access Agreement	Westhampton	New
164	900	39100.00	200.00	23000.00 0	Public	0.04	0.02	Access Agreement	Westhampton	New
165	900	39100.00	200.00	24000.00 0	Private	0.34	0.14	Easement	Westhampton	New
166	900	39100.00	200.00	25001.00 0	Private	0.52	0.29	Easement	Westhampton	New
167	900	39100.00	200.00	26001.00 0	Private	0.52	0.28	Easement	Westhampton	New
168	900	39100.00	200.00	27000.00 0	Private	0.47	0.20	Easement	Westhampton	New
169	900	39100.00	200.00	30000.00 0	Private	0.31	0.14	Easement	Westhampton	New
170	900	39100.00	200.00	31000.00 0	Private	0.32	0.14	Easement	Westhampton	New
171	900	39100.00	200.00	32000.00 0	Private	0.29	0.10	Easement	Westhampton	New
172	900	39100.00	200.00	33000.00 0	Private	0.28	0.10	Easement	Westhampton	New
173	900	39100.00	200.00	28000.00 0	Private	0.60	0.26	Easement	Westhampton	New
174	900	39100.00	200.00	45001.00 0	Public	0.30	0.30	Access Agreement	Westhampton	New
175	900	39100.00	200.00	29000.00 0	Private	0.65	0.35	Easement	Westhampton	New
176	900	39100.00	200.00	43000.00 0	Private	0.08	0.04	Easement	Westhampton	New

WESTHAMPTON										
No.	District	Section	Block	Lot	Owner	Parcel Area (AC)	Easement Area (AC)	Estate	Reach	Status
177	900	39100.00	200.00	34000.00 0	Private	0.41	0.17	Easement	Westhampton	New
178	900	39100.00	200.00	36001.00 0	Private	0.43	0.18	Easement	Westhampton	New
179	900	39100.00	200.00	35001.00 0	Private	0.44	0.19	Easement	Westhampton	New
180	900	39100.00	200.00	37001.00 0	Public	0.03	0.01	Access Agreement	Westhampton	New
181	900	39100.00	200.00	39001.00 0	Private	0.73	0.33	Easement	Westhampton	New
182	900	39100.00	200.00	40001.00 0	Private	0.69	0.28	Easement	Westhampton	New
183	900	39100.00	200.00	41000.00 0	Private	0.85	0.44	Easement	Westhampton	New
184	900	39200.00	200.00	1001.000	Private	1.81	1.04	Easement	Westhampton	New
185	900	39200.00	200.00	1002.000	Private	1.69	0.92	Easement	Westhampton	New
186	900	39200.00	200.00	2000.000	Private	0.04	0.02	Easement	Westhampton	New
187	900	39200.00	200.00	20001.00 0	Public	0.15	0.15	Access Agreement	Westhampton	New
188	900	39200.00	200.00	3000.000	Private	0.68	0.22	Easement	Westhampton	New
189	900	39200.00	200.00	4000.000	Private	0.59	0.11	Easement	Westhampton	New
190	900	39200.00	200.00	5000.000	Private	0.39	0.15	Easement	Westhampton	New
191	905	1600.00	200.00	5000.000	Private	0.60	0.22	Easement	Westhampton	New
192	905	1600.00	200.00	6000.000	Private	0.35	0.11	Easement	Westhampton	New
193	905	1600.00	200.00	7000.000	Private	0.36	0.11	Easement	Westhampton	New
194	900	39200.00	200.00	6000.000	Private	0.79	0.30	Easement	Westhampton	New
195	900	39200.00	200.00	7000.000	Private	3.00	1.05	Easement	Westhampton	New
196	900	39200.00	200.00	21000.00 0	Private	6.12	3.09	Easement	Westhampton	New

WESTHAMPTON										
No.	District	Section	Block	Lot	Owner	Parcel Area (AC)	Easement Area (AC)	Estate	Reach	Status
197	900	39200.00	200.00	11003.00 0	Private	0.83	0.30	Easement	Westhampton	New
198	900	39200.00	200.00	11002.00 0	Private	0.80	0.28	Easement	Westhampton	New
199	900	39200.00	200.00	11001.00 0	Private	0.84	0.30	Easement	Westhampton	New
200	900	39200.00	200.00	12001.00 0	Private	0.94	0.35	Easement	Westhampton	New
201	900	39200.00	200.00	12002.00 0	Private	0.94	0.35	Easement	Westhampton	New
202	900	39200.00	200.00	14001.00 0	Private	0.90	0.31	Easement	Westhampton	New
203	900	39200.00	200.00	15000.00 0	Private	0.58	0.20	Easement	Westhampton	New
204	900	39200.00	200.00	16000.00 0	Private	0.59	0.22	Easement	Westhampton	New
205	900	39200.00	200.00	17000.00 0	Private	0.52	0.13	Easement	Westhampton	New
206	900	39300.00	100.00	38000.00 0	Private	1.87	0.68	Easement	Westhampton	New
207	900	39200.00	200.00	18001.00 0	Private	0.86	0.20	Easement	Westhampton	New
208	905	1600.00	200.00	1000.000	Private	1.07	0.41	Easement	Westhampton	New
209	905	1600.00	200.00	2000.000	Private	0.64	0.26	Easement	Westhampton	New
210	905	1600.00	200.00	3002.000	Private	0.49	0.05	Easement	Westhampton	New
211	905	1600.00	200.00	3001.000	Private	0.52	0.06	Easement	Westhampton	New
212	905	1600.00	200.00	4000.000	Private	0.76	0.21	Easement	Westhampton	New
213	905	1600.00	200.00	8000.000	Private	0.34	0.11	Easement	Westhampton	New
214	905	1600.00	200.00	9000.000	Private	0.37	0.14	Easement	Westhampton	New
215	905	1600.00	200.00	10000.00 0	Private	0.56	0.21	Easement	Westhampton	New

WESTHAMPTON										
No.	District	Section	Block	Lot	Owner	Parcel Area (AC)	Easement Area (AC)	Estate	Reach	Status
216	905	1600.00	200.00	11000.00 0	Private	0.56	0.21	Easement	Westhampton	New
217	905	1600.00	200.00	13000.00 0	Private	0.61	0.26	Easement	Westhampton	New
218	905	1600.00	200.00	14000.00 0	Private	0.04	0.01	Easement	Westhampton	New
219	905	1600.00	200.00	15000.00 0	Private	0.52	0.20	Easement	Westhampton	New
220	905	1600.00	200.00	16000.00 0	Private	0.55	0.21	Easement	Westhampton	New
221	905	1700.00	500.00	1000.000	Private	3.57	0.98	Easement	Westhampton	New
222	905	1600.00	200.00	17000.00 0	Private	0.60	0.18	Easement	Westhampton	New
223	905	1600.00	200.00	18000.00 0	Private	0.63	0.21	Easement	Westhampton	New
224	905	1600.00	200.00	19000.00 0	Private	0.50	0.16	Easement	Westhampton	New
225	905	1600.00	200.00	20000.00 0	Private	0.54	0.16	Easement	Westhampton	New
226	905	1600.00	200.00	21000.00 0	Private	0.43	0.05	Easement	Westhampton	New
227	905	1600.00	200.00	22000.00 0	Private	0.75	0.08	Easement	Westhampton	New
228	905	1600.00	200.00	23000.00 0	Private	0.75	0.08	Easement	Westhampton	New
229	905	1600.00	200.00	25001.00 0	Private	0.92	0.25	Easement	Westhampton	New
230	905	1600.00	200.00	26000.00 0	Private	3.16	0.82	Easement	Westhampton	New
231	905	1700.00	500.00	2000.000	Private	0.68	0.17	Easement	Westhampton	New
232	905	1700.00	500.00	9000.000	Private	0.20	0.03	Easement	Westhampton	New

WESTHAMPTON										
No.	District	Section	Block	Lot	Owner	Parcel Area (AC)	Easement Area (AC)	Estate	Reach	Status
233	905	1700.00	500.00	10000.00 0	Private	0.04	0.01	Easement	Westhampton	New
234	905	1700.00	500.00	3000.000	Private	0.69	0.17	Easement	Westhampton	New
235	905	1700.00	500.00	11000.00 0	Public	0.19	0.03	Access Agreement	Westhampton	New
236	905	1700.00	500.00	17000.00 0	Private	0.12	0.02	Easement	Westhampton	New
237	905	1700.00	500.00	4000.000	Private	1.23	0.52	Easement	Westhampton	New
238	905	1700.00	500.00	18000.00 0	Public	0.12	0.02	Access Agreement	Westhampton	New
239	905	1700.00	500.00	5000.000	Private	0.45	0.04	Easement	Westhampton	New
240	905	1700.00	500.00	19000.00 0	Public	0.14	0.02	Access Agreement	Westhampton	New
241	905	1700.00	500.00	6000.000	Private	0.39	0.13	Easement	Westhampton	New
242	905	1700.00	500.00	26001.00 0	Private	0.15	0.02	Easement	Westhampton	New
243	905	1700.00	500.00	7000.000	Private	0.48	0.15	Easement	Westhampton	New
244	905	1700.00	500.00	27000.00 0	Private	0.05	0.01	Easement	Westhampton	New
245	905	1700.00	500.00	28000.00 0	Private	0.20	0.03	Easement	Westhampton	New
246	905	1700.00	500.00	34000.00 0	Public	0.16	0.02	Access Agreement	Westhampton	New
247	905	1700.00	500.00	35000.00 0	Public	0.16	0.01	Access Agreement	Westhampton	New
248	905	1700.00	500.00	36000.00 0	Public	0.17	0.01	Access Agreement	Westhampton	New
249	905	1700.00	500.00	43000.00 0	Private	0.12	0.00	Easement	Westhampton	New
250	905	1700.00	500.00	12000.00 0	Public	0.60	0.01	Access Agreement	Westhampton	New

WESTHAMPTON										
No.	District	Section	Block	Lot	Owner	Parcel Area (AC)	Easement Area (AC)	Estate	Reach	Status
251	905	1700.00	500.00	50000.000	Private	0.47	0.04	Easement	Westhampton	New
252	905	1700.00	500.00	51000.000	Private	0.75	0.03	Easement	Westhampton	New
253	905	1700.00	500.00	56000.000	Public	0.54	0.16	Access Agreement	Westhampton	New
254	905	1700.00	500.00	55001.000	Private	4.89	0.57	Easement	Westhampton	New
255	905	1800.00	200.00	2000.000	Private	1.07	0.16	Easement	Westhampton	New
256	905	1800.00	200.00	3000.000	Private	0.95	0.09	Easement	Westhampton	New
257	905	1800.00	200.00	4000.000	Private	1.08	0.27	Easement	Westhampton	New
258	905	1800.00	200.00	5000.000	Private	0.98	0.03	Easement	Westhampton	New
259	905	1800.00	200.00	6000.000	Private	0.98	0.21	Easement	Westhampton	New
260	905	1800.00	200.00	7000.000	Private	0.94	0.15	Easement	Westhampton	New
261	905	1800.00	200.00	8000.000	Private	0.92	0.15	Easement	Westhampton	New
262	905	1800.00	200.00	9000.000	Private	0.89	0.12	Easement	Westhampton	New
263	905	1800.00	200.00	10000.000	Private	0.86	0.15	Easement	Westhampton	New
264	905	1800.00	200.00	11000.000	Private	0.81	0.06	Easement	Westhampton	New
265	905	1800.00	200.00	30000.000	Public	0.23	0.19	Access Agreement	Westhampton	New
266	905	1800.00	200.00	12000.000	Private	0.64	0.08	Easement	Westhampton	New
267	905	1800.00	200.00	13000.000	Private	0.60	0.09	Easement	Westhampton	New
268	905	1800.00	200.00	15000.000	Private	0.68	0.14	Easement	Westhampton	New
269	905	1800.00	200.00	14000.000	Private	0.65	0.11	Easement	Westhampton	New

WESTHAMPTON										
No.	District	Section	Block	Lot	Owner	Parcel Area (AC)	Easement Area (AC)	Estate	Reach	Status
270	905	1800.00	200.00	16000.00 0	Private	0.77	0.06	Easement	Westhampton	New
271	905	1800.00	200.00	17000.00 0	Private	0.75	0.16	Easement	Westhampton	New
272	905	1800.00	200.00	18000.00 0	Private	0.77	0.17	Easement	Westhampton	New
273	905	1800.00	200.00	19000.00 0	Private	0.77	0.17	Easement	Westhampton	New
274	905	1800.00	200.00	20000.00 0	Private	0.78	0.18	Easement	Westhampton	New
275	905	1800.00	200.00	21000.00 0	Private	0.91	0.34	Easement	Westhampton	New
276	905	1800.00	200.00	22000.00 0	Private	0.92	0.34	Easement	Westhampton	New
277	905	1800.00	200.00	23000.00 0	Private	0.90	0.33	Easement	Westhampton	New
278	905	1800.00	200.00	25000.00 0	Private	0.12	0.05	Easement	Westhampton	New
279	905	1800.00	200.00	24000.00 0	Private	0.68	0.07	Easement	Westhampton	New
280	905	1800.00	200.00	26000.00 0	Private	0.82	0.30	Easement	Westhampton	New
281	905	1800.00	200.00	29000.00 0	Private	0.85	0.30	Easement	Westhampton	New
282	905	1800	200	27000	Private	0.71	0.04	Easement	Westhampton	New
283	905	1800	200	28000	Private	0.65	0.03	Easement	Westhampton	New
284	905	1900	400	1000	Private	2.91	0.18	Easement	Westhampton	New
285	905	1900	400	2000	Private	0.07	0.00	Easement	Westhampton	New
286	905	1900	400	5000	Private	2.19	0.45	Easement	Westhampton	New
287	905	1900	200	13000	Public	0.07	0.01	Access Agreement	Westhampton	New
288	905	1900	400	6000	Private	3.73	0.98	Easement	Westhampton	New

WESTHAMPTON										
No.	District	Section	Block	Lot	Owner	Parcel Area (AC)	Easement Area (AC)	Estate	Reach	Status
289	905	1900	500	2001	Private	0.96	0.16	Easement	Westhampton	New
290	905	1900	100	17000	Private	2.72	0.55	Easement	Westhampton	New
291	905	2000	200	32000	Public	0.10	0.01	Access Agreement	Westhampton	New
292	905	1900	200	12000	Private	4.40	0.06	Easement	Westhampton	New
293	905	2000	200	1000	Private	0.90	0.02	Easement	Westhampton	New
294	905	2000	200	2001	Private	0.82	0.01	Easement	Westhampton	New
295	905	2000	200	3000	Private	0.91	0.03	Easement	Westhampton	New
296	905	2000	200	4000	Private	0.70	0.03	Easement	Westhampton	New
297	905	2000	200	5000	Private	0.70	0.03	Easement	Westhampton	New
298	905	2000	200	7000	Private	1.10	0.23	Easement	Westhampton	New
299	905	2000	200	31001	Private	1.30	0.38	Easement	Westhampton	New
300	905	2000	200	14000	Private	0.88	0.19	Easement	Westhampton	New
301	905	1600	200	12000	Private	0.56	0.22	Easement	Westhampton	New
302	905	2000	200	11000	Private	1.40	0.04	Easement	Westhampton	New
303	905	2000	200	15000	Private	0.90	0.23	Easement	Westhampton	New
304	905	2000	200	16000	Private	1.58	0.20	Easement	Westhampton	New
305	905	2000.00	200.00	23000.00 0	Private	0.72	0.00	Easement	Westhampton	New
306	905	2000.00	200.00	26000.00 0	Private	0.59	0.06	Easement	Westhampton	New
307	905	2000.00	200.00	20001.00 0	Private	1.93	0.05	Easement	Westhampton	New
308	900	39500.00	200.00	1000.000	Public	46474.94	87.84	Access Agreement	Westhampton	New

WEST OF SHINNECOCK INLET										
No.	District	Section	Block	Lot	Owner	Parcel Area (AC)	Acquisition Area (AC)	Estate	Reach	Status
190	900	379.00	2.00	2.000	Public	39.04	11.77	Access Agreement	Ponquogue	Acquired

191	900	379.00	2.00	3.000	Public	42.88	13.80	Access Agreement	Ponquogue	Acquired
192	900	379.00	2.00	6.001	Public	9.71	3.60	Access Agreement	Ponquogue	Acquired
193	900	379.00	2.00	7.000	Public	24.29	13.20	Access Agreement	WOSI	Acquired
194	900	364.00	1.00	8.000	Public	19.61	13.88	Access Agreement	WOSI	Acquired

NONSTRUCTURAL - FEE ACQUISITIONS										
No.	District	Section	Block	Lot	Owner	Parcel Area (AC)	Acquisition Area (AC)	Estate	Reach	Status
154_27.00					Private	0.14	0.14	Fee	Nonstructural	New
154_28.00					Private	0.15	0.15	Fee	Nonstructural	New
198_117.00					Private	0.15	0.15	Fee	Nonstructural	New
248_99.00					Private	0.06	0.16	Fee	Nonstructural	New