



DEPARTMENT OF THE ARMY  
U.S. ARMY CORPS OF ENGINEERS, NEW YORK DISTRICT  
JACOB K. JAVITS FEDERAL BUILDING  
26 FEDERAL PLAZA  
NEW YORK, NEW YORK 10278

CENAN-OP-RE

MEMORANDUM FOR RECORD

SUBJECT: US Army Corps of Engineers (Corps) Approved Jurisdictional Determination in accordance with the “Revised Definition of ‘Waters of the United States’”; (88 FR 3004 (January 18, 2023) as amended by the “Revised Definition of ‘Waters of the United States’; Conforming” (8 September 2023),<sup>1</sup> NAN-2023-00524-EKO

BACKGROUND. An Approved Jurisdictional Determination (AJD) is a Corps document stating the presence or absence of waters of the United States on a parcel or a written statement and map identifying the limits of waters of the United States on a parcel. AJDs are clearly designated appealable actions and will include a basis of JD with the document.<sup>2</sup> AJDs are case-specific and are typically made in response to a request. AJDs are valid for a period of five years unless new information warrants revision of the determination before the expiration date or a District Engineer has identified, after public notice and comment, that specific geographic areas with rapidly changing environmental conditions merit re-verification on a more frequent basis.<sup>3</sup>

On January 18, 2023, the Environmental Protection Agency (EPA) and the Department of the Army (“the agencies”) published the “Revised Definition of ‘Waters of the United States,’” 88 FR 3004 (January 18, 2023) (“2023 Rule”). On September 8, 2023, the agencies published the “Revised Definition of ‘Waters of the United States’; Conforming”, which amended the 2023 Rule to conform to the 2023 Supreme Court decision in *Sackett v. EPA*, 598 U.S., 143 S. Ct. 1322 (2023) (“Sackett”).

This Memorandum for Record (MFR) constitutes the basis of jurisdiction for a Corps AJD as defined in 33 CFR §331.2. For the purposes of this AJD, we have relied on Section 10 of the Rivers and Harbors Act of 1899 (RHA),<sup>4</sup> the 2023 Rule as amended, as well as other applicable guidance, relevant case law, and longstanding practice in evaluating jurisdiction.

1. SUMMARY OF CONCLUSIONS.

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<sup>1</sup> While the Revised Definition of “Waters of the United States”; Conforming had no effect on some categories of waters covered under the CWA, and no effect on any waters covered under RHA, all categories are included in this Memorandum for Record for efficiency.

<sup>2</sup> 33 CFR 331.2.

<sup>3</sup> Regulatory Guidance Letter 05-02.

<sup>4</sup> USACE has authority under both Section 9 and Section 10 of the Rivers and Harbors Act of 1899 but for convenience, in this MFR, jurisdiction under RHA will be referred to as Section 10.

- a. Provide a list of each individual feature within the review area and the jurisdictional status of each one (i.e., identify whether each feature is/is not a water of the United States and/or a navigable water of the United States).
  - i. Wetland 1 (WA) – non-jurisdictional
  - ii. Wetland 2 (WB) – non-jurisdictional
  - iii. Wetland 3 (WC) – non-jurisdictional
  - iv. Wetland 4 (WD) – jurisdictional
  - v. Wetland 5 (WE) – non-jurisdictional
  - vi. Wetland 6 (WF) – non-jurisdictional
  - vii. Wetland 7 (WG) – non-jurisdictional
  - viii. Wetland 8 (WH) – non-jurisdictional
  - ix. Wetland 9 (WJ) – non-jurisdictional
  - x. Wetland 10 (WK) – non-jurisdictional
  - xi. Wetland 11 (WL) – non-jurisdictional
  - xii. Wetland 12 (WM) – non-jurisdictional
  - xiii. Wetland 13 (WN) – non-jurisdictional
  - xiv. Wetland 14 (WP) – non-jurisdictional
  - xv. Wetland 15 (WQ) – non-jurisdictional
  - xvi. Wetland 16 (WR) – non-jurisdictional
  - xvii. Wetland 17 (WS) – non-jurisdictional
  - xviii. Wetland 18 (WT) – non-jurisdictional
  - xix. Wetland 19 (WU) – non-jurisdictional
  - xx. Wetland 20 (WW) – non-jurisdictional
  - xxi. Wetland 21 (WXX) – non-jurisdictional
  - xxii. Wetland 22 (WY) – non-jurisdictional
  - xxiii. Wetland 23 (WZ) – non-jurisdictional
  - xxiv. Wetland 24 (WAA) – non-jurisdictional
  - xxv. Wetland 25 (WAB) – non-jurisdictional
  - xxvi. Wetland 26 (WAC/WAD) – non-jurisdictional
  - xxvii. Wetland 27 (WAE/WAF) – non-jurisdictional
  - xxviii. Wetland 28 (WAG/WAH) – non-jurisdictional
  - xxix. Waterbody 1 (North Cove) – Jurisdictional – TNW
  - xxx. Waterbody 2 (SA/SB/SC) – non-jurisdictional
  - xxxi. Waterbody 3 (SD/SW/SZ) – jurisdictional – seasonal RPW
  - xxxii. Waterbody 4 (SX/SY) – jurisdictional – seasonal RPW

2. REFERENCES.

- a. “Revised Definition of ‘Waters of the United States,’” 88 FR 3004 (January 18, 2023) (“2023 Rule”)

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b. “Revised Definition of ‘Waters of the United States’; Conforming” 88 FR 61964 (September 8, 2023))

c. *Sackett v. EPA*, 598 U.S., 143 S. Ct. 1322 (2023)

3. REVIEW AREA.

The project site is approximately 232 in acres; 40.704656°, -74.052974°, Liberty State Park in Jersey City, Hudson County, New Jersey

4. NEAREST TRADITIONAL NAVIGABLE WATER (TNW), THE TERRITORIAL SEAS, OR INTERSTATE WATER TO WHICH THE AQUATIC RESOURCE IS CONNECTED.

Upper New York Bay. The Upper New York Bay is approximately 1000 feet away from the project.

5. FLOWPATH FROM THE SUBJECT AQUATIC RESOURCES TO A TNW, THE TERRITORIAL SEAS, OR INTERSTATE WATER.

The flow path from the Wetland WD to the Upper New York Bay is that it flows through a culvert under the road into another wetland that is directly adjacent to Upper New York Bay. The flow path from SD/SE/SZ and SX/SY is that they flow through culverts, directly into the Morris Canal Basin.

6. SECTION 10 JURISDICTIONAL WATERS<sup>5</sup>: Describe aquatic resources or other features within the review area determined to be jurisdictional in accordance with Section 10 of the Rivers and Harbors Act of 1899. Include the size of each aquatic resource or other feature within the review area and how it was determined to be jurisdictional in accordance with Section 10.<sup>6</sup>

Waterbody 1 (North Cove) is a TNW connected to the Hudson River.

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<sup>5</sup> 33 CFR 329.9(a) A waterbody which was navigable in its natural or improved state, or which was susceptible of reasonable improvement (as discussed in § 329.8(b) of this part) retains its character as “navigable in law” even though it is not presently used for commerce, or commerce or is presently incapable of such use because of changed conditions or the presence of obstructions.

<sup>6</sup> This MFR is not to be used to make a report of findings to support a determination that the water is a navigable water of the United States. The district must follow the procedures outlined in 33 CFR part 329.14 to make a determination that water is a navigable water of the United States subject to Section 10 of the RHA.

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7. SECTION 404 JURISDICTIONAL WATERS: Describe the aquatic resources within the review area that were found to meet the definition of waters of the United States in accordance with the 2023 Rule as amended, consistent with the Supreme Court's decision in *Sackett*. List each aquatic resource separately, by name, consistent with the naming convention used in section 1, above. Include a rationale for each aquatic resource, supporting that the aquatic resource meets the relevant category of "waters of the United States" in the 2023 Rule as amended. The rationale should also include a written description of, or reference to a map in the administrative record that shows, the lateral limits of jurisdiction for each aquatic resource, including how that limit was determined, and incorporate relevant references used. Include the size of each aquatic resource in acres or linear feet and attach and reference related figures as needed.
  - a. Traditional Navigable Waters (TNWs) (a)(1)(i): North Cove, 1.08 acres
  - b. The Territorial Seas (a)(1)(ii): N/A
  - c. Interstate Waters (a)(1)(iii): N/A
  - d. Impoundments (a)(2): N/A
  - e. Tributaries (a)(3): Waterbody 3 (SD/SE/SZ), 0.41 acres, and Waterbody 4 (SX/SY), 1.907 acres. Waterbody 3 flows into Waterbody 4 via a 24-inch RCP. Waterbody 4 flows directly into the Morris Canal Basin of Upper New York Bay via 28-inch RCP. Both ditches have portions which are subject to the ebb and flow of the tide though they both rely on stormwater inputs for flow and dry up seasonally.
  - f. Adjacent Wetlands (a)(4): Wetland 4 (WD), 0.514 acres, this wetland drains into another wetland off-site which is adjacent to the Upper New York Bay via an 18" Corrugated Metal Pipe (cmp) under a parking lot and Freedom Way.
  - g. Additional Waters (a)(5): N/A

## 8. NON-JURISDICTIONAL AQUATIC RESOURCES AND FEATURES

- a. Describe aquatic resources and other features within the review area identified in the 2023 Rule as amended as not "waters of the United States" even where they otherwise meet the terms of paragraphs (a)(2) through (5). Include the type of excluded aquatic resource or feature, the size of the aquatic resource or feature

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within the review area and describe how it was determined to meet one of the exclusions listed in 33 CFR 328.3(b).<sup>7</sup> N/A

- b. Describe aquatic resources and features within the review area that were determined to be non-jurisdictional because they do not meet one or more categories of waters of the United States under the 2023 Rule as amended (e.g., tributaries that are non-relatively permanent waters; non-tidal wetlands that do not have a continuous surface connection to a jurisdictional water).

Wetland 1 (WA) is an approximately 0.07 acre Palustrine Emergent Persistent Seasonally Flooded/Saturated (PEM1E) wetland dominated by common reed (*Phragmites australis*) with sandy/loamy soils and histic epipedon indicators. There does not appear to be any continuous surface connection to a jurisdictional water. Wetland WA is located approximately 1,250 feet from Water SD/SE/SZ, with no apparent continuous surface connection.

Wetland 2 (WB) is an approximately 0.53 acre Palustrine Emergent Persistent Seasonally Flooded/Saturated (PEM1E) wetland dominated by common reed (*Phragmites australis*) with sandy/loamy soils and histic epipedon indicators. There does not appear to be any continuous surface connection to a jurisdictional water. Wetland WB is located approximately 1,450 feet from Water SD/SE/SZ, with no apparent continuous surface connection.

Wetland 3 (WC) is an approximately 1.55 acre Palustrine Emergent Persistent Seasonally Flooded/Saturated (PEM1E) wetland dominated by common reed (*Phragmites australis*) with sandy/loamy soils and sandy mucky mineral indicators. There does not appear to be any continuous surface connection to a jurisdictional water. Wetland WC is located approximately 1,850 feet from Water SD/SE/SZ, with no apparent continuous surface connection.

Wetland 5 (WE) is an approximately 0.03 acre Palustrine Emergent Persistent Seasonally Flooded/Saturated (PEM1E) wetland. There does not appear to be any continuous surface connection to a jurisdictional water. There does not appear to be any continuous surface connection to a jurisdictional water. Wetland WE is located approximately 1,870 feet from Water SD/SE/SZ, with no apparent continuous surface connection.

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<sup>7</sup> 88 FR 3004 (January 18, 2023)

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Wetland 6 (WF) is an approximately 1.03 acre Palustrine Emergent Persistent Seasonally Flooded/Saturated (PEM1E) wetland dominated by common reed (*Phragmites australis*) with sandy soils and sandy redox indicators. There does not appear to be any continuous surface connection to a jurisdictional water. Wetland WF is located approximately 1,620 feet from Water SD/SE/SZ, with no apparent continuous surface connection.

Wetland 7 (WG) is an approximately 0.21 acre Palustrine Forested Broad-Leaved Deciduous Temporarily Flooded/Saturated (PFO1A) wetland dominated by Sensitive fern (*Onoclea sensibilis*) with sandy/loamy soils and Histic Epipedon indicators. There does not appear to be any continuous surface connection to a jurisdictional water. Wetland WG is located approximately 1,670 feet from Upper New York Bay, with no apparent continuous surface connection.

Wetland 8 (WH) is an approximately 0.12 acre Palustrine Forested Broad-Leaved Deciduous Seasonally Flooded/Saturated (PFO1E) wetland dominated by red maple (*Acer rubrum*) with sandy/loamy soils and Histic Epipedon indicators. There does not appear to be any continuous surface connection to a jurisdictional water.

Wetland 9 (WJ) is an approximately 0.39 acre Palustrine Scrub/Shrub Broad-Leaved Deciduous Seasonally Flooded/Saturated (PSS1A) wetland dominated by Purple loosestrife (*Lythrum salicaria*) with sandy/loamy soils and Histic Epipedon indicators. There does not appear to be any continuous surface connection to a jurisdictional water.

Wetland 10 (WK) is an approximately 0.12 acre Palustrine Forested Broad-Leaved Deciduous Temporarily Flooded/Saturated (PFO1E) wetland dominated by red maple (*Acer rubrum*) with sandy/loamy soils and Histic Epipedon indicators. There does not appear to be any continuous surface connection to a jurisdictional water.

Wetland 11 (WL) is an approximately 0.02 acre Palustrine Forested Broad-Leaved Deciduous Temporarily Flooded/Saturated (PFO1A) wetland dominated by Switchgrass (*Panicum virgatum*) with sandy/loamy soils and Depleted Below Dark Surface and Sandy redox indicators. There does not appear to be any continuous surface connection to a jurisdictional water.

Wetland 12 (WM) is an approximately 0.02 acre Palustrine Forested Broad-Leaved Deciduous Temporarily Flooded/Saturated (PFO1A) wetland dominated by common reed (*Phragmites australis*) with sandy/loamy soils

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and Sandy redox indicators. There does not appear to be any continuous surface connection to a jurisdictional water.

Wetland 13 (WN) is an approximately 0.02 acre Palustrine Forested Broad-Leaved Deciduous Temporarily Flooded/Saturated (PFO1A) wetland dominated by common reed (*Phragmites australis*) with sandy/loamy soils and Depleted Below Dark Surface and Sandy redox indicators. There does not appear to be any continuous surface connection to a jurisdictional water.

Wetland 14 (WP) is an approximately 0.76 acre Palustrine Emergent Persistent Seasonally Flooded/Saturated (PEM1E) wetland dominated by common reed (*Phragmites australis*) with sandy soils and sandy redox indicators. There does not appear to be any continuous surface connection to a jurisdictional water.

Wetland 15 (WQ) is an approximately 0.03 acre Palustrine Forested Broad-Leaved Deciduous Temporarily Flooded/Saturated (PFO1A) wetland. There does not appear to be any continuous surface connection to a jurisdictional water.

Wetland 16 WR is an approximately 0.02 acre Palustrine Emergent Persistent Seasonally Flooded/Saturated (PEM1E). There does not appear to be any continuous surface connection to a jurisdictional water.

Wetland 17 (WS) is an approximately 0.06 acre Palustrine Emergent Persistent Seasonally Flooded/Saturated (PEM1E) wetland dominated by common reed (*Phragmites australis*) with sandy/loamy soils and Depleted Below Dark Surface and Sandy redox indicators. There does not appear to be any continuous surface connection to a jurisdictional water.

Wetland 18 (WT) is an approximately 0.32 acre Palustrine Emergent Persistent Seasonally Flooded/Saturated (PEM1E) wetland dominated by Poison ivy (*Toxicodendron radicans*) with loamy soils and depleted matrix indicators. There does not appear to be any continuous surface connection to a jurisdictional water.

Wetland 19 (WU) is an approximately 0.05 acre Palustrine Emergent Persistent Seasonally Flooded/Saturated (PEM1A) wetland dominated by Purple loosestrife (*Lythrum salicaria*) with loamy soils and depleted below dark surface indicators. There does not appear to be any continuous surface connection to a jurisdictional water.

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Wetland 20 (WW) is an approximately 0.32 acre Palustrine Emergent Persistent Seasonally Flooded/Saturated (PEM1E) wetland dominated by common reed (*Phragmites australis*) with sandy/loamy soils and Depleted Below Dark Surface and Sandy redox indicators. There does not appear to be any continuous surface connection to a jurisdictional water.

Wetland 21 (WXX) is an approximately 1.22 acre Palustrine Emergent Persistent Seasonally Flooded/Saturated (PEM1A) wetland dominated by common reed (*Phragmites australis*) with sandy/loamy soils and Depleted Below Dark Surface and Sandy redox indicators. There does not appear to be any continuous surface connection to a jurisdictional water.

Wetland 22 (WY) is an approximately 0.27 acre Palustrine Emergent Persistent Seasonally Flooded/Saturated (PEM1E) wetland dominated by common reed (*Phragmites australis*) with sandy/loamy soils and Depleted Below Dark Surface and Sandy redox indicators. There does not appear to be any continuous surface connection to a jurisdictional water.

Wetland 23 (WZ) is an approximately 3.54 acre Palustrine Emergent Persistent Seasonally Flooded/Saturated (PEM1A) wetland dominated by Woolgrass (*Scirpus cyperinus*) with sandy/loamy soils and Depleted Below Dark Surface and Sandy redox indicators. There does not appear to be any continuous surface connection to a jurisdictional water.

Wetland 24 (WAA) is an approximately 0.16 acre Palustrine Emergent Persistent Seasonally Flooded/Saturated (PEM1A) wetland dominated by Poison ivy (*Toxicodendron radicans*) with sandy/loamy soils and Sandy redox indicators. There does not appear to be any continuous surface connection to a jurisdictional water.

Wetland 25 (WAB) is an approximately 0.11 acre Palustrine Emergent Persistent Seasonally Flooded/Saturated (PEM1A) wetland dominated by Reed canary grass (*Phalaris arundinacea*) with loamy soils and Depleted Below Dark Surface indicators. There does not appear to be any continuous surface connection to a jurisdictional water.

Wetland 26 (WAC/WAD) is an approximately 2.10 acre Palustrine Emergent Persistent Seasonally Flooded/Saturated (PEM1E) wetland dominated by Woolgrass (*Scirpus cyperinus*) with loamy/clayey soils and Depleted Below Dark Surface indicators. There does not appear to be any continuous surface connection to a jurisdictional water.

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Wetland 27 (WAE/WAF) is an approximately 2.21 acre Palustrine Emergent Persistent Seasonally Flooded/Saturated (PEM1C) wetland dominated by common reed (*Phragmites australis*) with sandy/loamy soils and sandy redox indicators. There does not appear to be any continuous surface connection to a jurisdictional water.

Wetland 28 (WAG/WAH) is an approximately 2.32 acre Palustrine Emergent Persistent Seasonally Flooded/Saturated (PEM1F) wetland dominated by common reed (*Phragmites australis*) with mucky loam/clayey soils and Depleted Below Dark Surface indicators. There does not appear to be any continuous surface connection to a jurisdictional water.

Waterbody 2 (SA/SB/SC) is an approximately 2.19 acre man-made ditch. man-made ditch that does not flow into a relatively permanent water (RPW) or a TNW. The ditch used to drain into the Upper New York Bay via two pipes under Freedom Way. In 2001, the NJDEP entered into a Consent Decree that required point source discharges to surface waters from the dredge-spoil storage area be eliminated by permanently plugging the two pipes leading from the ditch under Freedom Way.


9. DATA SOURCES. List sources of data/information used in making determination. Include titles and dates of sources used and ensure that information referenced is available in the administrative record.
  - a. Virtual Office Evaluation on September 25, 2023;
  - b. "WETLAND DELINEATION REPORT Liberty State Park Wetland Delineation Report (Project #2055.001)" prepared by Princeton Hydro dated February 2023;
  - c. Wetland Delineation Sheets and Site Photos prepared by Princeton Hydro on August 7, 2019; and
  - d. National Wetland Inventory Map dated October 2, 2024

10. OTHER SUPPORTING INFORMATION. N/A

11. NOTE: The structure and format of this MFR were developed in coordination with the EPA and Department of the Army. The MFR's structure and format may be subject to future modification or may be rescinded as needed to implement additional guidance from the agencies; however, the approved jurisdictional determination described herein is a final agency action.

1 | 2 | 3 | 4 | 5 | 6 | 7 | 8 | 9 | 10


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# NEW YORK DISTRICT

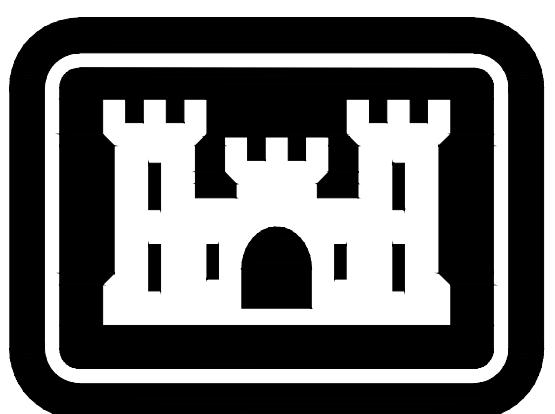**LIBERTY STATE PARK  
APPROVED JURISDICTIONAL DETERMINATION PLAN  
HUDSON COUNTY  
JERSEY CITY, NEW JERSEY**

## LOCATION MAP




**SOLICITATION NO.: W912DS-19-F-0011**

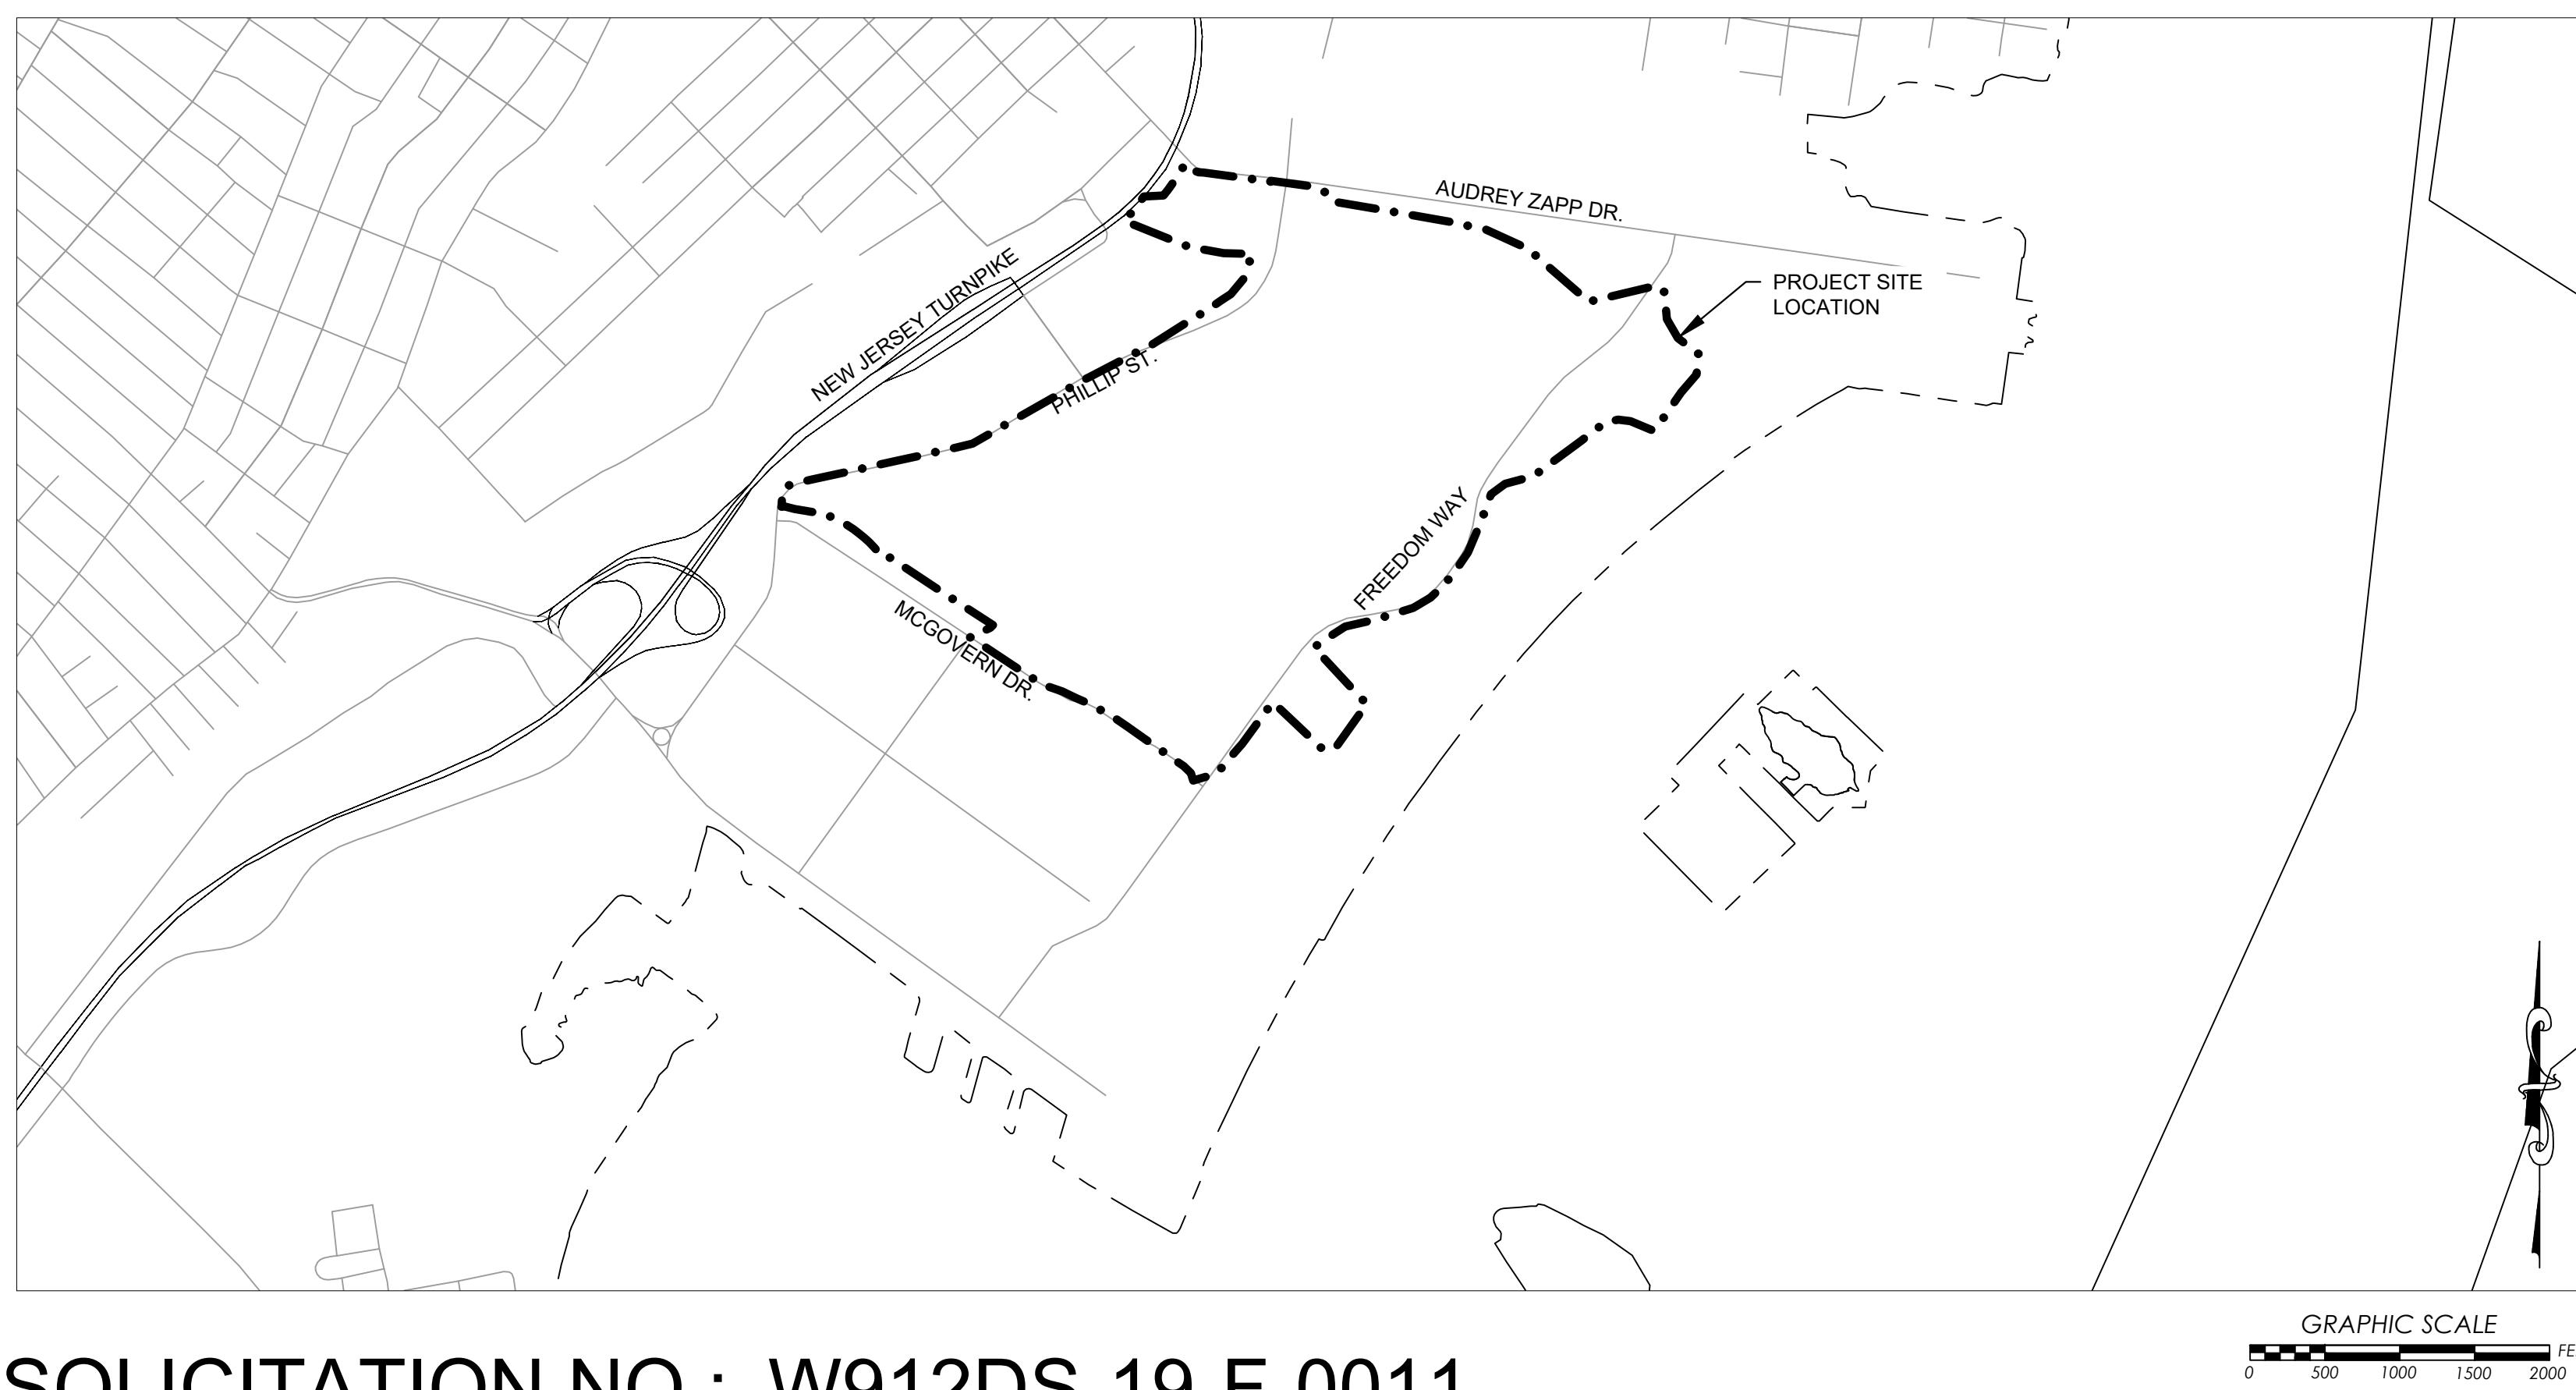**CONTRACT NO.: W912DS-14-D-0001**

**ISSUE DATE: MAY 2023**

# VOLUME 1

## LOCATION MAP

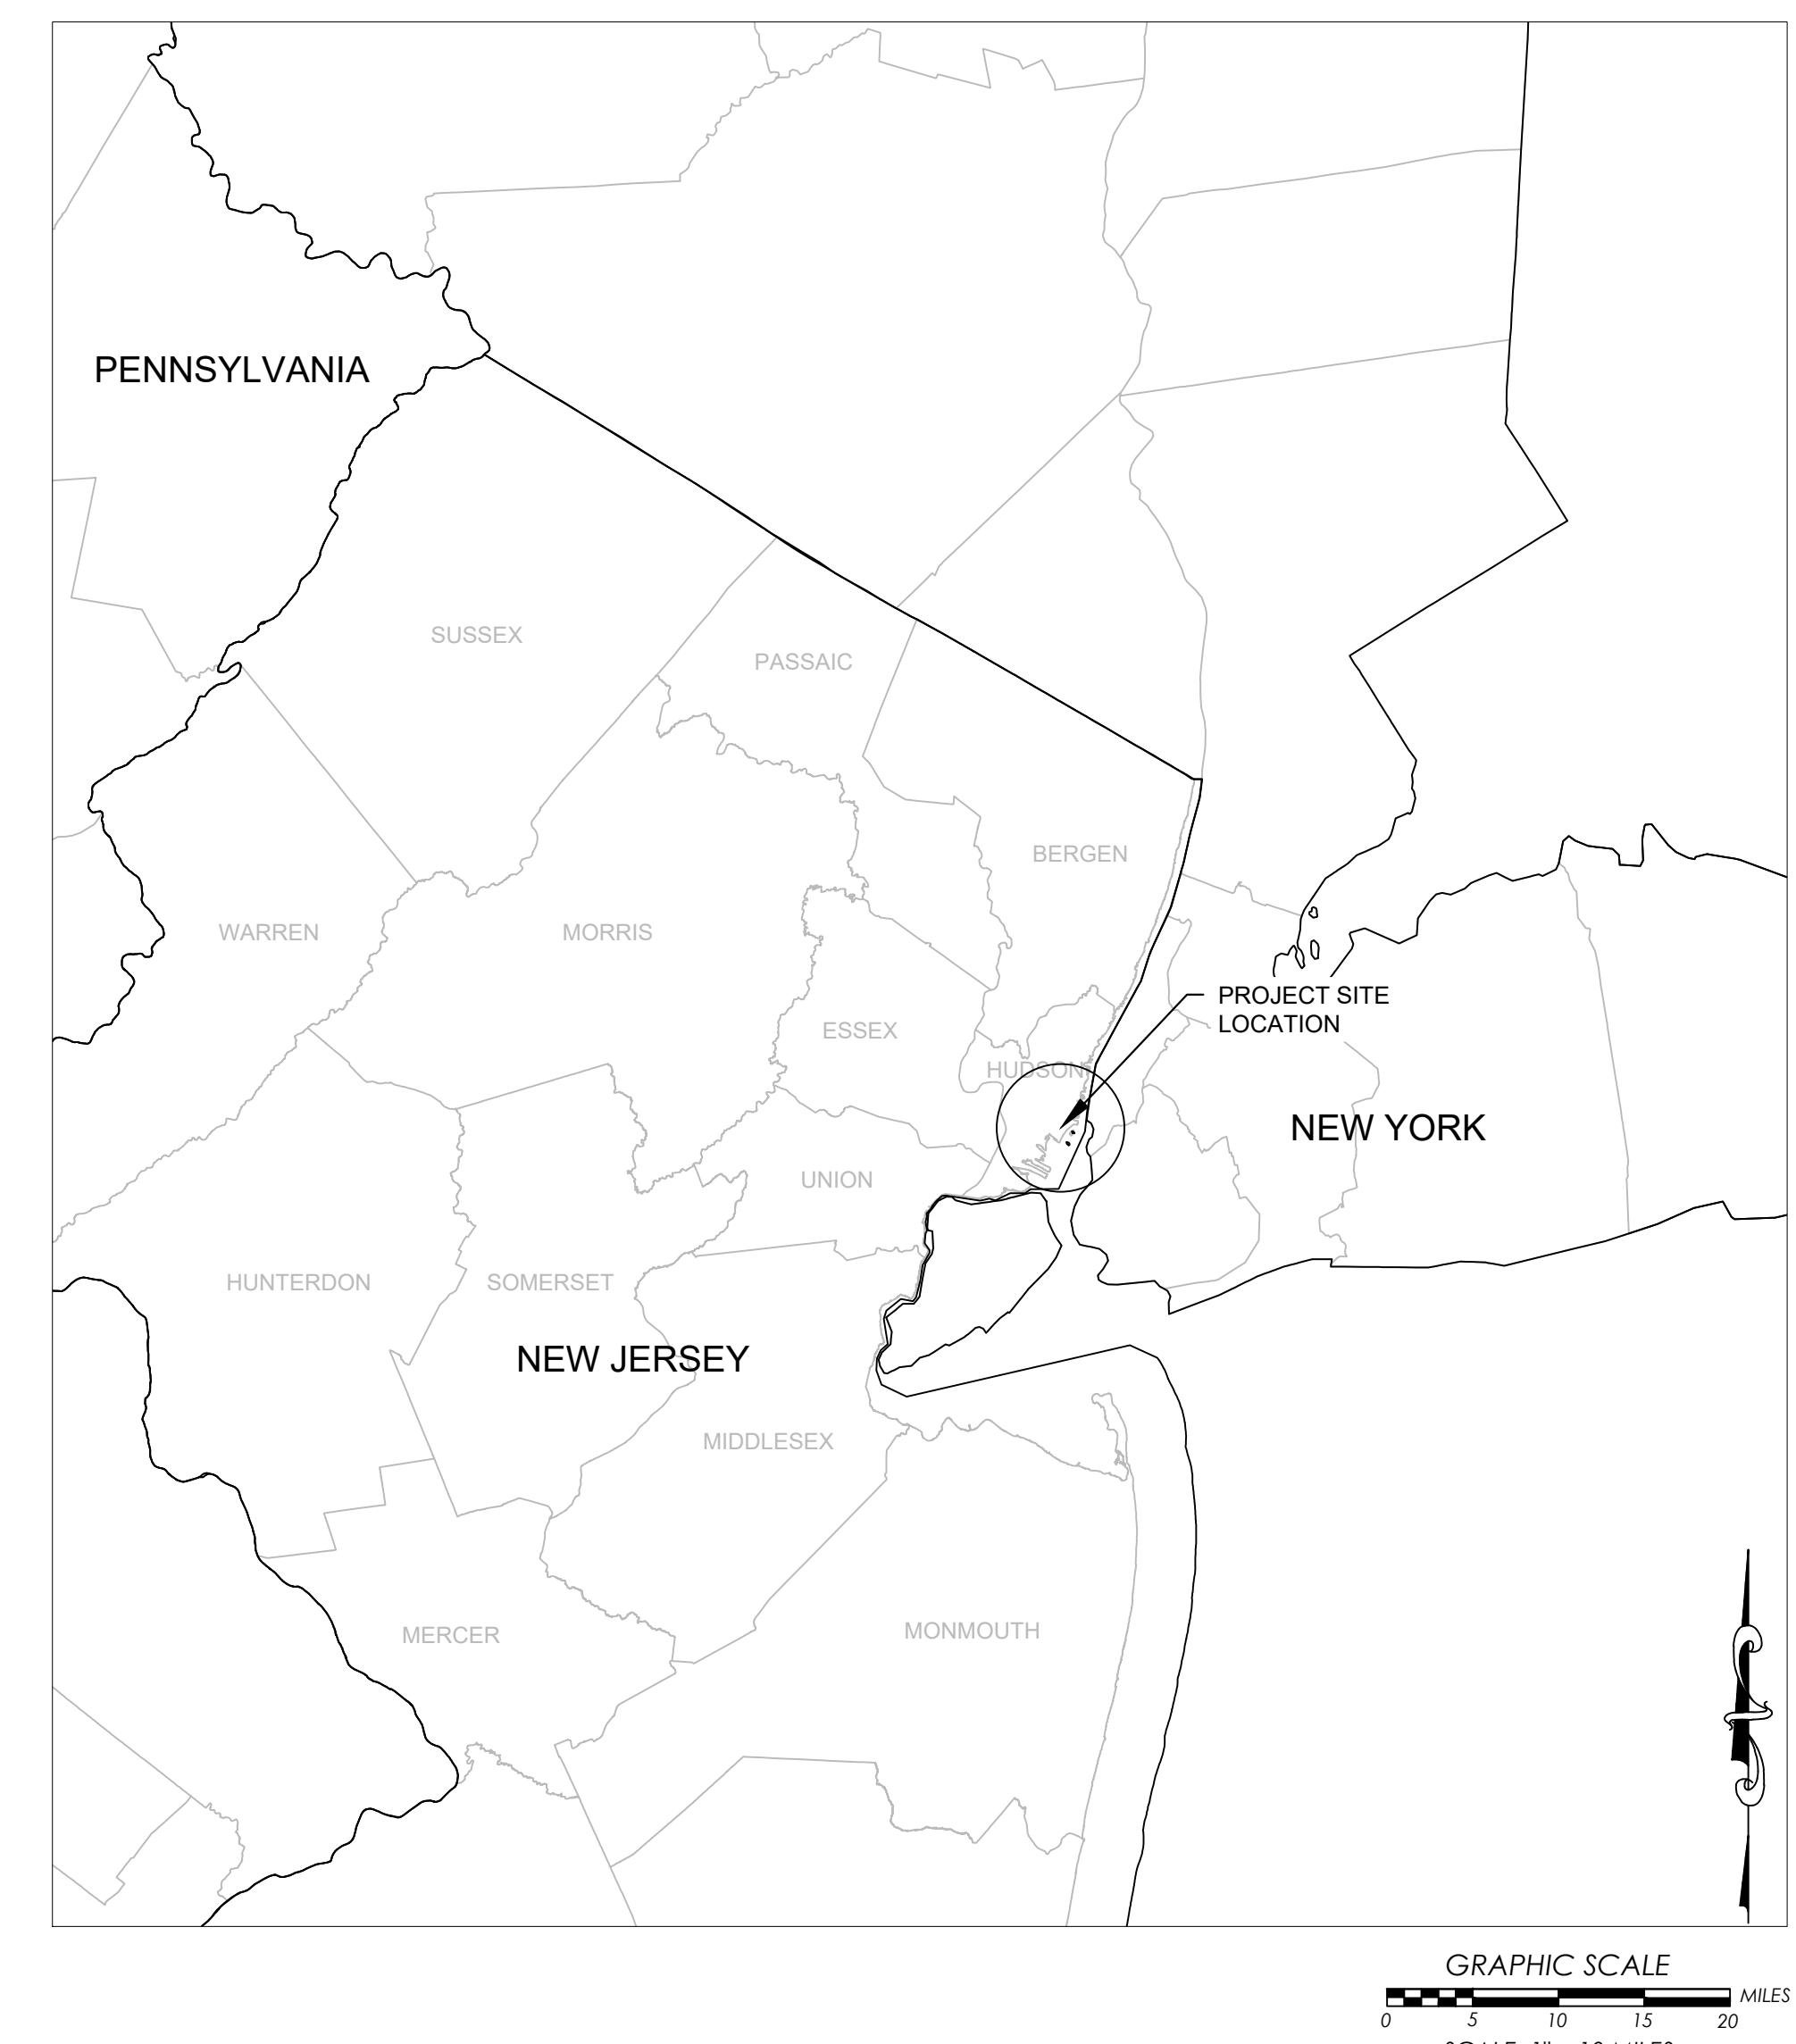

APPLICANT:  
NJDEP OFFICE OF NATURAL RESOURCES RESTORATION  
501 EAST STATE STREET  
MAIL CODE 501-03, PO BOX 420

PROPERTY OWNER (BLOCK 15904, LOT 31):  
CITY OF JERSEY CITY  
280 GROVE STREET  
JERSEY CITY, NJ 07302

**PROPERTY OWNER (ALL OTHER PROPERTY LOTS):**  
NEW JERSEY STATE PARKS, FORESTS & HISTORIC SITES  
501 EAST STATE STREET, 4TH FLOOR  
MAIL CODE 501-04, PO BOX 420  
TRENTON, NJ 08625-0420


PROPERTY LOTS:

BLOCK: 15802      LOTS: 10, 11, 12, 13, 14, 15, 21  
BLOCK: 15904      LOTS: 15, 16, 17, 18, 31  
BLOCK: 21505      LOT: 1  
BLOCK: 21506      LOTS: 1, 2  
BLOCK: 21601      LOTS: 1, 2, 3, 5, 6, 7  
BLOCK: 24401      LOT: 1

JERSEY CITY, HUDSON COUNTY, NEW JERSEY

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US Army Corps  
of Engineers®

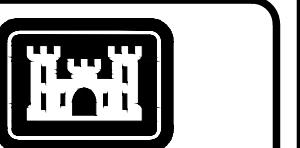

U.S. ARMY CORPS OF ENGINEERS NEW YORK DISTRICT & NJDEP OFFICE OF NATURAL RESOURCE RESTORATION	DESIGNED BY: CAS	ISSUE DATE: JANUARY 2023
	DRAWN BY: CAS	SOLICITATION NO.: W912DS-19-F-0011
	CHECKED BY: JH/CP	CONTRACT NO.: W912DS-14-D-0001
	SUBMITTED BY: PH/HDR	
	SIZE: ANSI D	

**LIBERTY STATE PARK  
ECOSYSTEM RESTORATION PROJECT  
HUDSON COUNTY, NEW JERSEY**

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SHEET ID  
G-002

SHEET ID

**G-002**

## SURVEY NOTES:

1. ALL FIELD SURVEYS PERFORMED BY ROGERS SURVEYING, PLLC (VARIOUS DATES) FOR USE IN BASEMAP CREATION.
  2. HORIZONTAL DATUM : NEW JERSEY STATE PLANE COORDINATE SYSTEM NAD83, FIPS ZONE 2900 FEET.
  3. VERTICAL DATUM : NORTH AMERICAN VERTICAL DATUM OF 1988 - U.S. FEET (NAVD88).
  4. VERTICAL DATUM CONVERSION FACTOR: NGVD29 = NAVD88 + 1.119
  5. MAPPING SHOWN IS COMPILED FROM AERIAL PHOTOGRAHAMTRY COMPLETED ON FEBRUARY 28, 2019.
  6. CONTOURS ARE SHOWN AT 0.5 FOOT INTERVAL.
  7. AERIAL PHOTOGRAPHY CONTROL ESTABLISHED BY STATIC GLOBAL POSITIONING SYSTEM CONTROL NETWORK WAS ADJUSTED TO CONTINUOUSLY OPERATING REFERENCE STATIONS (CORS} MAINTAINED BY THE NATIONAL GEODETIC SURVEY (NGS).
  8. NETWORK ADJUSTMENT RESULTS COMPARED TO NGS ONLINE POSITIONING USER SERVICE (OPUS) AND INDEPENDENT RTK GPS POSITION SOLUTIONS AS QA/QC.
  9. WETLAND DELINEATION AREAS WERE SURVEYED UTILIZING A COMBINATION OF CONVENTIONAL LAND SURVEYING TECHNIQUES AND REAL TIME KINEMATIC GLOBAL POSITIONING SYSTEM.
  10. THE NATIONAL SPATIAL REFERENCE SYSTEM (NSRS) BENCH MARK FOR THE PROJECT IS KV0278 "B 72" ELEVATION 7.72 FEET (NAVD88).

UTILITY SURVEY NOTES:

1. RECORD UTILITY INFORMATION WAS OBTAINED FROM NEW JERSEY DEPARTMENT OF ENVIRONMENTAL PROTECTION (NJDEP) FOR THE FOLLOWING:

- STORM
  - SANITARY
  - WATER
  - GAS
  - TELECOMMUNICATION
  - ELECTRIC

2. UNDERGROUND UTILITY INFORMATION SHOWN HEREON IS ONE OF SEVERAL POSSIBLE INTERPRETATIONS OF THE RECORD DATA AS PROVIDED BY THE RESPECTIVE SOURCES. ROGERS SURVEYING, PLLC ASSUMES NO RESPONSIBILITY FOR THE ACTUAL LOCATION, SIZE, AND DEPTH OF ANY UTILITY LINES. THE LOCATION AND DEPTH OF ALL UNDERGROUND UTILITIES MUST BE VERIFIED WITH THE RESPECTIVE UTILITY COMPANY OR AGENCY PRIOR TO ANY DESIGN AND CONSTRUCTION OR EXCAVATION.
  3. OVERHEAD ELECTRIC AND TELECOMMUNICATIONS SHOWN OBTAINED FROM FIELD SURVEY.
  4. SEWER INVERT INFORMATION ARE AS PER DATA COLLECTED IN THE FIELD UNLESS OTHERWISE INDICATED.

**UTILITY CONTACT INFO:**

- |    |                                   |  |
|----|-----------------------------------|--|
| 1. | NATURAL GAS                       | PSE&G - CHARLES MIRACOLA JR. (908) 412-2215 - CHARLES.MIRACOLAJR@PSEG.COM    |
| 2. | ELECTRIC                          | PSE&G - CHARLES MIRACOLA JR. (908) 412-2215 - CHARLES.MIRACOLAJR@PSEG.COM    |
| 3. | UNDERGROUND FIBER OPTIC / TELECOM | VERIZON - KRZYSZTOF OGRODNIK (732) 874-6189 - KRZYSZTOF.OGRODNIK@VERIZON.COM |
| 4. | OVERHEAD FIBER OPTIC / TELECOM    | VERIZON - KRZYSZTOF OGRODNIK (732) 874-6189 - KRZYSZTOF.OGRODNIK@VERIZON.COM |
| 5. | OVERHEAD CABLE                    |  |
| 6. | WATER                             | JCMUA - RICHARD HAYTAS (201) 432-1150 - R.HAYTAS@JCMUA.COM                   |
| 7. | SANITARY SEWER                    | JCMUA - RICHARD HAYTAS (201) 432-1150 - R.HAYTAS@JCMUA.COM                   |
| 8. | STORMWATER (NJDEP PARCELS)        | LSP - BRIAN SHANKLE (201) 915-3400 x 105 - CHARLES.SHANKLE@NJDEP.NJ.GOV      |

## REFERENCE NOTES:

1. DEED BOOK 3003 PAGES 943-946
  2. MAP ENTITLED "SKETCH OF PROPERTY OF PROPOSED JOB CORPS SITE, SITUATED IN JERSEY CITY, HUDSON COUNTY, NEW JERSEY, PREPARED FOR DEPARTMENT OF CONSERVATION AND ECONOMIC DEVELOPMENT, BY VAN NOTE - HARVEY ASSOC., PRINCETON, NJ., SCALE 1"=200' DATED JULY, 1965

WETLAND DELINEATION NOTES:

1. THE DELINEATION OF WATERS OF THE UNITED STATES, INCLUDING WETLANDS, AT THE SITE WAS PERFORMED BY PRINCETON HYDRO IN APRIL AND AUGUST 2019.
  2. THE DELINEATION WAS BASED ON THE METHODS AND PROCEDURES SET FORTH IN THE 1987 MANUAL AND THE NCNE REGIONAL SUPPLEMENT. THE 1987 MANUAL'S ROUTINE ON-SITE DETERMINATION METHOD WAS APPLIED FOR BOTH THE COLLECTION AND REVIEW OF EXISTING AVAILABLE BACKGROUND INFORMATION ON VEGETATION, SOILS, AND HYDROLOGY, AS WELL AS THE ON-SITE DELINEATION. SUPPLEMENTAL INFORMATION WAS PROVIDED BY THE NCNE REGIONAL SUPPLEMENT.

**TIDAL DATUM NOTES:**

1. TIDAL DATUMS WERE CALCULATED BY PRINCETON HYDRO, BASED UPON WATER LEVEL MONITORING IN THE NORTH COVE, AND USING THE NOAA CENTER FOR OPERATIONAL OCEANOGRAPHIC PRODUCTS AND SERVICES (CO-OPS) TIDAL ANALYSIS DATUM CALCULATOR.
  2. NORTH COVE WATER LEVEL MONITORING WAS PERFORMED FROM APRIL 12, 2019 TO JULY 11, 2019, COLLECTED AT 6-MINUTE INTERVALS.
  3. THE SHORT-TERM NORTH COVE WATER LEVEL DATA WAS CALIBRATED AGAINST LONG-TERM DATA OBTAINED FROM NATIONAL OCEANIC AND ATMOSPHERIC ADMINISTRATION (NOAA) TIDE GAUGE AT THE BATTERY, NY (STATION ID: 8518750; TIDAL EPOCH 1983-2001), LOCATED ACROSS THE HUDSON RIVER IN MANHATTAN APPROXIMATELY 1.5 MILES FROM NORTH COVE.
  4. TIDAL DATUM CALCULATED FOR 1983-2001 TIDAL EPOCH WERE PROJECTED TO THE 2001 - 2019 TIDAL EPOCH TO ACCOUNT FOR SEA LEVEL CHANGE. SEA LEVEL CHANGE VALUES WERE OBTAINED FROM REPORT TITLED *NEW JERSEY'S RISING SEAS AND CHANGING COASTAL STORMS: REPORT OF THE 2019 SCIENCE AND TECHNICAL ADVISORY PANEL*, WHICH REPORTED 0.3 FEET OF SEA LEVEL RISE IN NEW JERSEY BETWEEN THE TWO TIDAL EPOCHS.

CIVIL ABBREVIATIONS	
ALUM	ALUMINUM
B.L.	BASELINE
BLDG.	BUILDING
C.L.	CENTERLINE
CULV.	CULVERT
DIA.	DIAMETER
DND	DO NOT DISTURB
EL.	ELEVATION
ELEV.	ELEVATION
EXT.	EXTERIOR
F.L.	FLOW LINE
FT.	FEET
HMA	HOT MIX ASPHALT
HORIZ.	HORIZONTAL
HP	HIGH POINT
INV.	INVERT
LBS	POUNDS
LF	LINEAR FEET
LP	LOW POINT
MRF	MANUFACTURER
MAX.	MAXIMUM
MIN.	MINIMUM
N.T.S	NOT TO SCALE
O.C.	ON CENTER
P.C.	POINT OF CURVATURE
P.I.	POINT OF INTERSECTION
P.O.B.	POINT OF BEGINNING
P.O.E.	POINT OF END
P.T.	POINT OF TANGENCY
PVC	POLYVINYL CHLORIDE
R	RADIUS
RCP	REINFORCED CONCRETE PIPE
RECP	ROLLED EROSION CONTROL PRODUCT
RELOC.	RELOCATED
R.O.W.	RIGHT OF WAY
SEC.	SECOND
SF	SQUARE FEET
SQ.FT.	SQUARE FEET
STA.	STATION
TBR	TO BE REMOVED
T.O.W.	TOP OF WALL
TRM	TURF REINFORCEMENT MAT
TYP.	TYPICAL
VERY.	VERTICAL



CAS	JANUARY 2023	
DRAWN BY:	SOLICITATION NO.:	
CAS	W912DS-19-F-0011	
CHECKED BY:	CONTRACT NO.:	
JH/CP	W912DS-14-D-0001	
SUBMITTED BY:		
PH/HDR		
SIZE:	ANSI D	

**LIBERTY STATE PARK  
ECOSYSTEM RESTORATION PROJECT  
HUDSON COUNTY, NEW JERSEY**

PHOTOGRAMMETRIC SURVEY CONTROL

PHOTOGRAMMETRIC SURVEY CONTROL			
NORTHING	EASTING	ELEV.	DESC.
681612.577	612704.430	11.91	CP-01
681649.145	613890.52	21.15	CP-02
683095.211	614662.647	13.86	CP-03
683968.539	615607.066	8.95	CP-04
683910.452	616462.082	6.15	CP-05
683677.485	617339.044	6.56	CP-06
683485.223	618527.894	5.42	CP-07
683331.149	619590.006	5.36	CP-08
681992.618	619064.024	9.56	CP-09
681027.928	616647.015	7.53	CP-10
679731.698	616345.271	7.77	CP-11
679974.125	615530.067	6.03	CP-12
680505.423	614644.622	7.63	CP-13
680856.999	614063.900	6.81	CP-14
681304.596	613385.797	5.39	CP-15
681873.712	615322.539	7.42	CP-16
682902.642	615547.246	9.80	CP-17
682917.699	616571.939	8.09	CP-18
681441.990	616082.564	7.01	CP-19
682840.284	617753.260	8.62	CP-20
681362.496	618047.005	8.44	CP-21
681521.153	614644.065	7.64	CP-22
682105.038	616876.285	9.49	CP-23
682577.821	619519.366	8.35	CP-24
683174.118	620052.147	5.87	CP-25

#### **MATUMS AT THE NORTH COVE:**

TIDAL DATUM	WATER SURFACE ELEVATION ** (NAVD88 FEET)
MEAN HIGH WATER SPRING (MHWS)*	3.89
MEAN HIGHER HIGH WATER (MHHW)	2.68
MEAN HIGH WATER (MHW)	2.38
MEAN TIDE LEVEL (MTL)	0.16
MEAN LOW WATER (MLW)	-2.06
MEAN LOWER LOW WATER (MLLW)	-2.29

\*EFFECT TIME PERIOD ONLY, DOES NOT ACCOUNT FOR LONG TERM DATA.  
\*\*ELEVATIONS ARE REFERENCED TO THE 2001 TO 2020 TIDAL EPOCH (2010 BASELINE).

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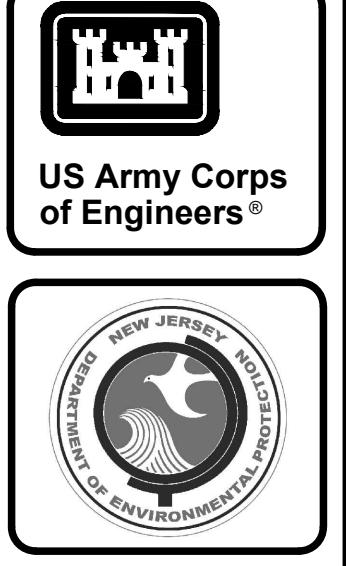
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THIS KEY MAP APPLIES TO THE FOLLOWING DRAWING SERIES:

X-JD-101 TO 124 - APPROVED JURISDICTIONAL DETERMINATION PLAN

EXISTING CONDITIONS LEGEND	
	FENCE
	TREE LINE
	BRUSH LINE
	GUIDERAIL
	PROPERTY LINE
	EXISTING STRUCTURE
	EXISTING RAILROAD
	EXISTING BENCH
	TREE



JURISDICTIONAL DETERMINATION LEGEND	
	PROJECT SITE LOCATION
	PROJECT SITE PROPERTY LINE
	STORMWATER PIPE
	WETLAND / WATERS FLAG
	WETLAND / WATERS LINE
	NON-JURISDICTIONAL WETLAND AREA
	JURISDICTIONAL WETLAND AREA
	NON-JURISDICTIONAL WATERS AREA
	JURISDICTIONAL WATERS AREA

PROJECT SITE LOCATION = 266.16 ACRES

WATERS ID	WATERS CLASS	ACRES	LINEAR FEET
<b>NON-JURISDICTIONAL WATERS</b>			
SA/SB/SC	ISOLATED WATERS	2.187	6,300
<b>JURISDICTIONAL WATERS</b>			
SD/SE/SZ	SEASONAL RELATIVELY PERMANENT WATERS (RPW)	1.907	3,100
SX/SY	SEASONAL RELATIVELY PERMANENT WATERS (RPW)	0.410	960
NORTH COVE	TRADITIONALLY NAVIGABLE WATERS (TNW)	1.080	180



WETLAND ID	WETLAND CLASS	ACRES
<b>NON-JURISDICTIONAL WETLANDS</b>		
WA	ISOLATED WETLAND	0.071
WB	ISOLATED WETLAND	0.525
WC	ISOLATED WETLAND	1.546
WE	ISOLATED WETLAND	0.027
WF	ISOLATED WETLAND	1.027
WG	ISOLATED WETLAND	0.205
WH	ISOLATED WETLAND	0.115
WJ	ISOLATED WETLAND	0.390
WK	ISOLATED WETLAND	0.115
WL	ISOLATED WETLAND	0.016
WM	ISOLATED WETLAND	0.017
WN	ISOLATED WETLAND	0.998
WP	ISOLATED WETLAND	0.763
WQ	ISOLATED WETLAND	0.026
WR	ISOLATED WETLAND	0.021
WS	ISOLATED WETLAND	0.059
WT	ISOLATED WETLAND	0.321
WU	ISOLATED WETLAND	0.051
WW	ISOLATED WETLAND	0.032
WXX	ISOLATED WETLAND	1.222
WY	ISOLATED WETLAND	0.273
WZ	ISOLATED WETLAND	3.535
WAA	ISOLATED WETLAND	0.156
WAB	ISOLATED WETLAND	0.112
WAC/WAD	ISOLATED WETLAND	2.103
WAE/WAF	ISOLATED WETLAND	2.210
WAG/WAH	ISOLATED WETLAND	2.319
<b>JURISDICTIONAL WETLANDS</b>		
WD	ISOLATED WETLAND	0.514

ISSUE DATE:	JANUARY 2023
CONTRACT NO.:	W912DS-19-F-0011
PRINCETON HYDRO	
MARK	DESCRIPTION

DESIGNED BY:	TH
DRAWN BY:	TH
CHECKED BY:	JHCP
SUBMITTED BY:	PRINCETON HYDRO
SIZE:	ANSI D

U.S. ARMY CORPS OF ENGINEERS NEW YORK DISTRICT	LIBERTY STATE PARK HUDSON COUNTY, NEW JERSEY
NJDEP OFFICE OF NATURAL RESOURCE RESTORATION	APPROVED JURISDICTIONAL DETERMINATION SUMMARY SHEET

SHEET ID	X-JD-100
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60% CONCEPT - NOT FOR CONSTRUCTION
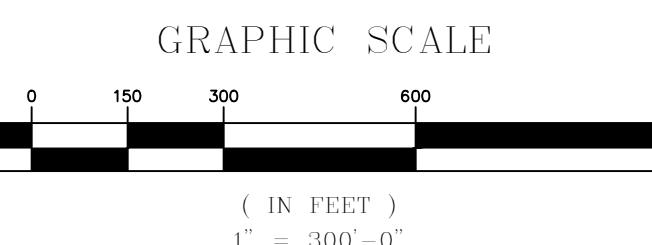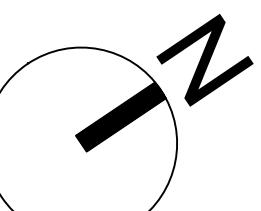
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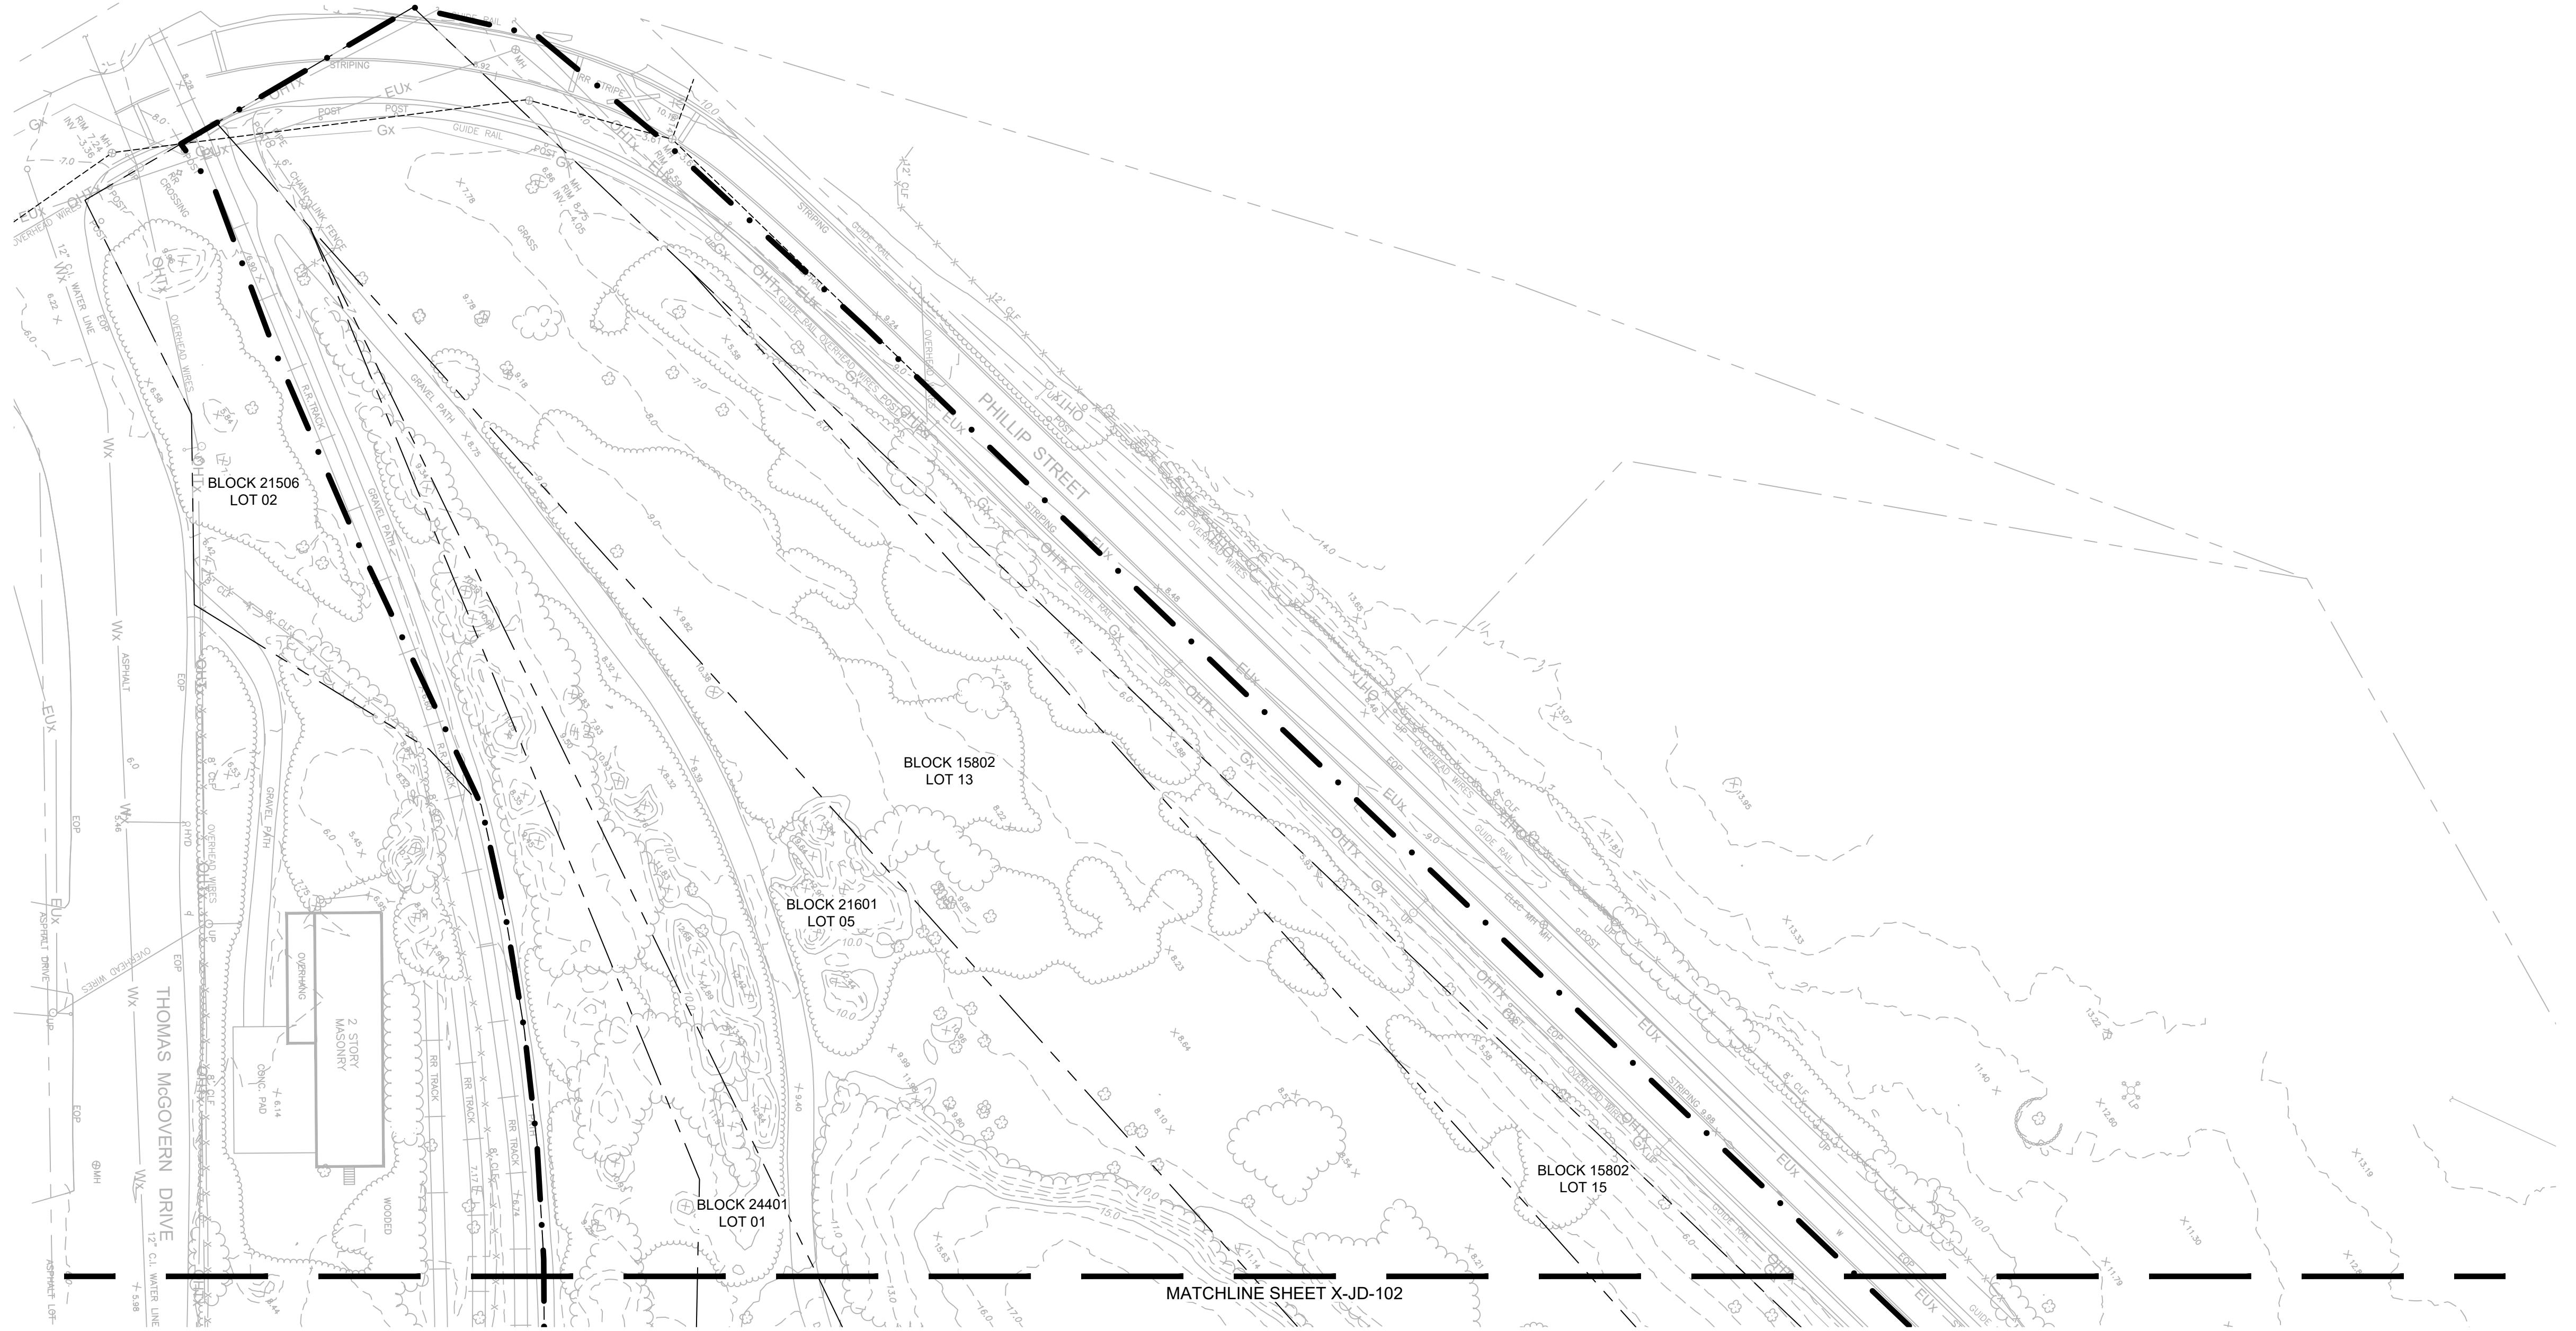
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## EXISTING CONDITIONS LEGEND


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2.0	MINOR CONTOUR EXISTING
9.05	GRADE SPOT ELEVATION
	STORM DRAINAGE PIPE
	WATER LINE
	SANITARY SEWER PIPE
	SANITARY FORCE MAIN
	GAS LINE
	OVERHEAD ELECTRIC
	UNDERGROUND ELECTRIC
	TELEPHONE LINE
	FENCE
	TREE LINE
	BRUSH LINE
	GUIDERAIL
	PROPERTY LINE
	EXISTING STRUCTURE
	EXISTING RAILROAD
	EXISTING BENCH
	TREE
UP/LP  LP	UTILITY/LIGHT POLE
V  WV	WATER VALVE
	HYDRANT
MH	UTILITY MANHOLE
CB	STORM INLET
FP	FLAG POLE
U	UTILITY VAULT
JB	UTILITY JUNCTION BOX
GV	GAS VALVE
	SIGN

JURISDICTIONAL DETERMINATION LEGEND


	PROJECT SITE LOCATION
	PROJECT SITE PROPERTY LINE
	STORMWATER PIPE
	TIDAL DATUM LIMIT
X WA-01	WETLAND / WATERS FLAG
	WETLAND / WATERS LINE
	NON-JURISDICTIONAL WETLAND AREA
	JURISDICTIONAL WETLAND AREA
	NON-JURISDICTIONAL WATERS AREA
	JURISDICTIONAL WATERS AREA

## KEY PLAN

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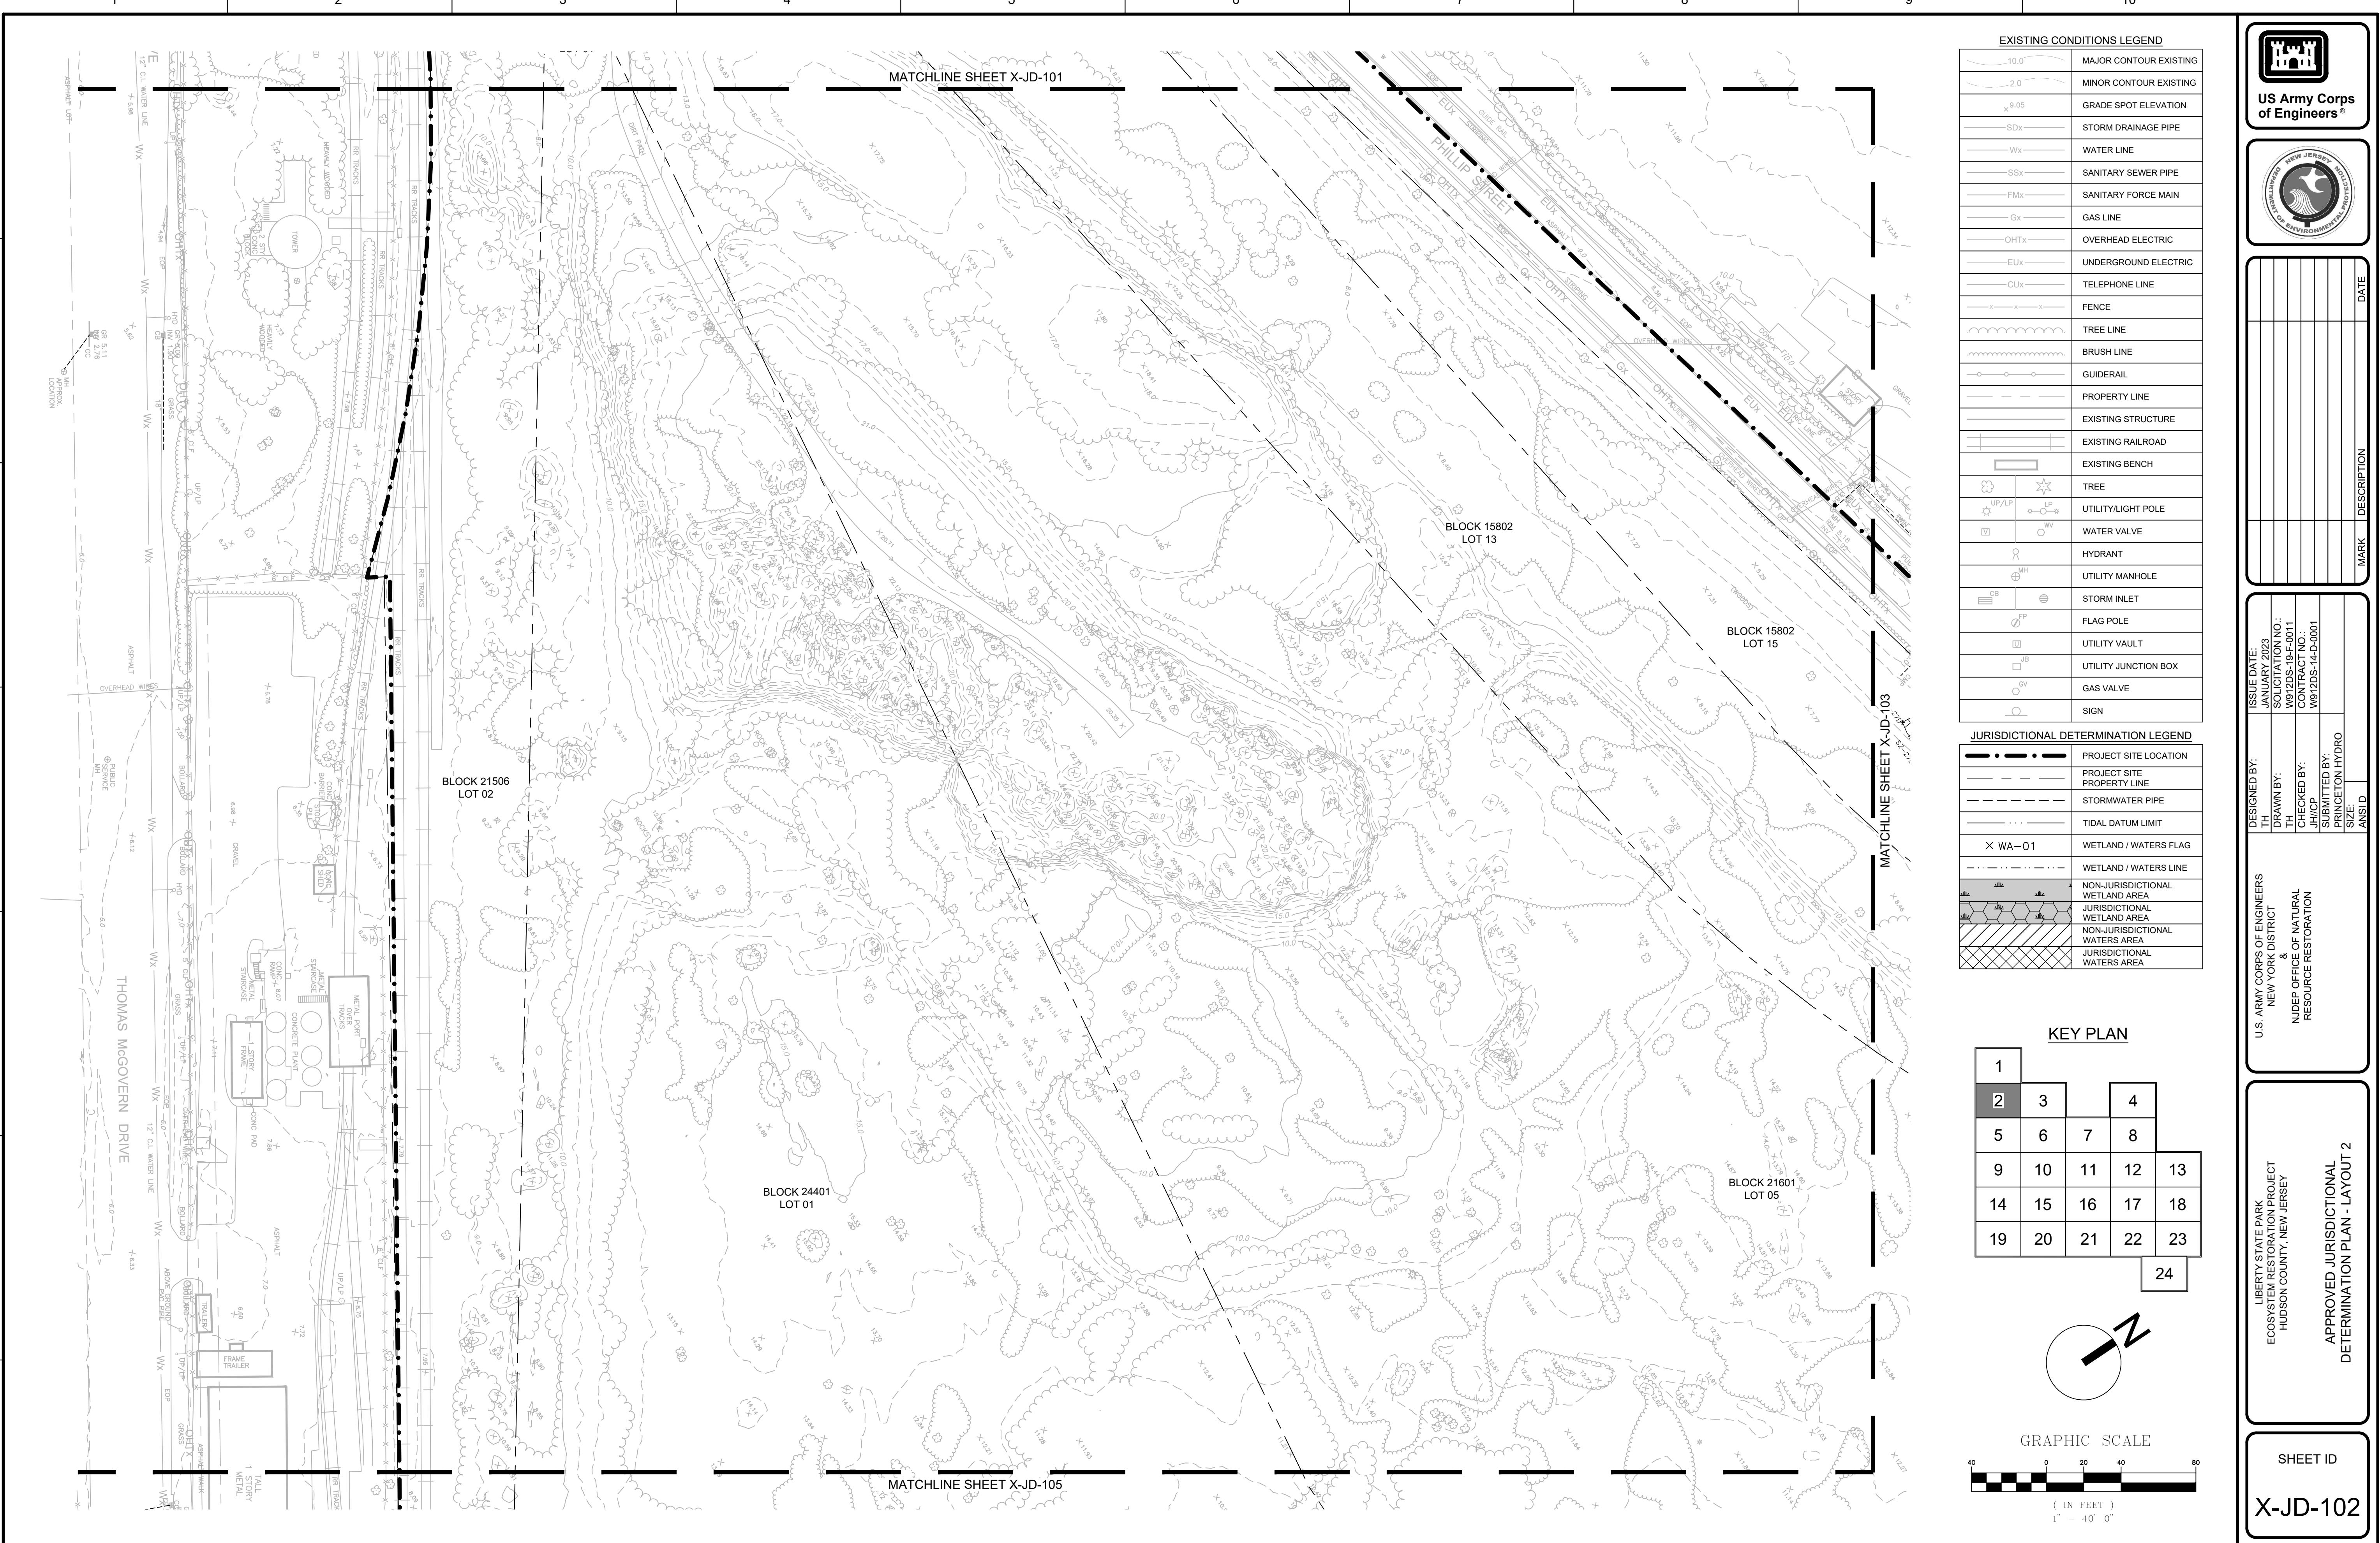
## GRAPHIC SCALE

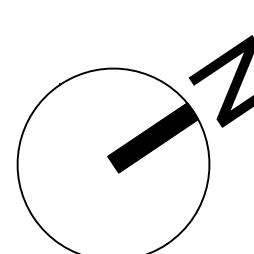

**U.S. ARMY CORPS OF ENGINEERS  
NEW YORK DISTRICT  
&  
NJDEP OFFICE OF NATURAL  
RESOURCE RESTORATION**

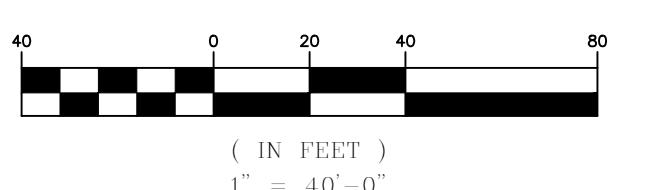**APPROVED JURISDICTIONAL  
DETERMINATION PLAN - LAYOUT 1**

SHEET ID  
**X-JD-101**



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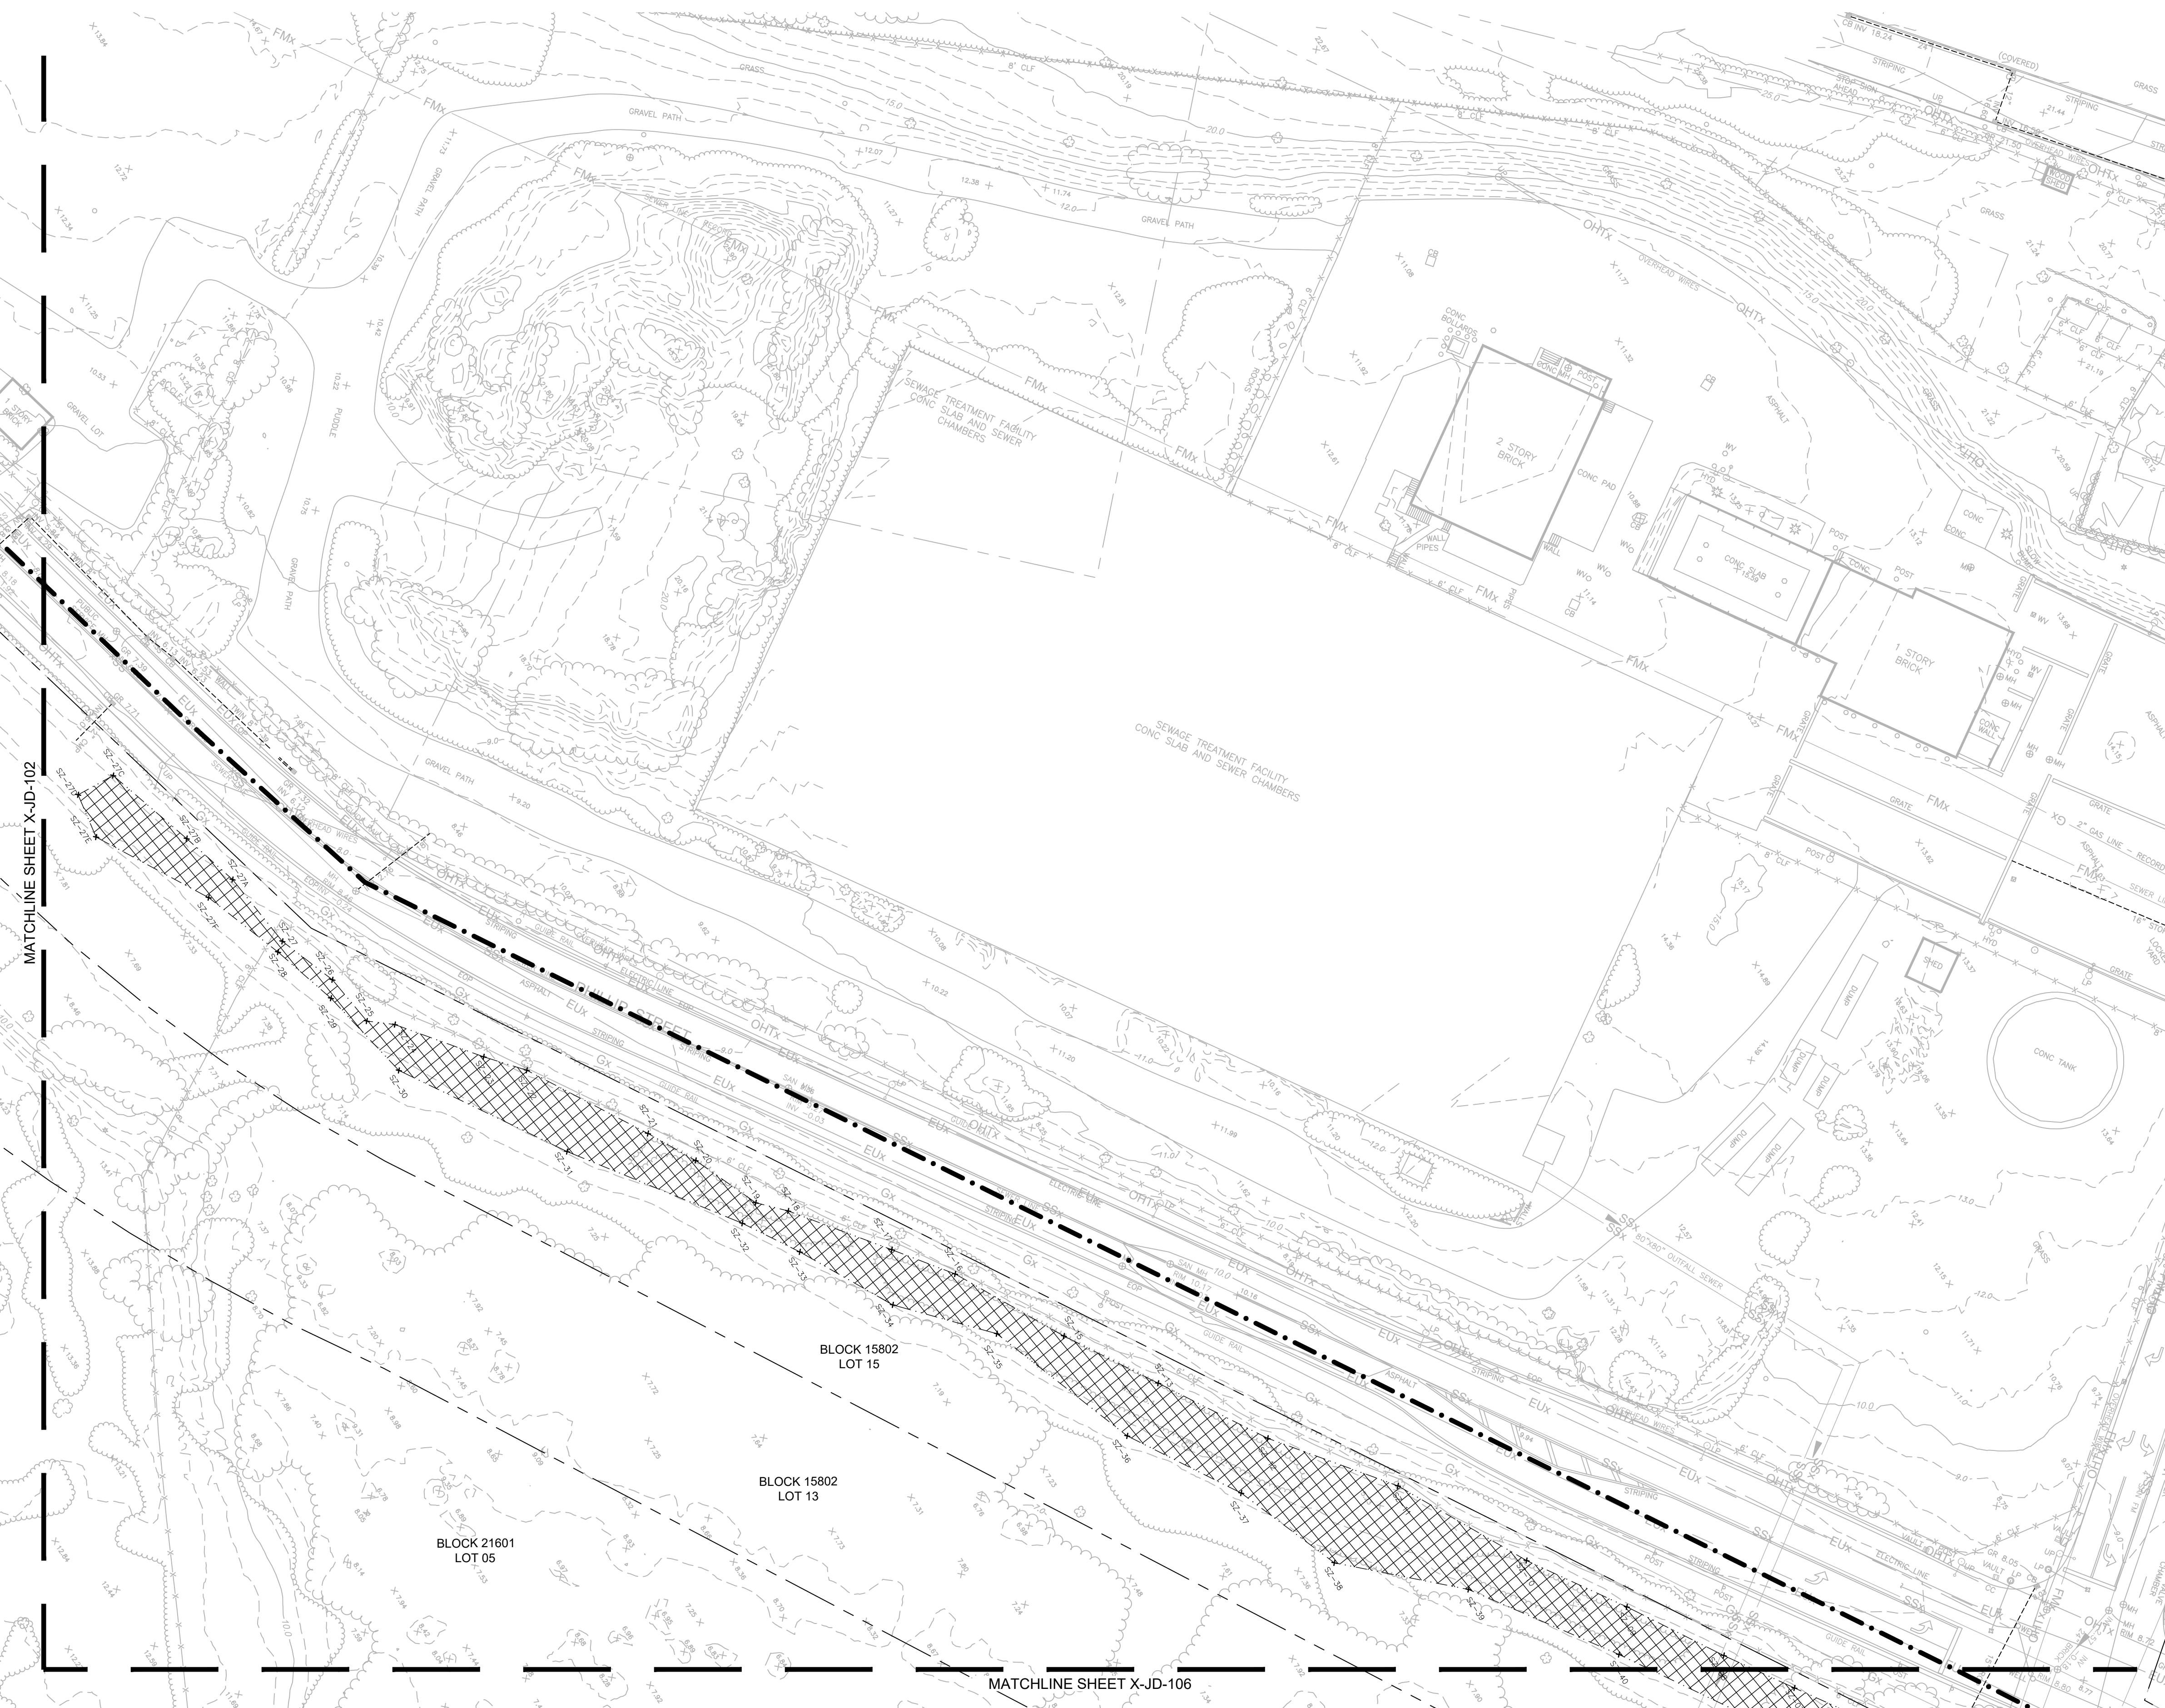
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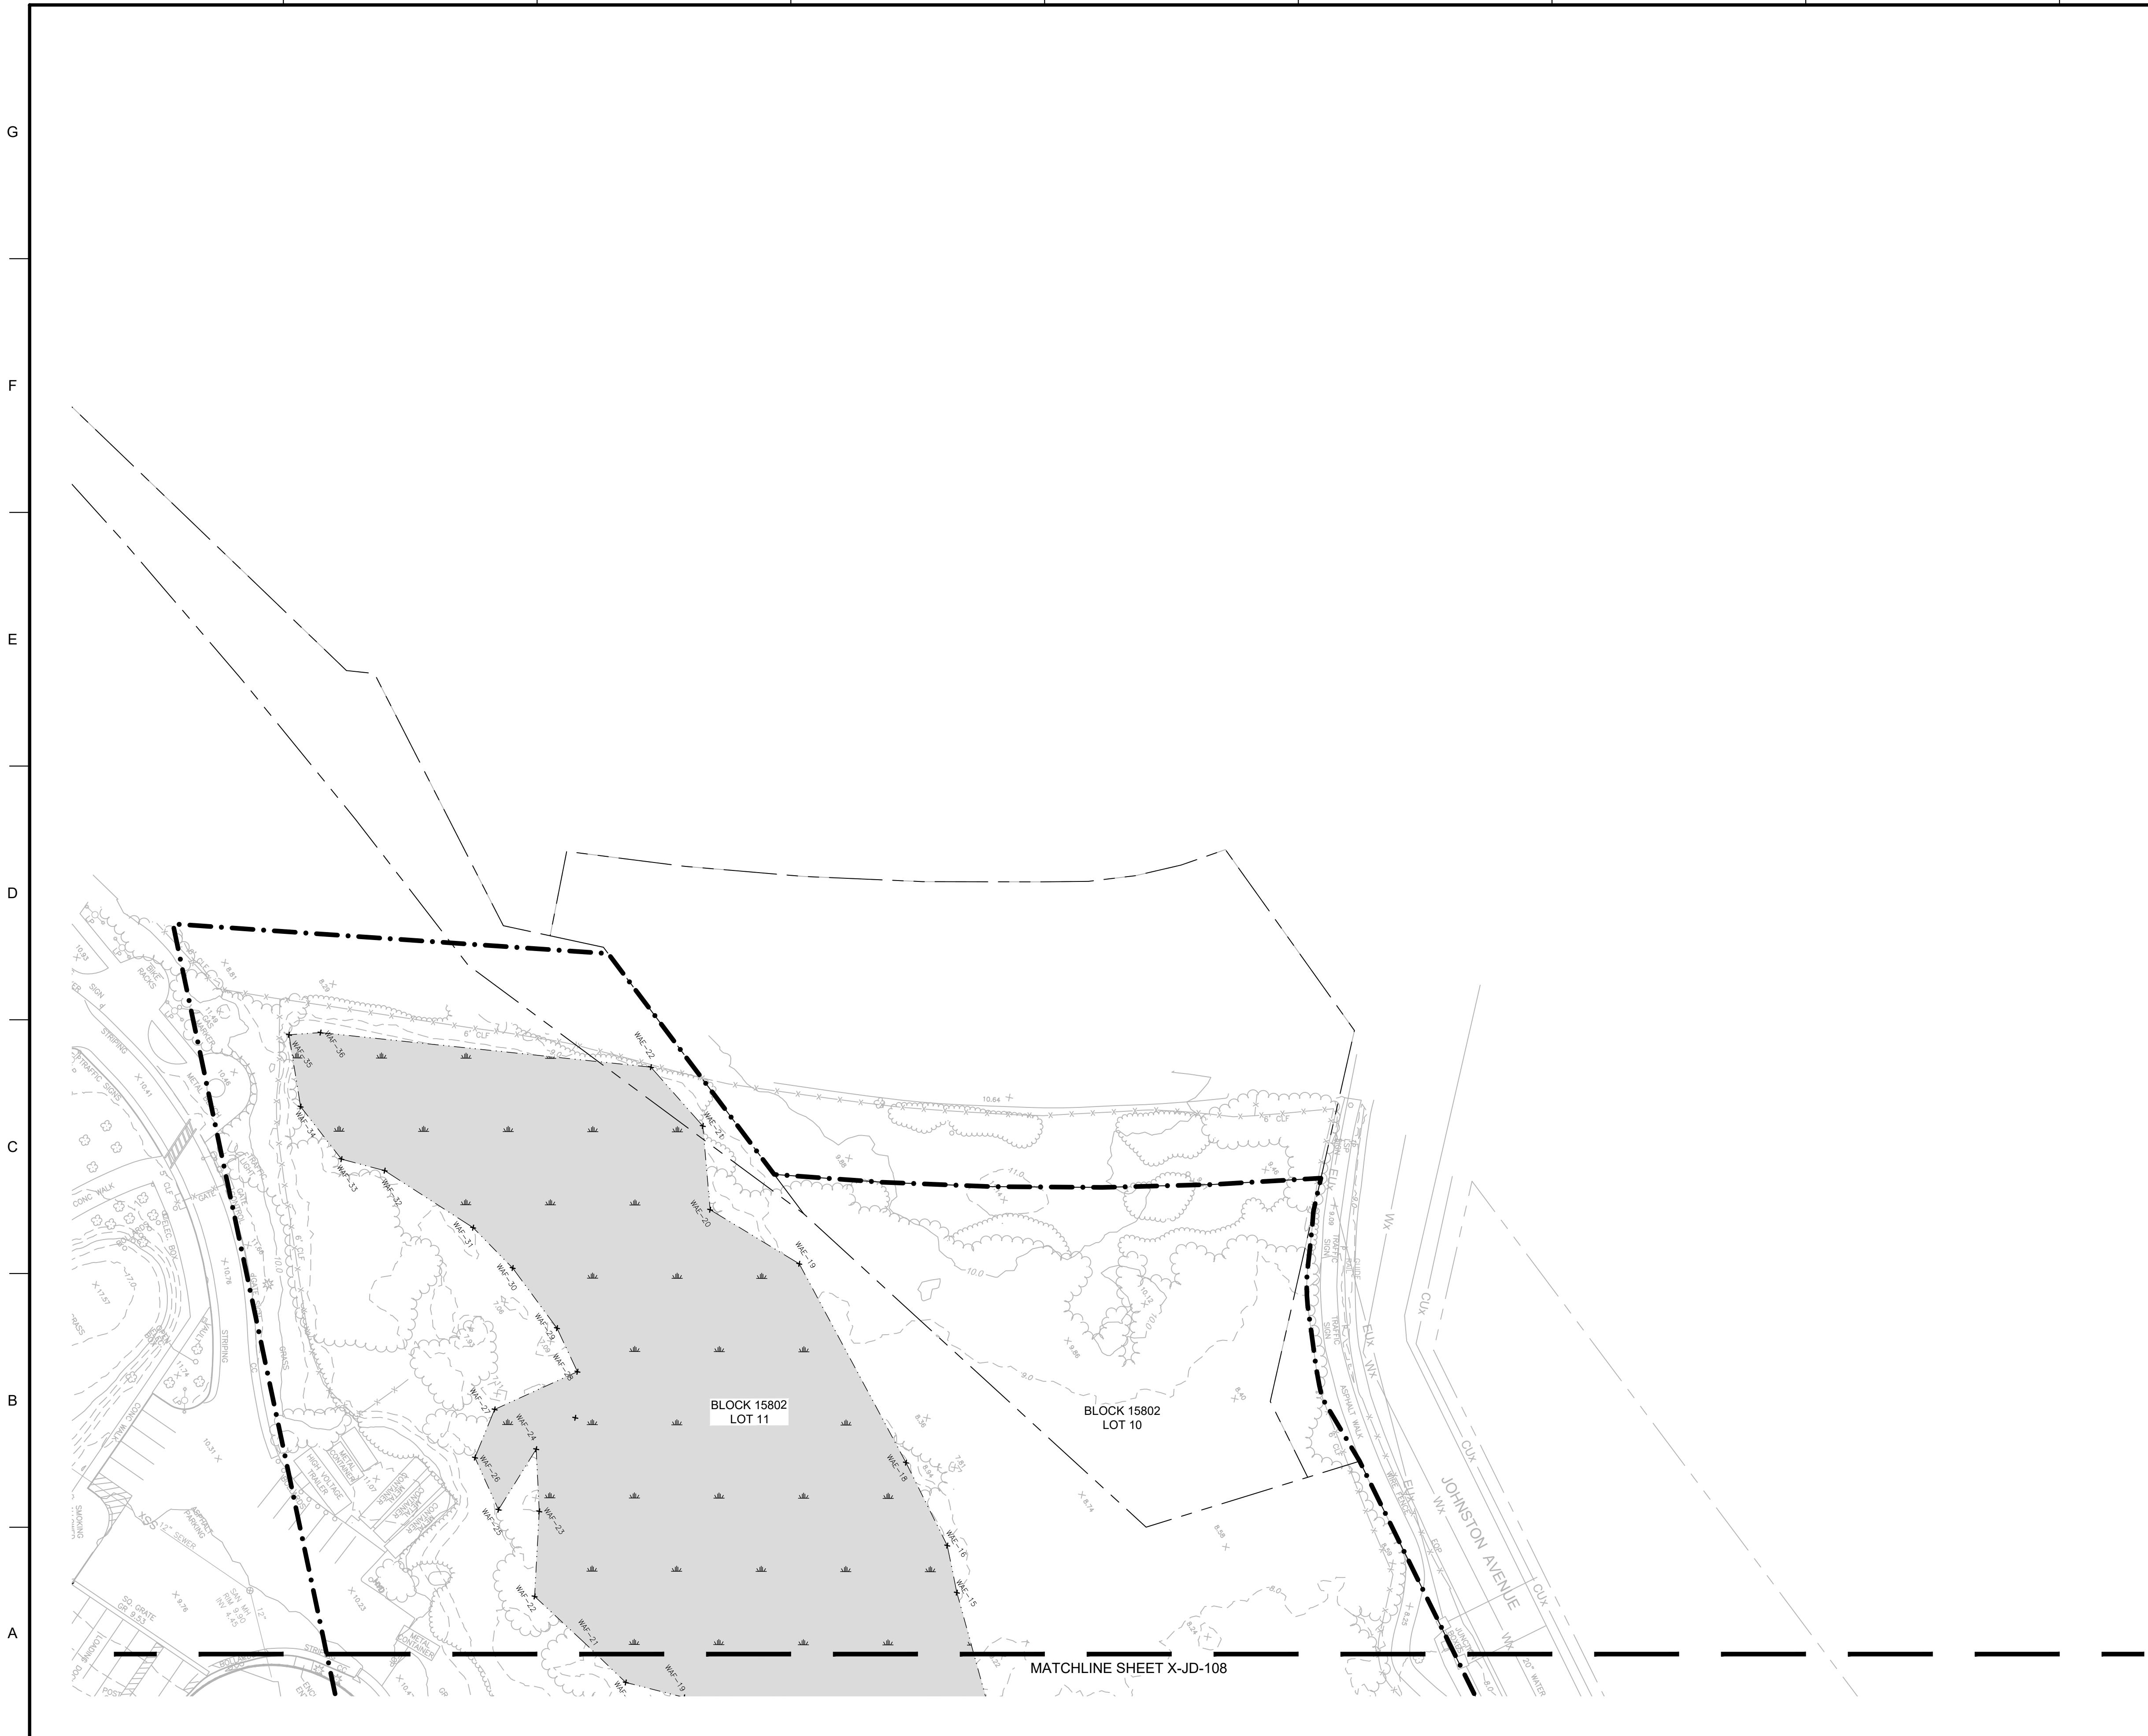
	US Army Corps of Engineers®
	DEPARTMENT OF ENVIRONMENTAL PROTECTION NEW JERSEY
DATE	

U.S. ARMY CORPS OF ENGINEERS NEW YORK DISTRICT	ISSUE DATE: JANUARY 2023
NJDEP OFFICE OF NATURAL RESOURCE RESTORATION	DRAWN BY: TH
	CHECKED BY: JH/CP
	SUBMITTED BY: PRINCETON HYDRO
SIZE: ANSI D	


LIBERTY STATE PARK  
ECOSYSTEM RESTORATION PROJECT  
HUDSON COUNTY, NEW JERSEY  
APPROVED JURISDICTIONAL  
DETERMINATION PLAN - LAYOUT 3

SHEET ID  
**X-JD-103**


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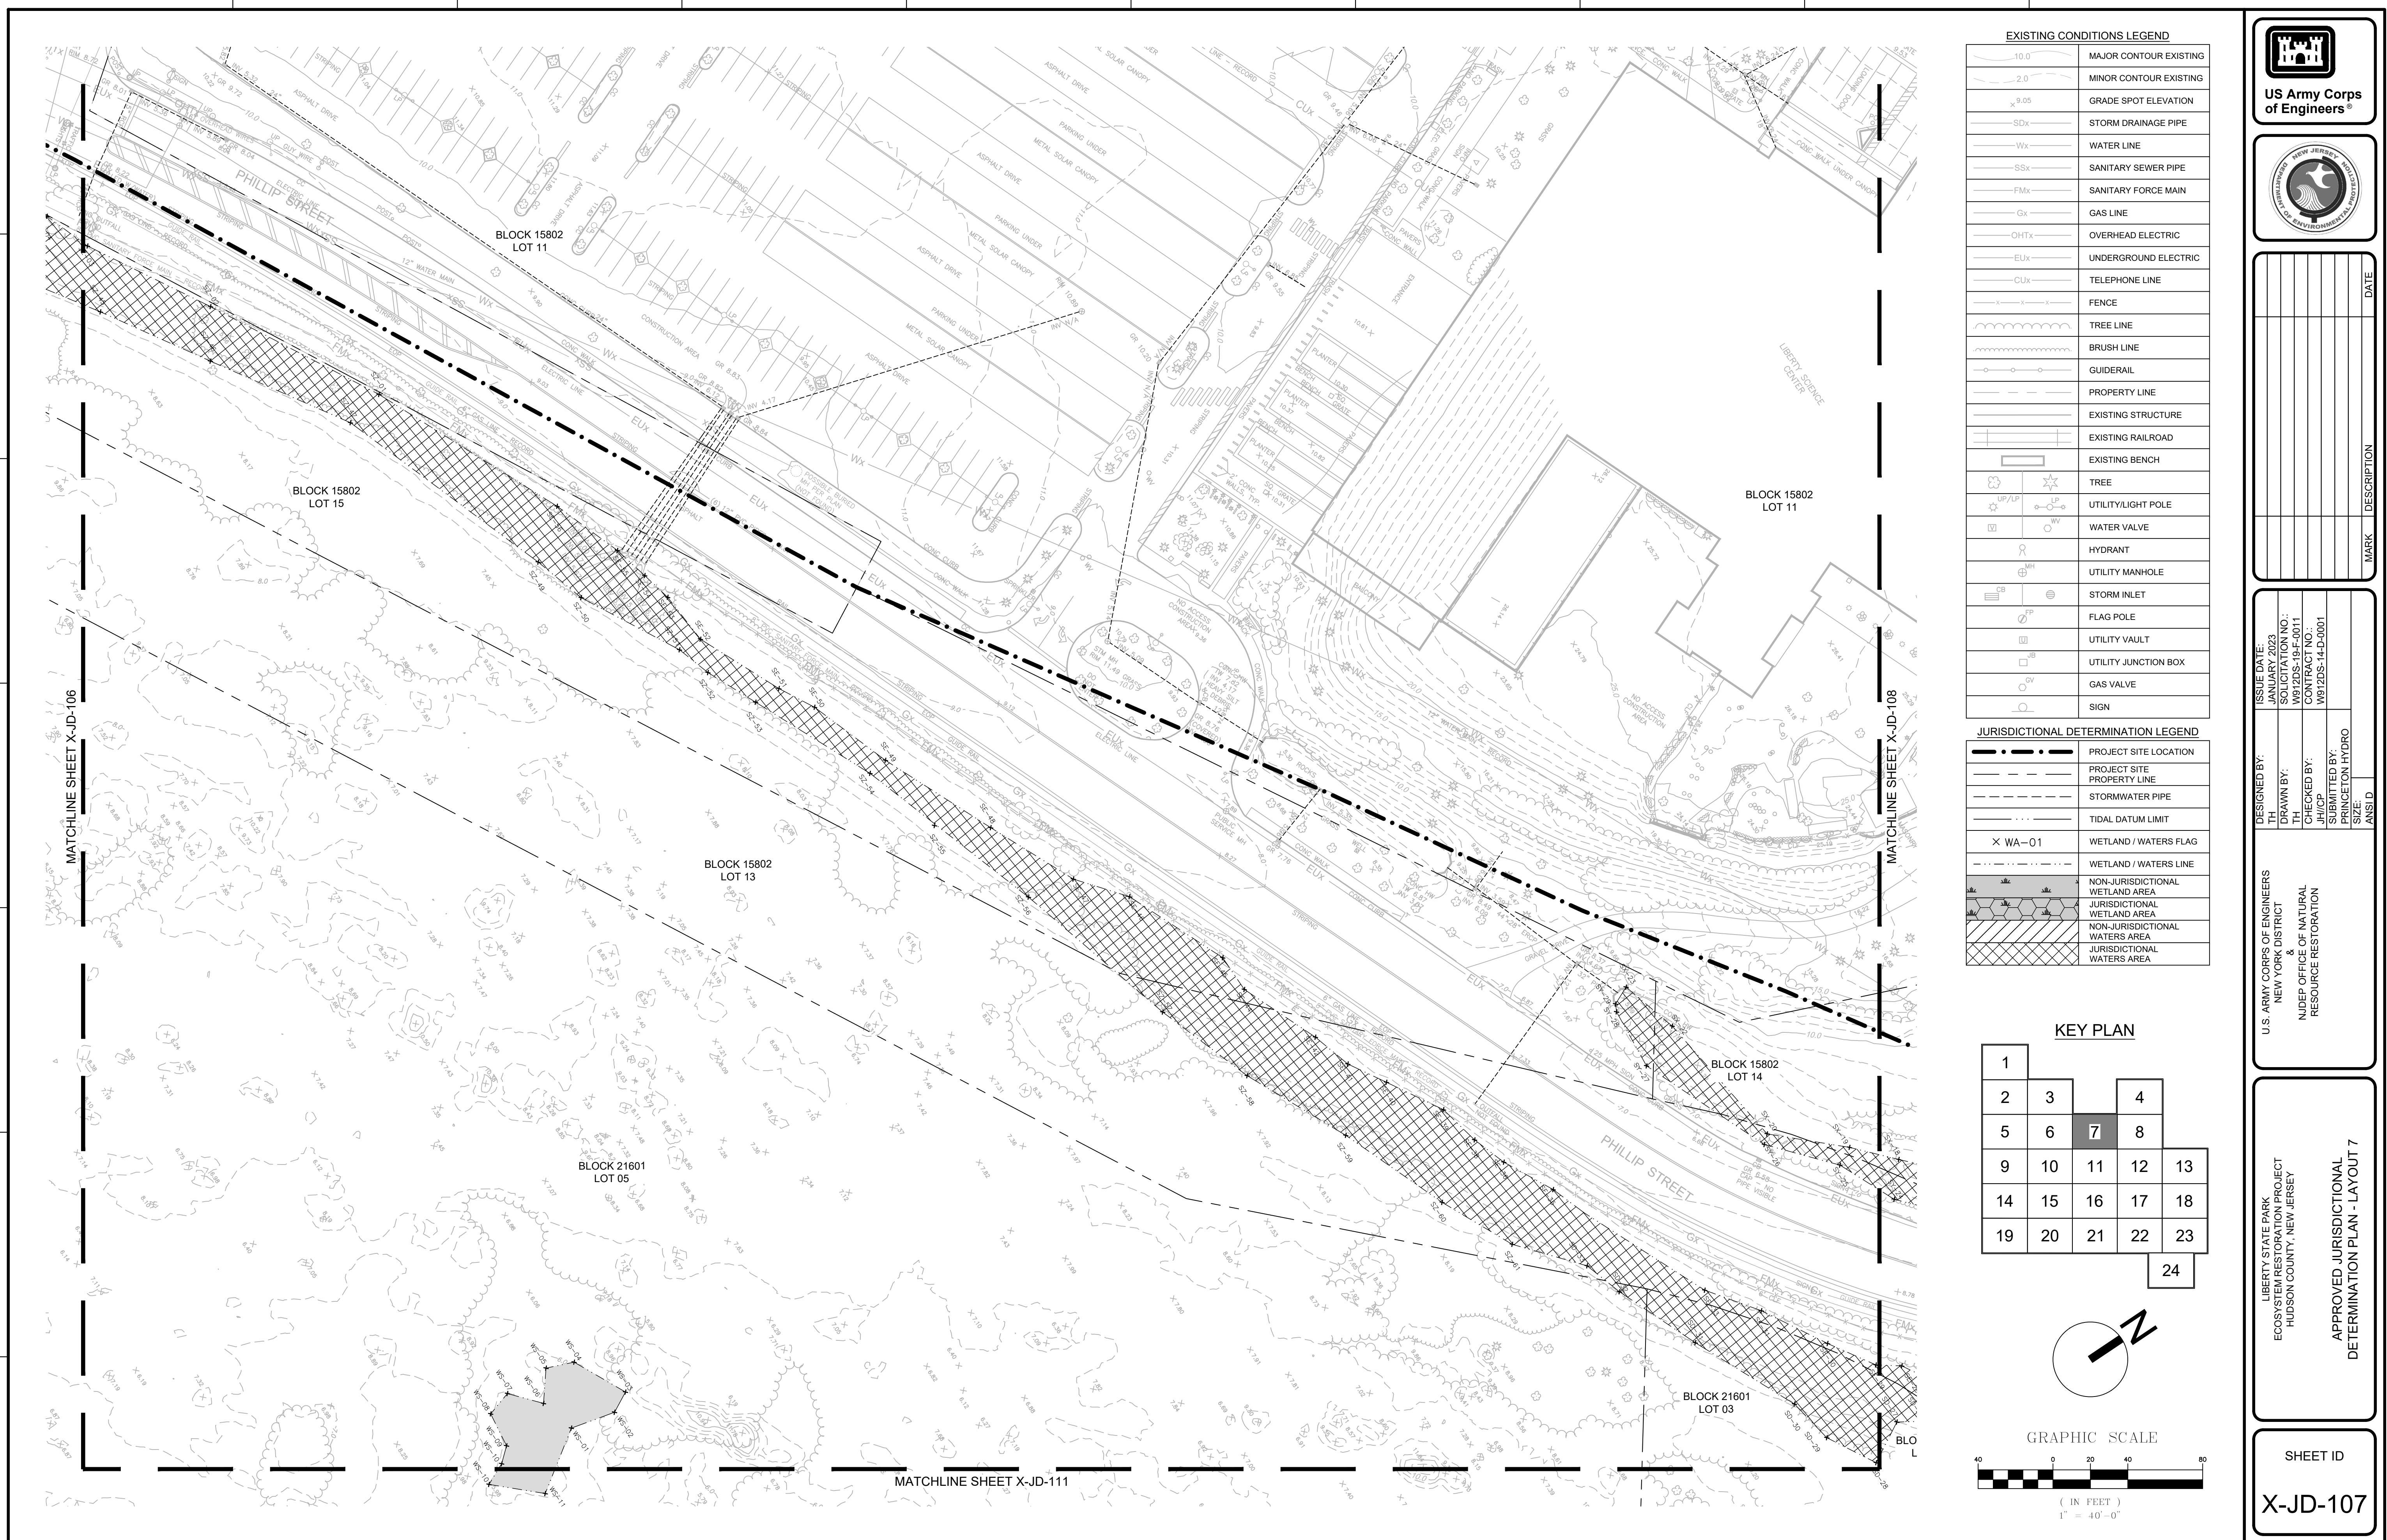
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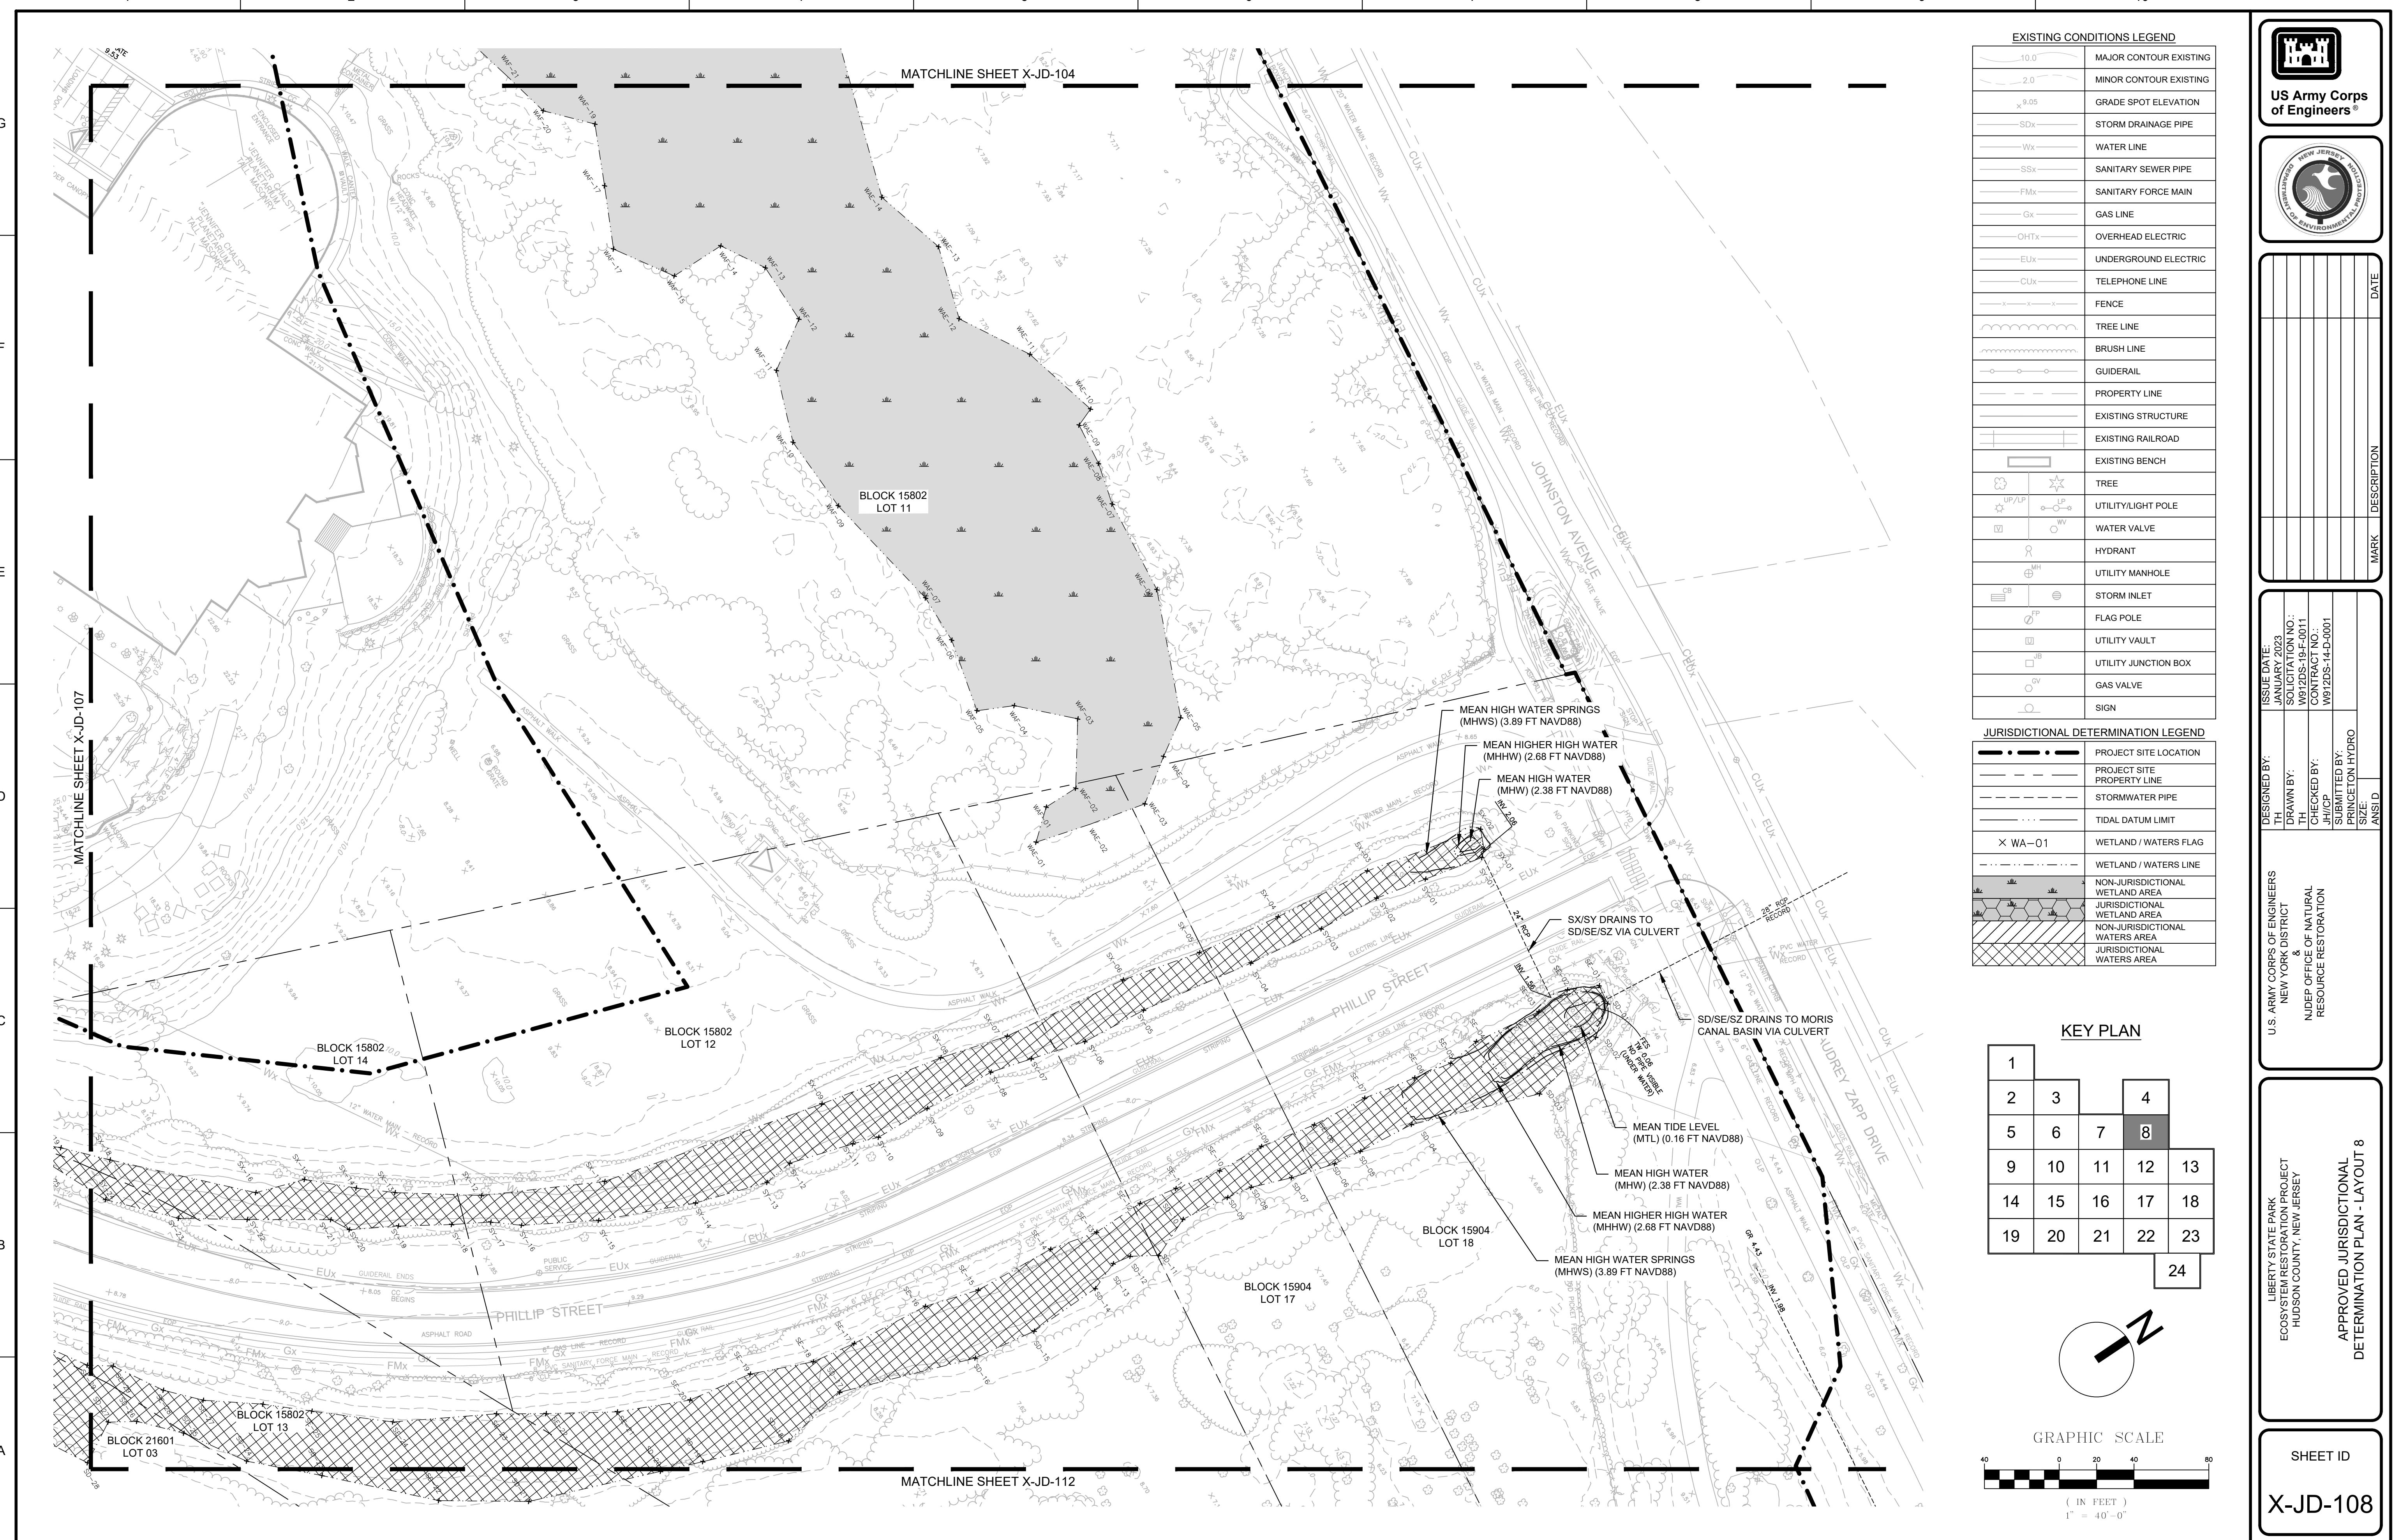


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MATCHLINE SHEET X-JD-105

MATCHLINE SHEET X-JD-114

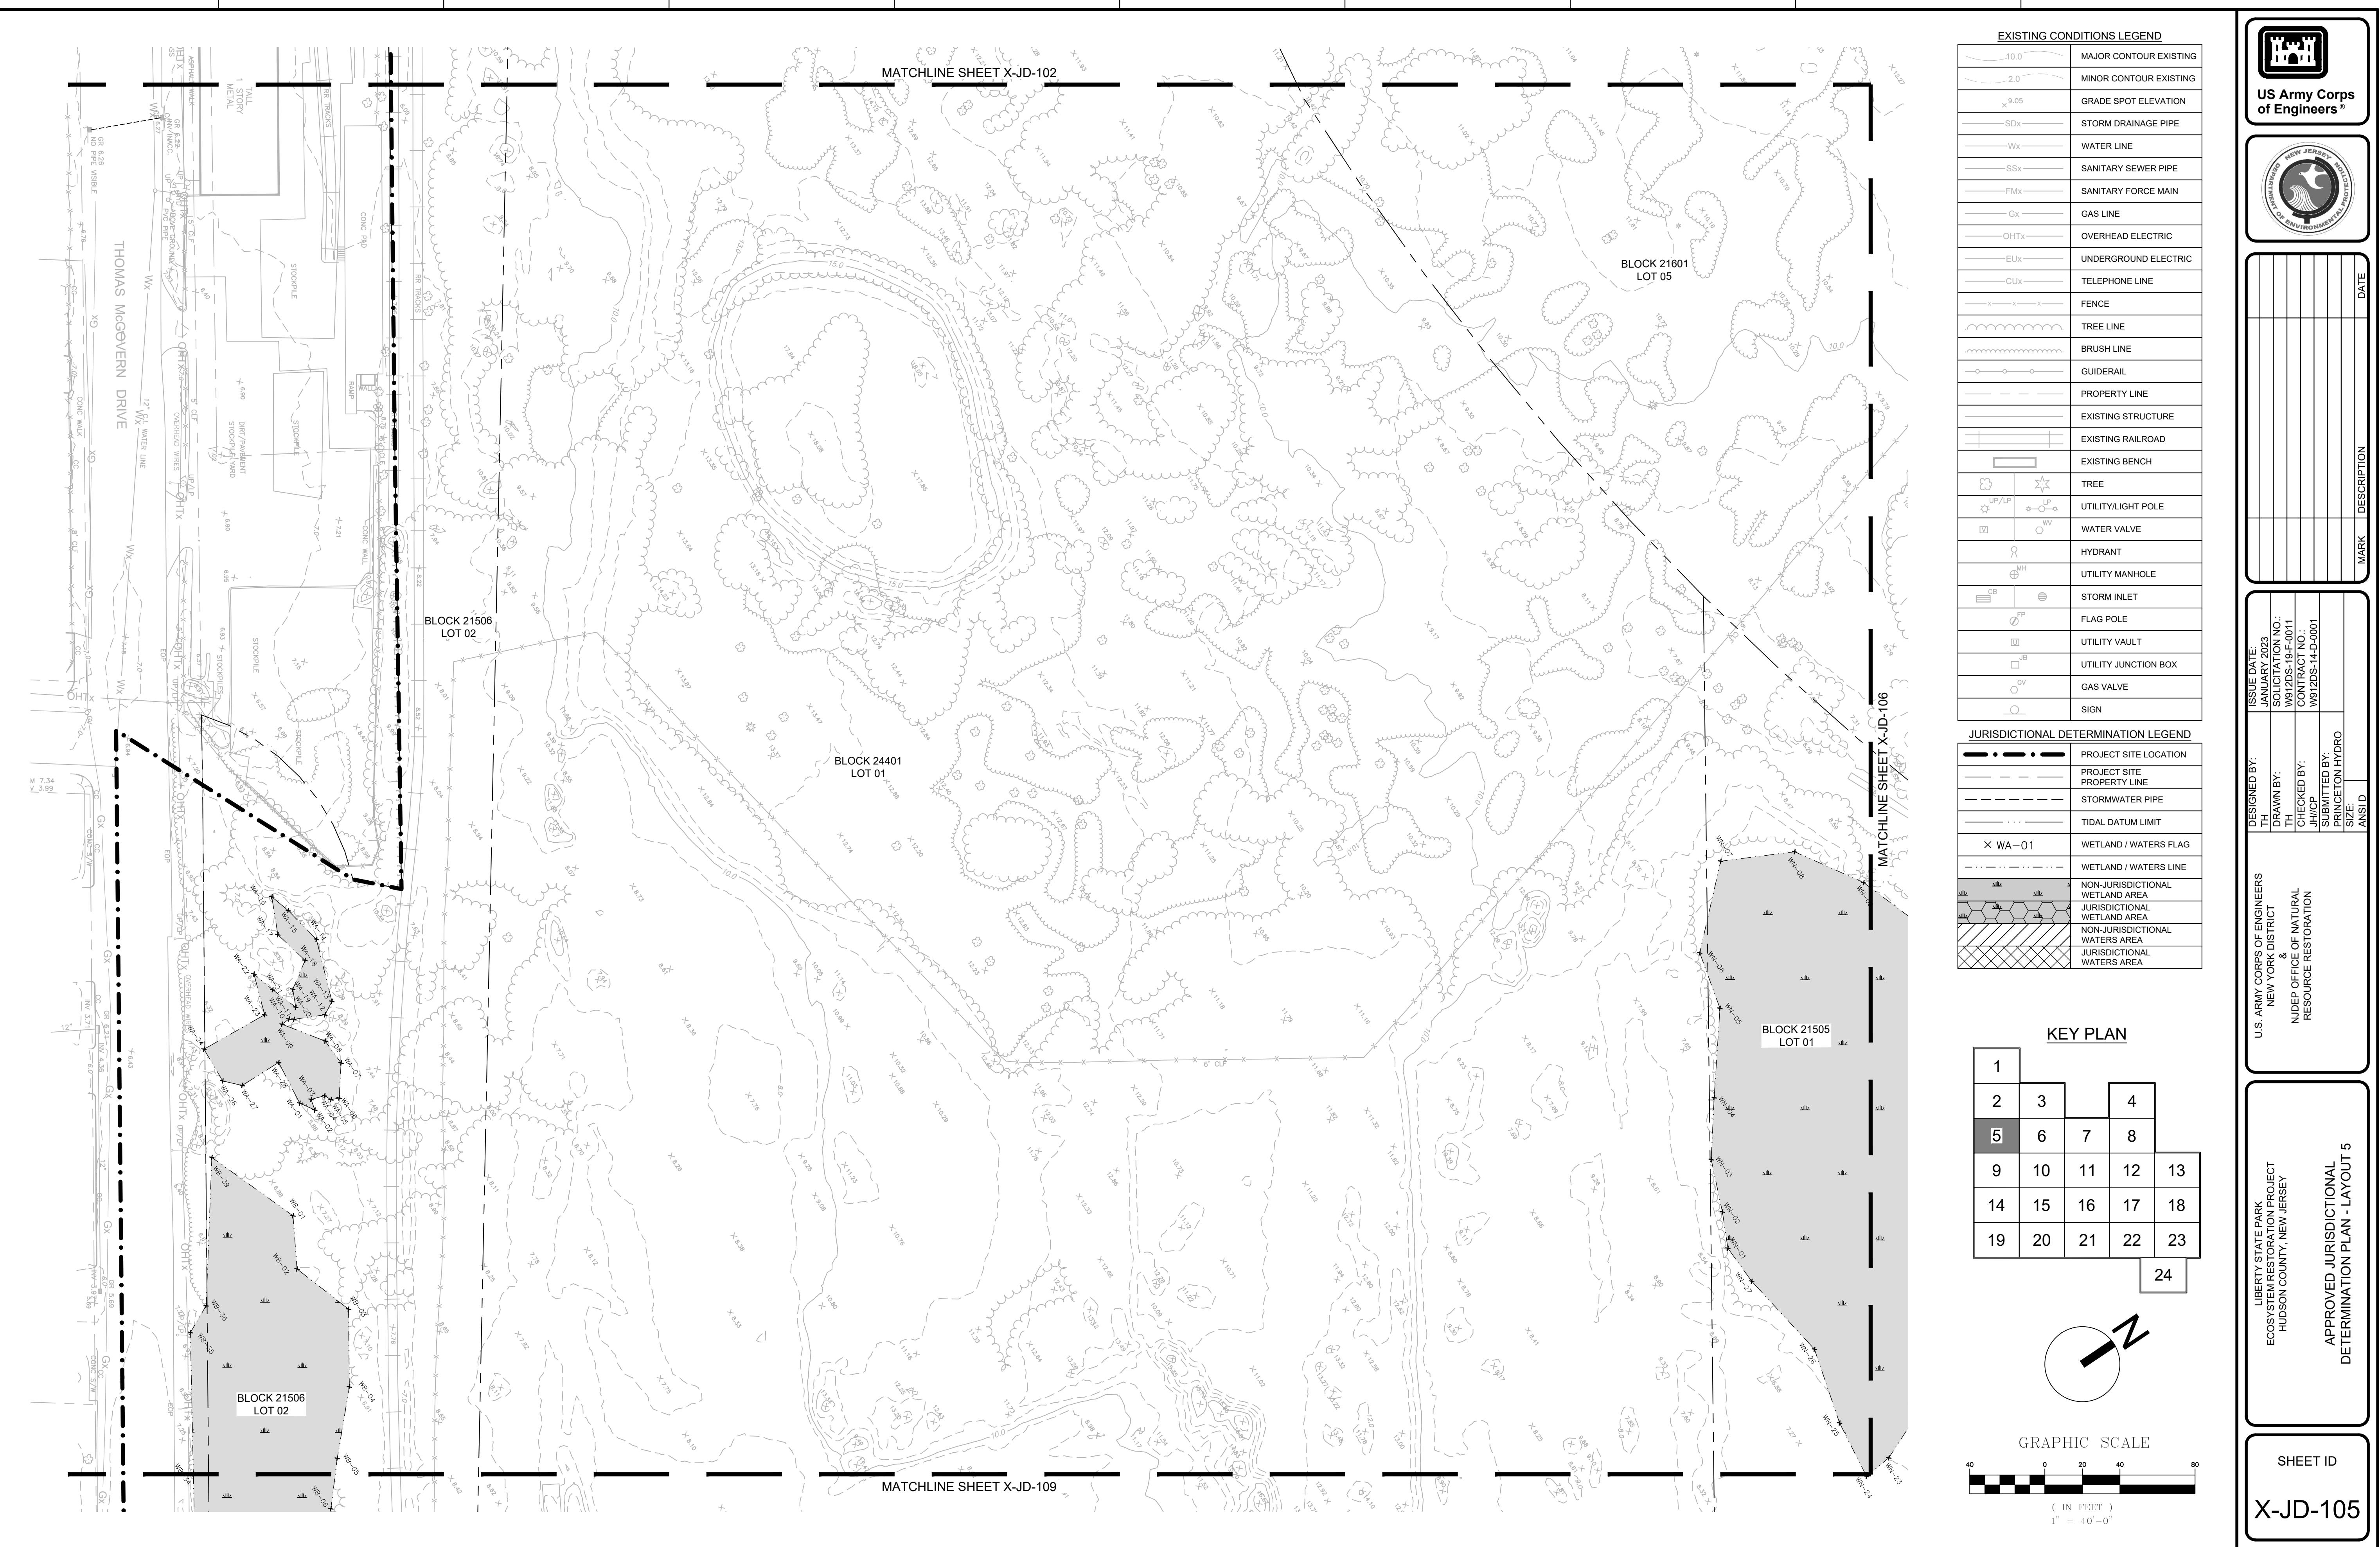BLOCK 21505  
LOT 01

BLOCK 21506  
LOT 01

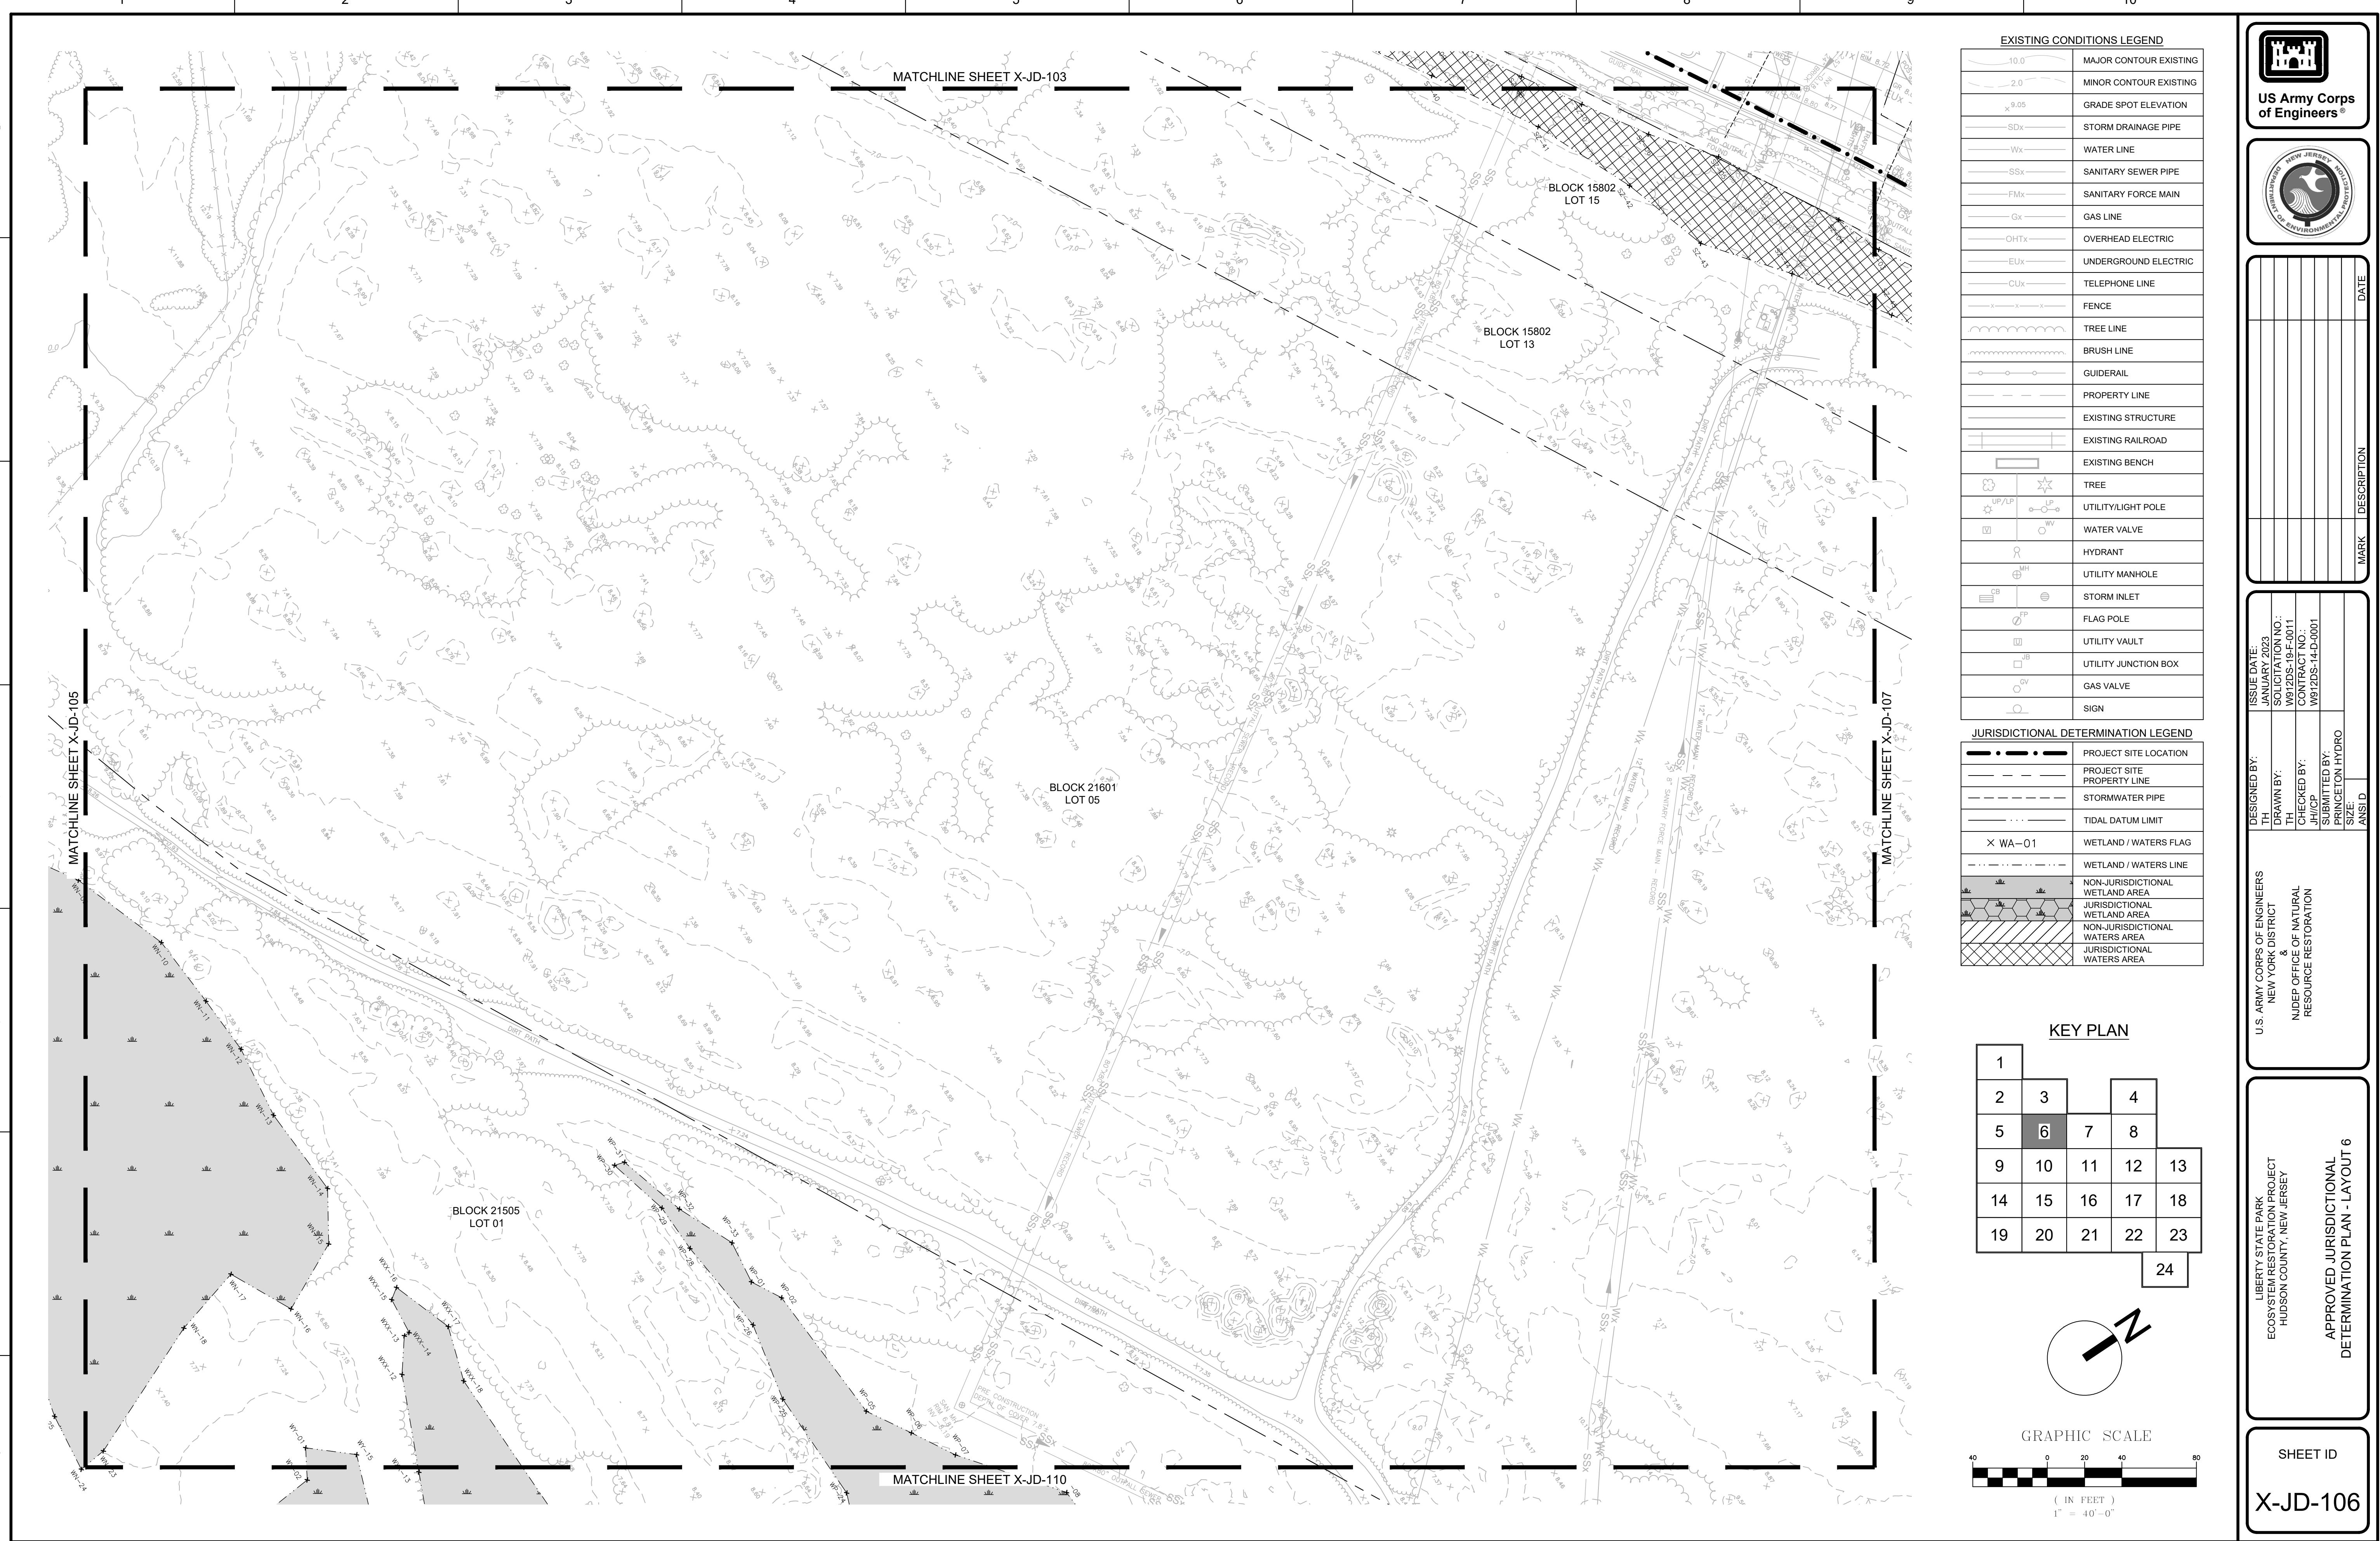BLOCK 21506  
LOT 02



MATCHLINE SHEET X-JD-110

EXISTING CONDITIONS LEGEND	
10.0	MAJOR CONTOUR EXISTING
2.0	MINOR CONTOUR EXISTING
x 0.05	GRADE SPOT ELEVATION
SDx	STORM DRAINAGE PIPE
Wx	WATER LINE
SSx	SANITARY SEWER PIPE
FMx	SANITARY FORCE MAIN
Gx	GAS LINE
OHTx	OVERHEAD ELECTRIC
EUX	UNDERGROUND ELECTRIC
CUX	TELEPHONE LINE
x-x-x	FENCE
Tree Line	TREE LINE
Brush Line	BRUSH LINE
Guiderail	GUIDERAIL
Property Line	PROPERTY LINE
Existing Structure	EXISTING STRUCTURE
Existing Railroad	EXISTING RAILROAD
Existing Bench	EXISTING BENCH
Tree	TREE
Up/LB	UTILITY/LIGHT POLE
V	WATER VALVE
WV	HYDRANT
MH	UTILITY MANHOLE
SI	STORM INLET
FP	FLAG POLE
UV	UTILITY VAULT
UJB	UTILITY JUNCTION BOX
GV	GAS VALVE
SG	SIGN

JURISDICTIONAL DETERMINATION LEGEND	
Project Site Location	DESIGNED BY:
Property Line	ISSUE DATE:
Stormwater Pipe	JANUARY 2023
Tidal Datum Limit	SOLICITATION NO.:
Wetland / Waters Flag	W912D-19-F-0011
Wetland / Waters Line	CONTRACT NO.:
Non-Jurisdictional Wetland Area	W912D-14-D-0001
Jurisdictional Wetland Area	SUBMITTED BY:
Non-Jurisdictional Waters Area	PRINCETON HYDRO
Jurisdictional Waters Area	SIZE: ANSI D

KEY PLAN

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14	15	16	17	18
19	20	21	22	23
				24

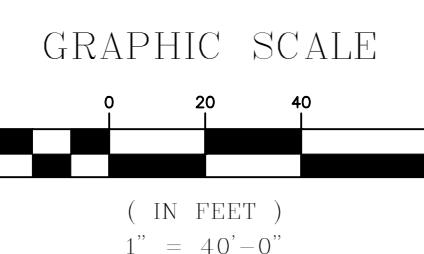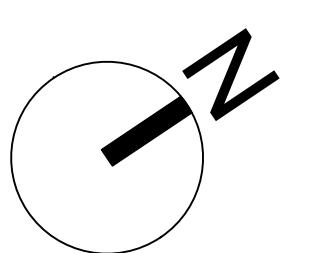


SHEET ID  
**X-JD-109**

LIBERTY STATE PARK  
ECOSYSTEM RESTORATION PROJECT  
HUDSON COUNTY, NEW JERSEY  
APPROVED JURISDICTIONAL  
DETERMINATION PLAN - LAYOUT 9




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US Army Corps  
of Engineers®

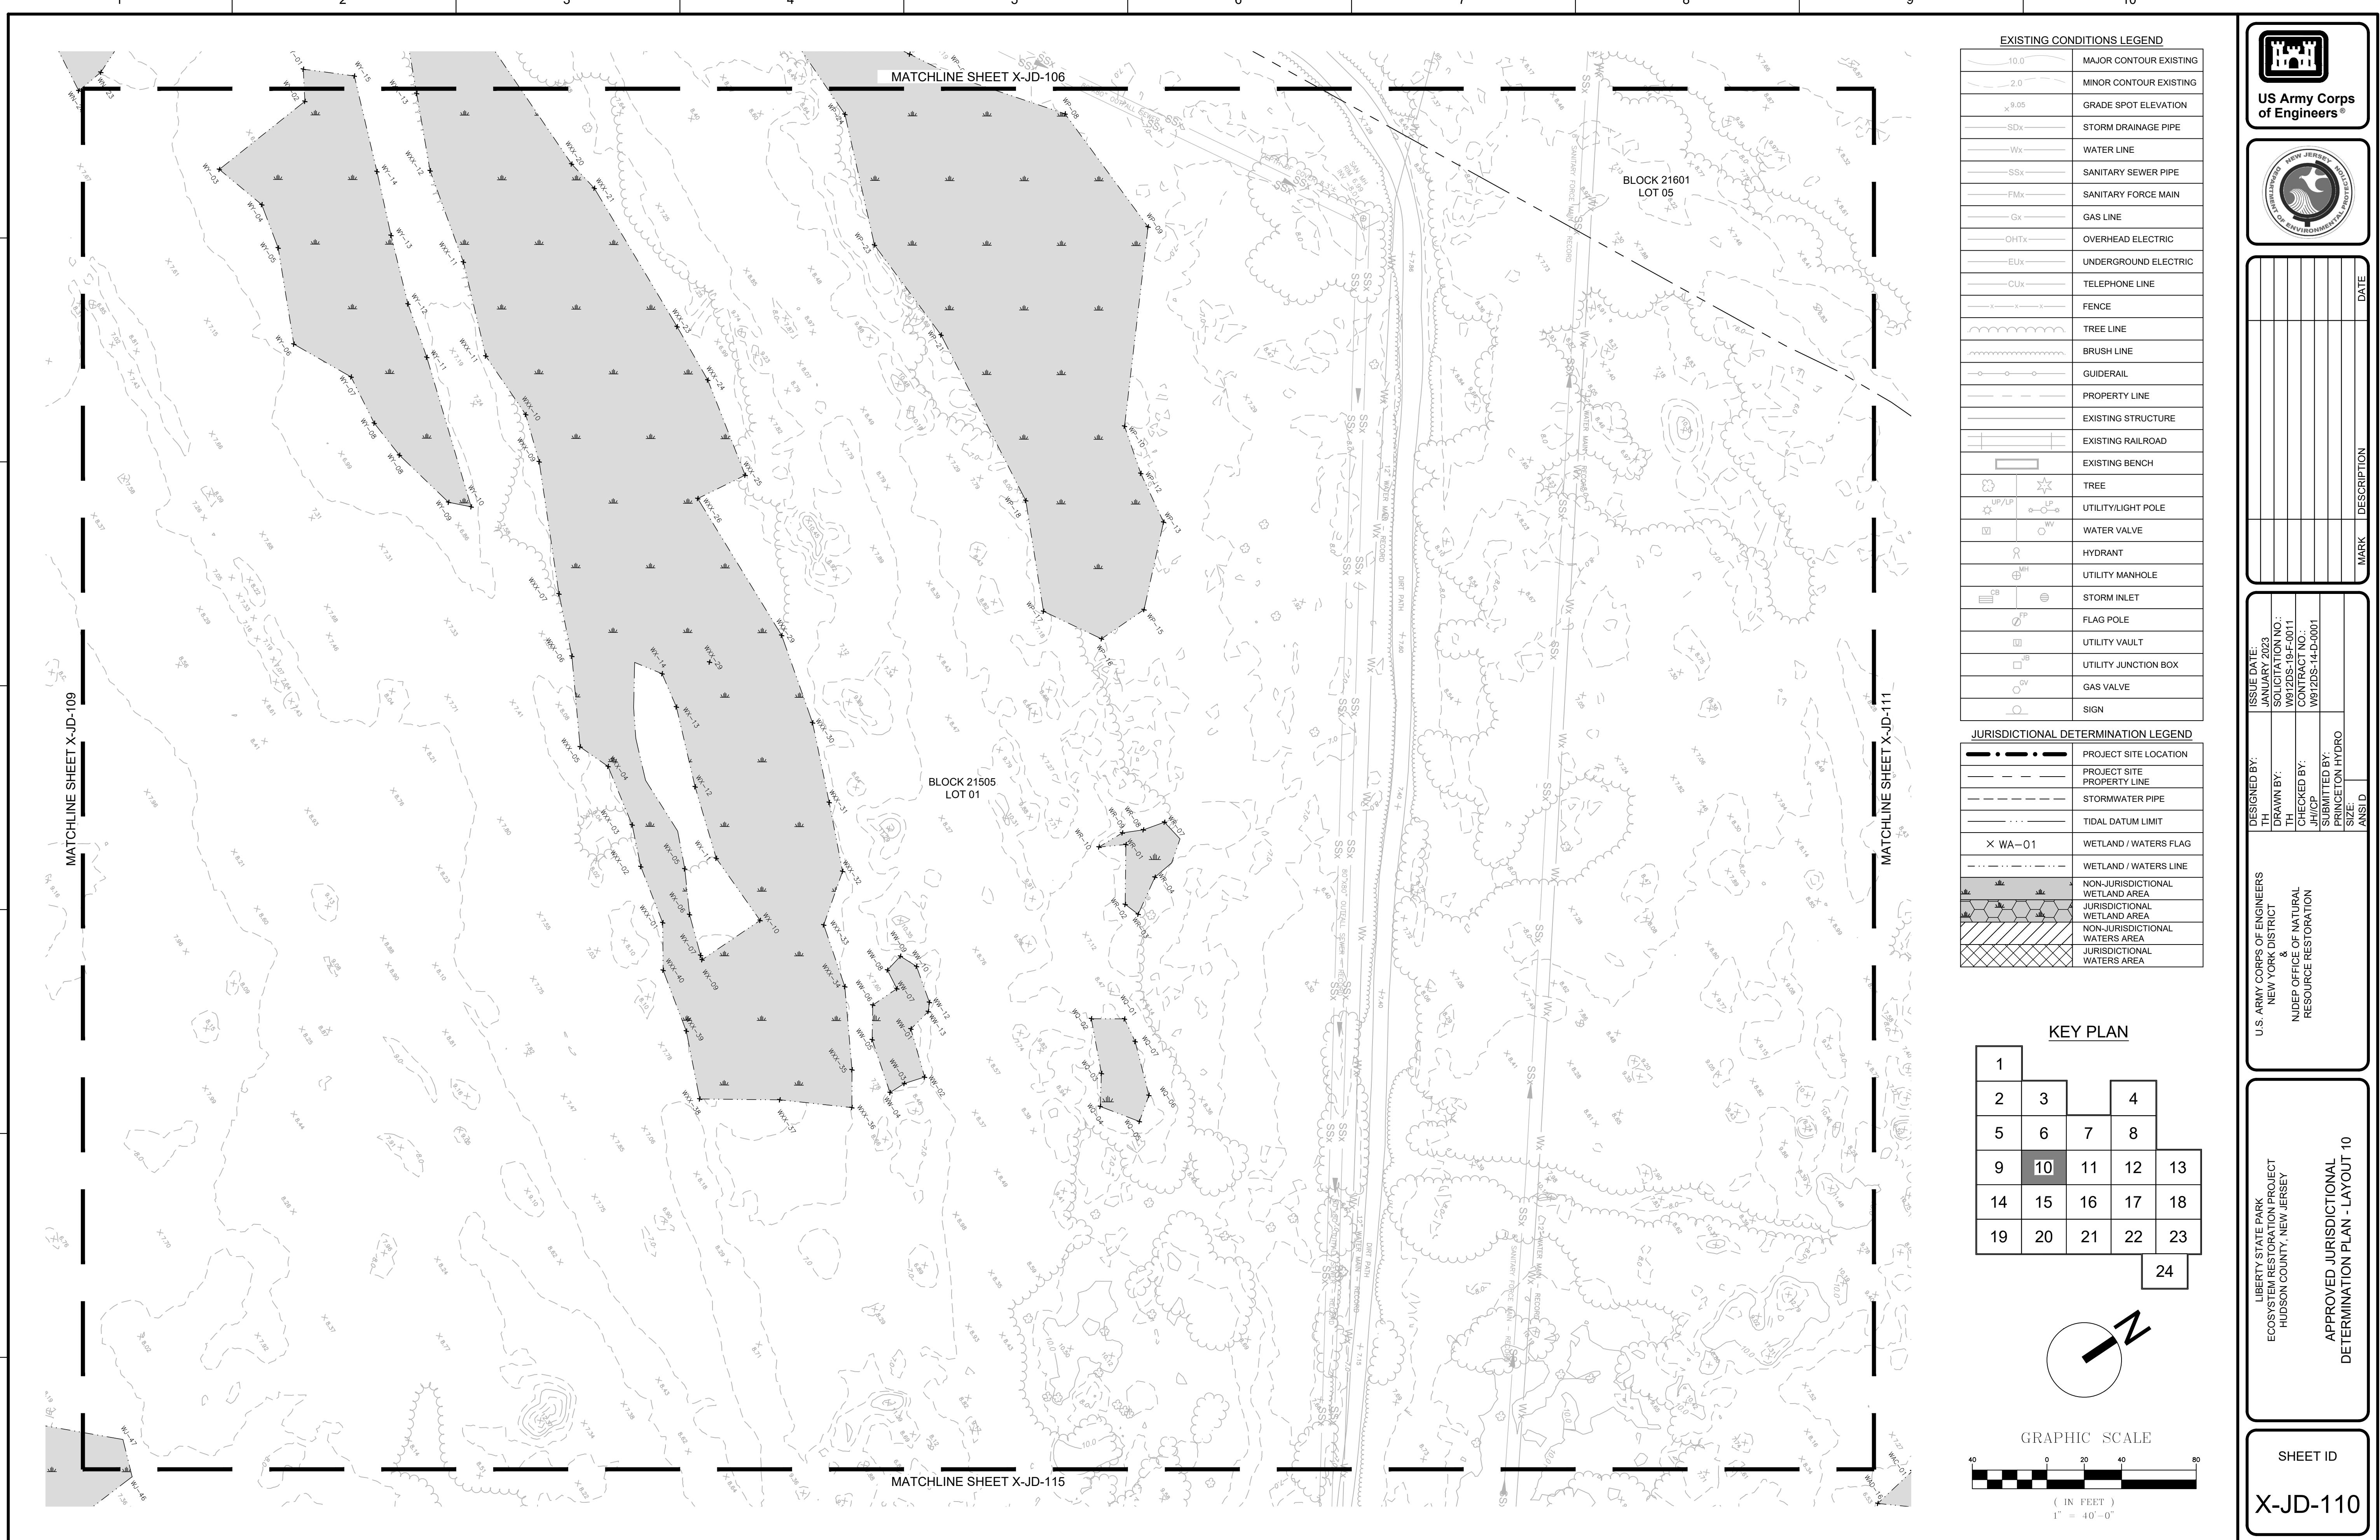

NEW JERSEY DEPARTMENT OF ENVIRONMENTAL PROTECTION

DATE

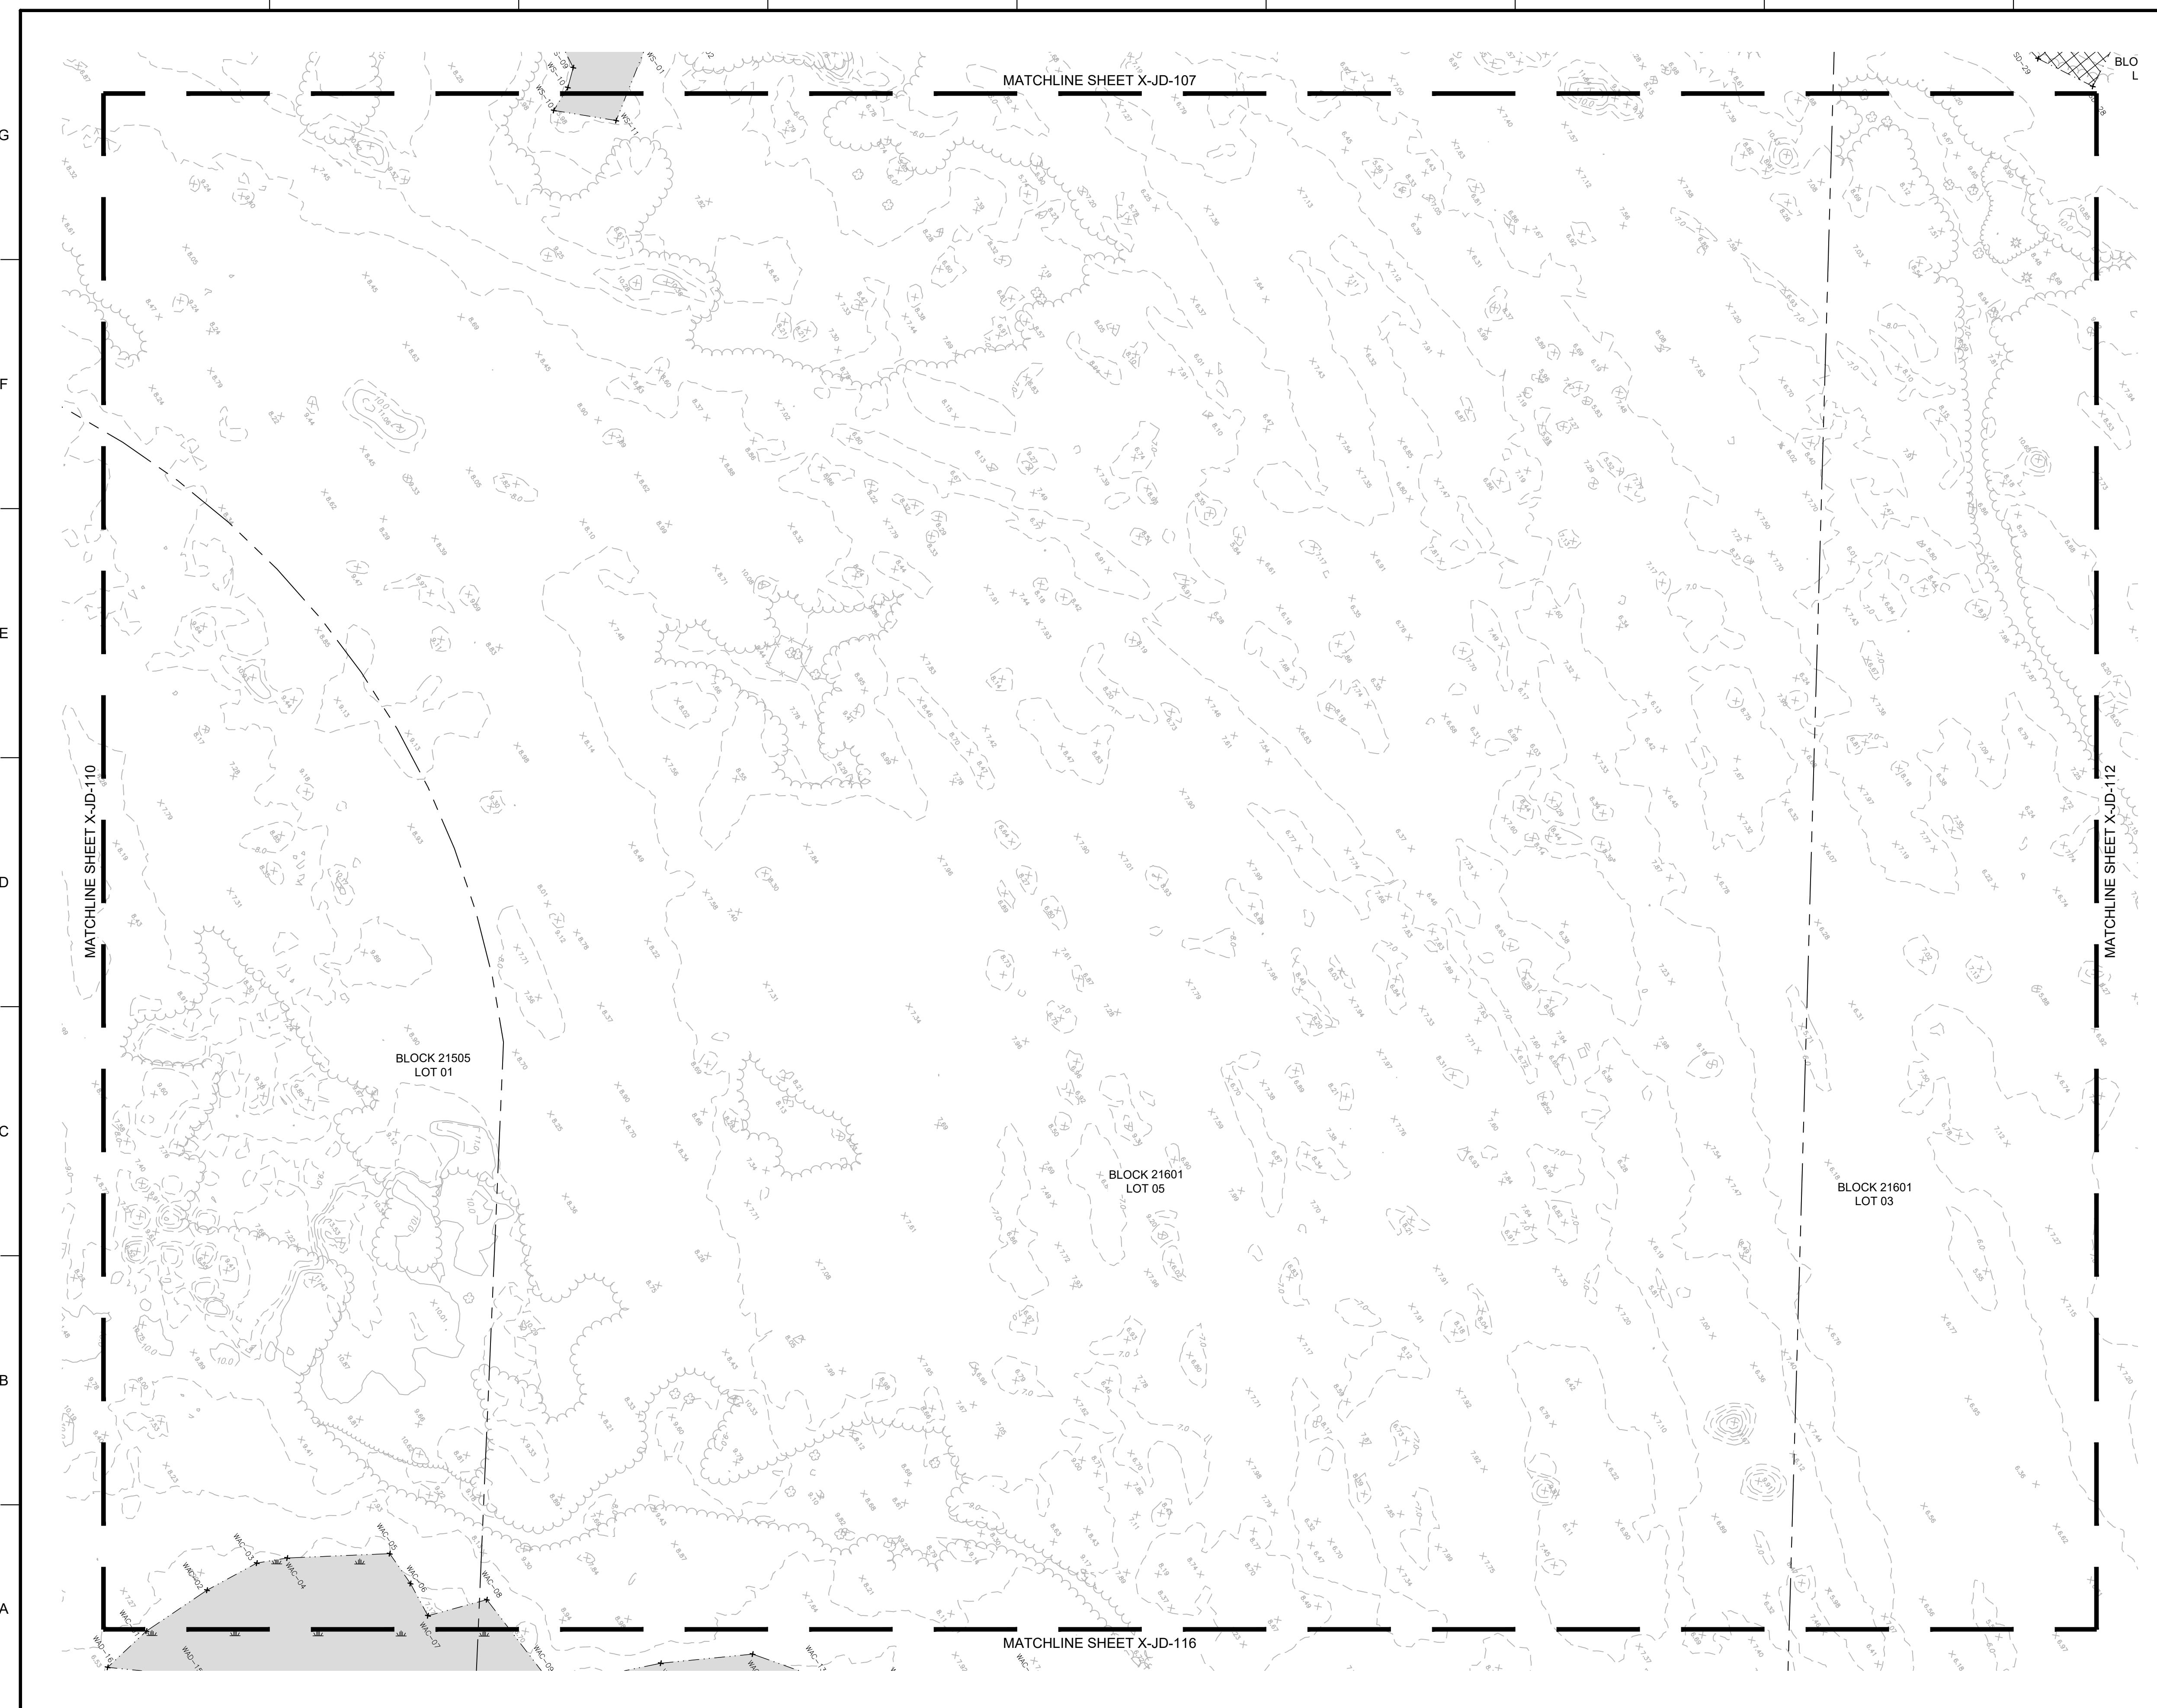MARK	DESCRIPTION


U.S. ARMY CORPS OF ENGINEERS NEW YORK DISTRICT	DESIGNED BY: TH	ISSUE DATE: JANUARY 2023
& NUDEP OFFICE OF NATURAL RESOURCE RESTORATION	DRAWN BY: TH	SOLICITATION NO.: W9120-19-F-0011
	CHECKED BY: JH/CP	CONTRACT NO.: W9120-14-D-0001
	SUBMITTED BY: PRINCETON HYDRO	SIZE: ANSI D


LIBERTY STATE PARK ECOSYSTEM RESTORATION PROJECT HUDSON COUNTY, NEW JERSEY	APPROVED JURISDICTIONAL DETERMINATION PLAN - LAYOUT 11
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60% CONCEPT - NOT FOR CONSTRUCTION

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## EXISTING CONDITIONS LEGEND

	MAJOR CONTOUR EXISTING
	MINOR CONTOUR EXISTING
	GRADE SPOT ELEVATION
	STORM DRAINAGE PIPE
	WATER LINE
	SANITARY SEWER PIPE
	SANITARY FORCE MAIN
	GAS LINE
	OVERHEAD ELECTRIC
	UNDERGROUND ELECTRIC
	TELEPHONE LINE
	FENCE
	TREE LINE
	BRUSH LINE
	GUIDERAIL
	PROPERTY LINE
	EXISTING STRUCTURE
	EXISTING RAILROAD
	EXISTING BENCH
	TREE
	UTILITY/LIGHT POLE
	WATER VALVE
	HYDRANT
	UTILITY MANHOLE
	STORM INLET
	FLAG POLE
	UTILITY VAULT
	UTILITY JUNCTION BOX
	GAS VALVE
	SIGN

JURISDICTIONAL DETERMINATION LEGEND	
	PROJECT SITE LOCATION
	PROJECT SITE PROPERTY LINE
	STORMWATER PIPE
	TIDAL DATUM LIMIT
X WA-01	WETLAND / WATERS FLAG
	WETLAND / WATERS LINE
	NON-JURISDICTIONAL WETLAND AREA
	JURISDICTIONAL WETLAND AREA
	NON-JURISDICTIONAL WATERS AREA
	JURISDICTIONAL WATERS AREA

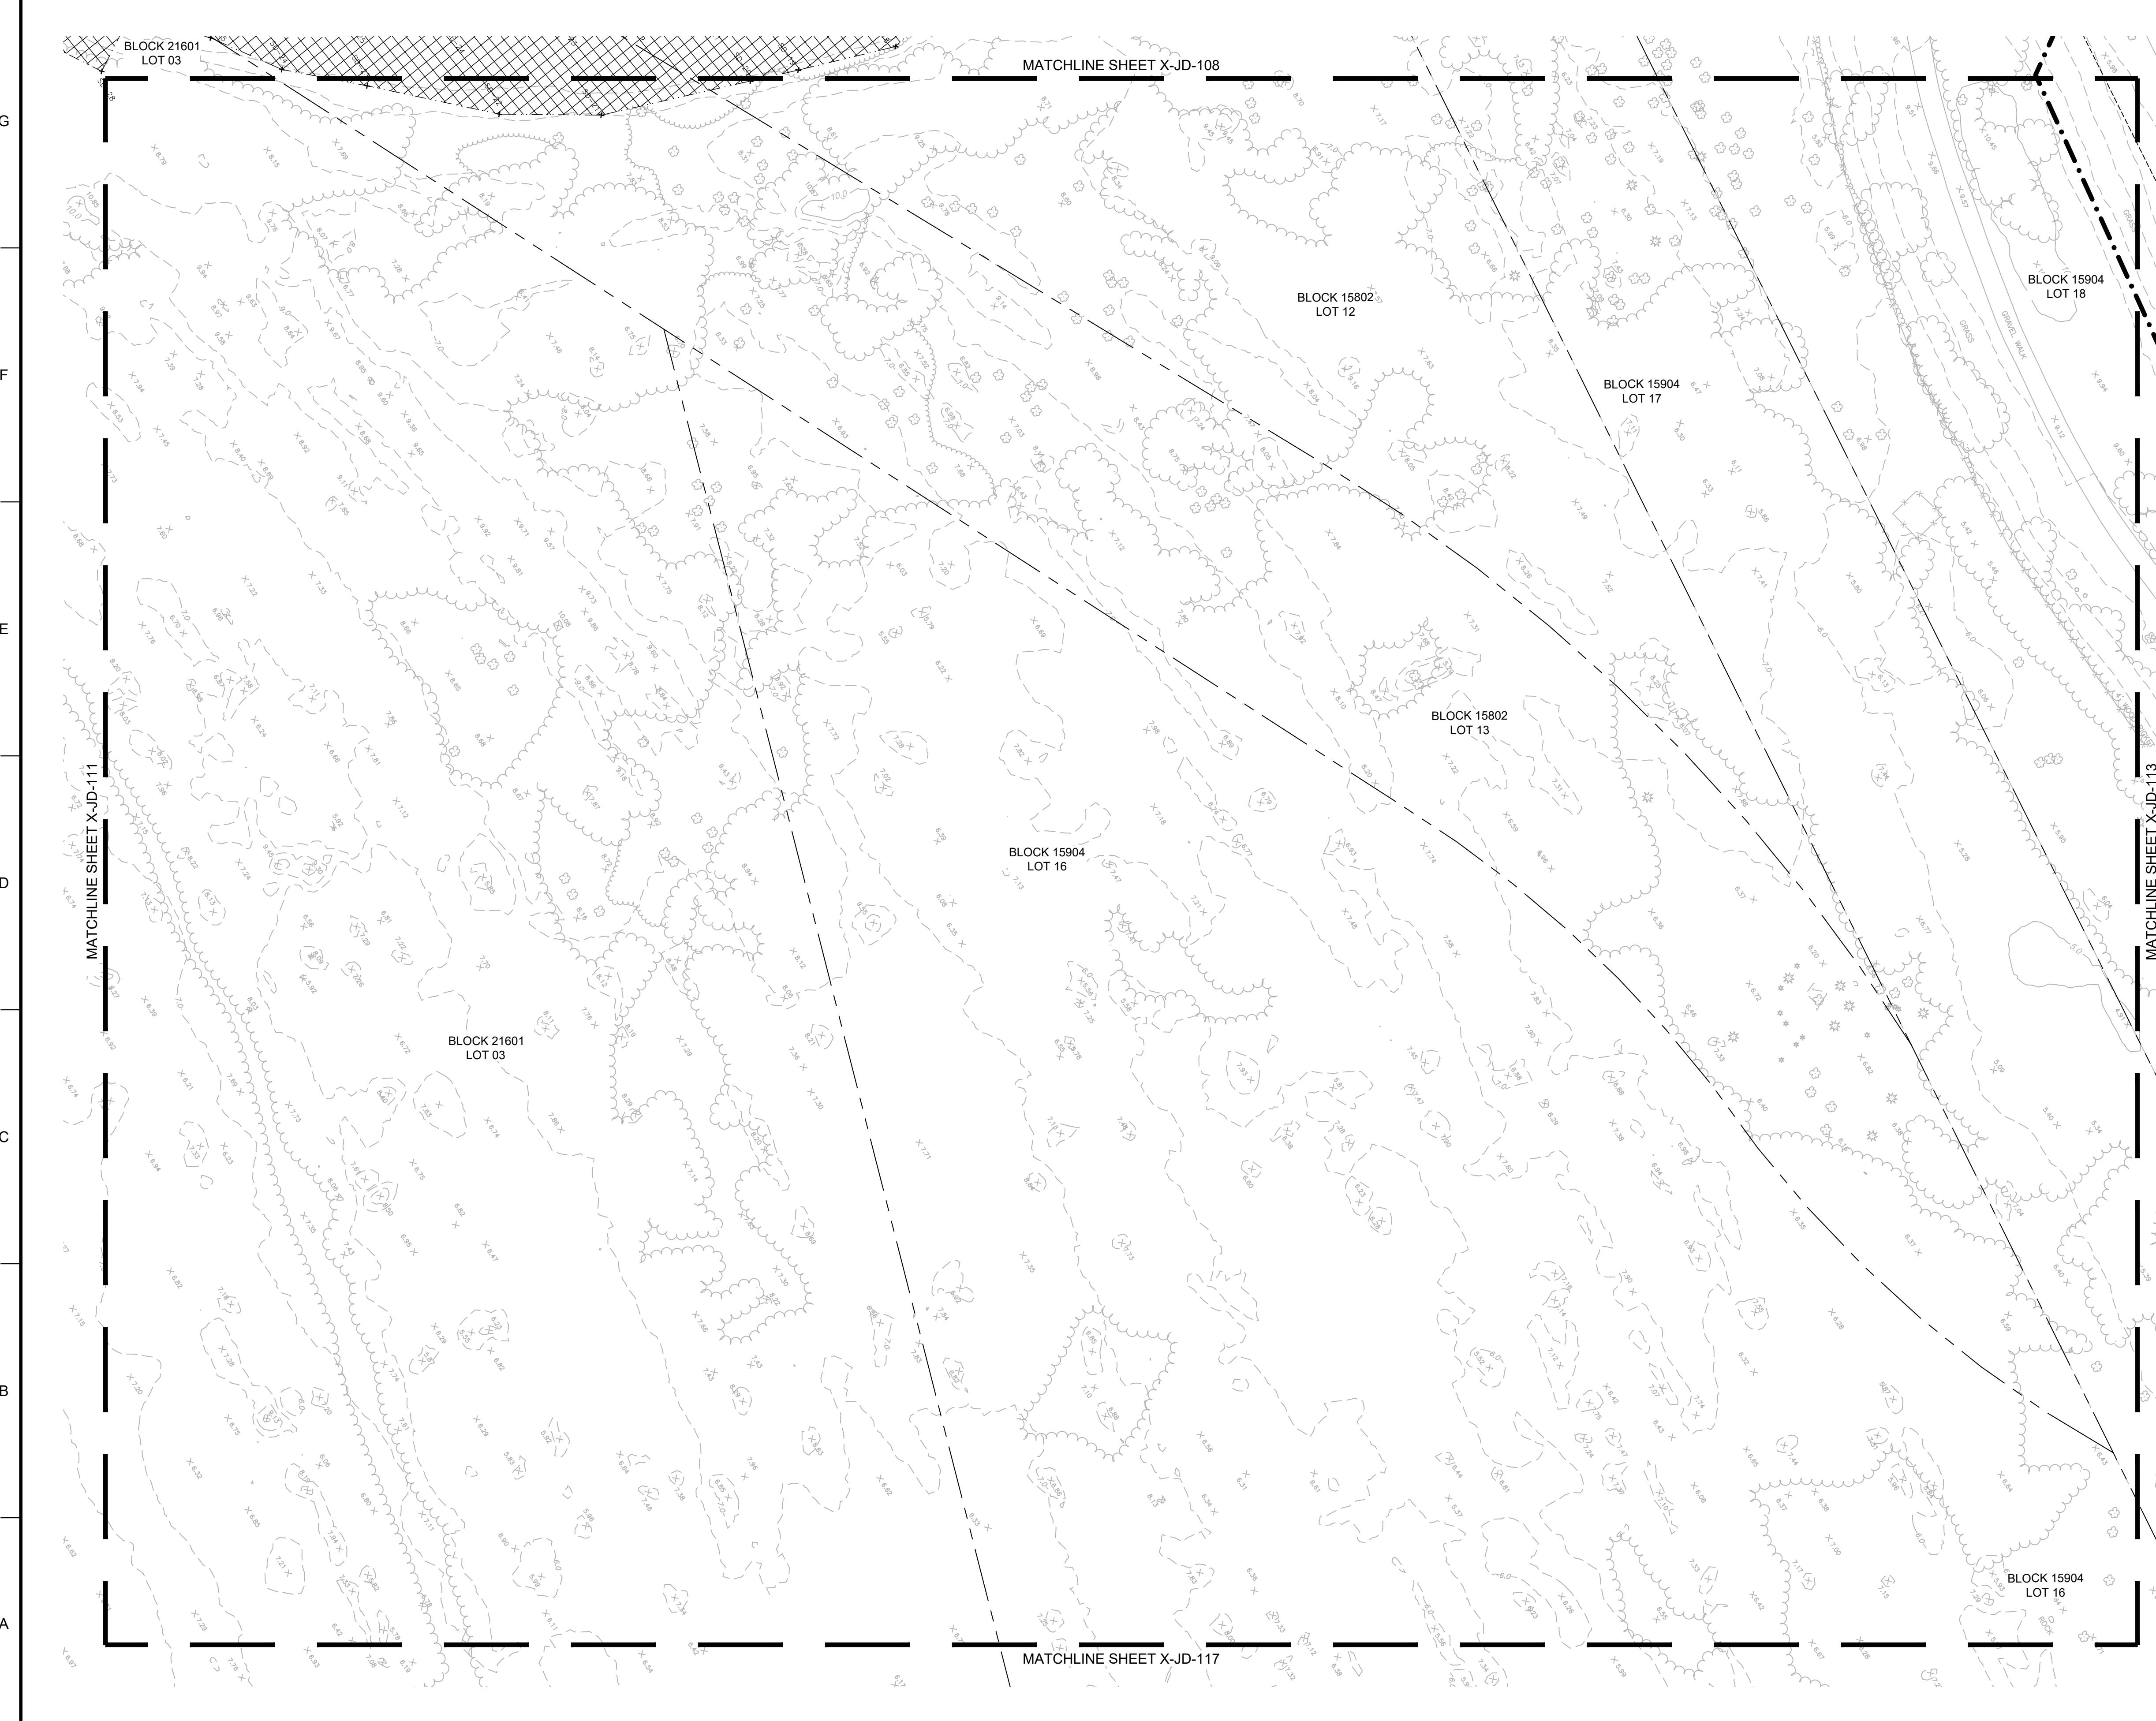

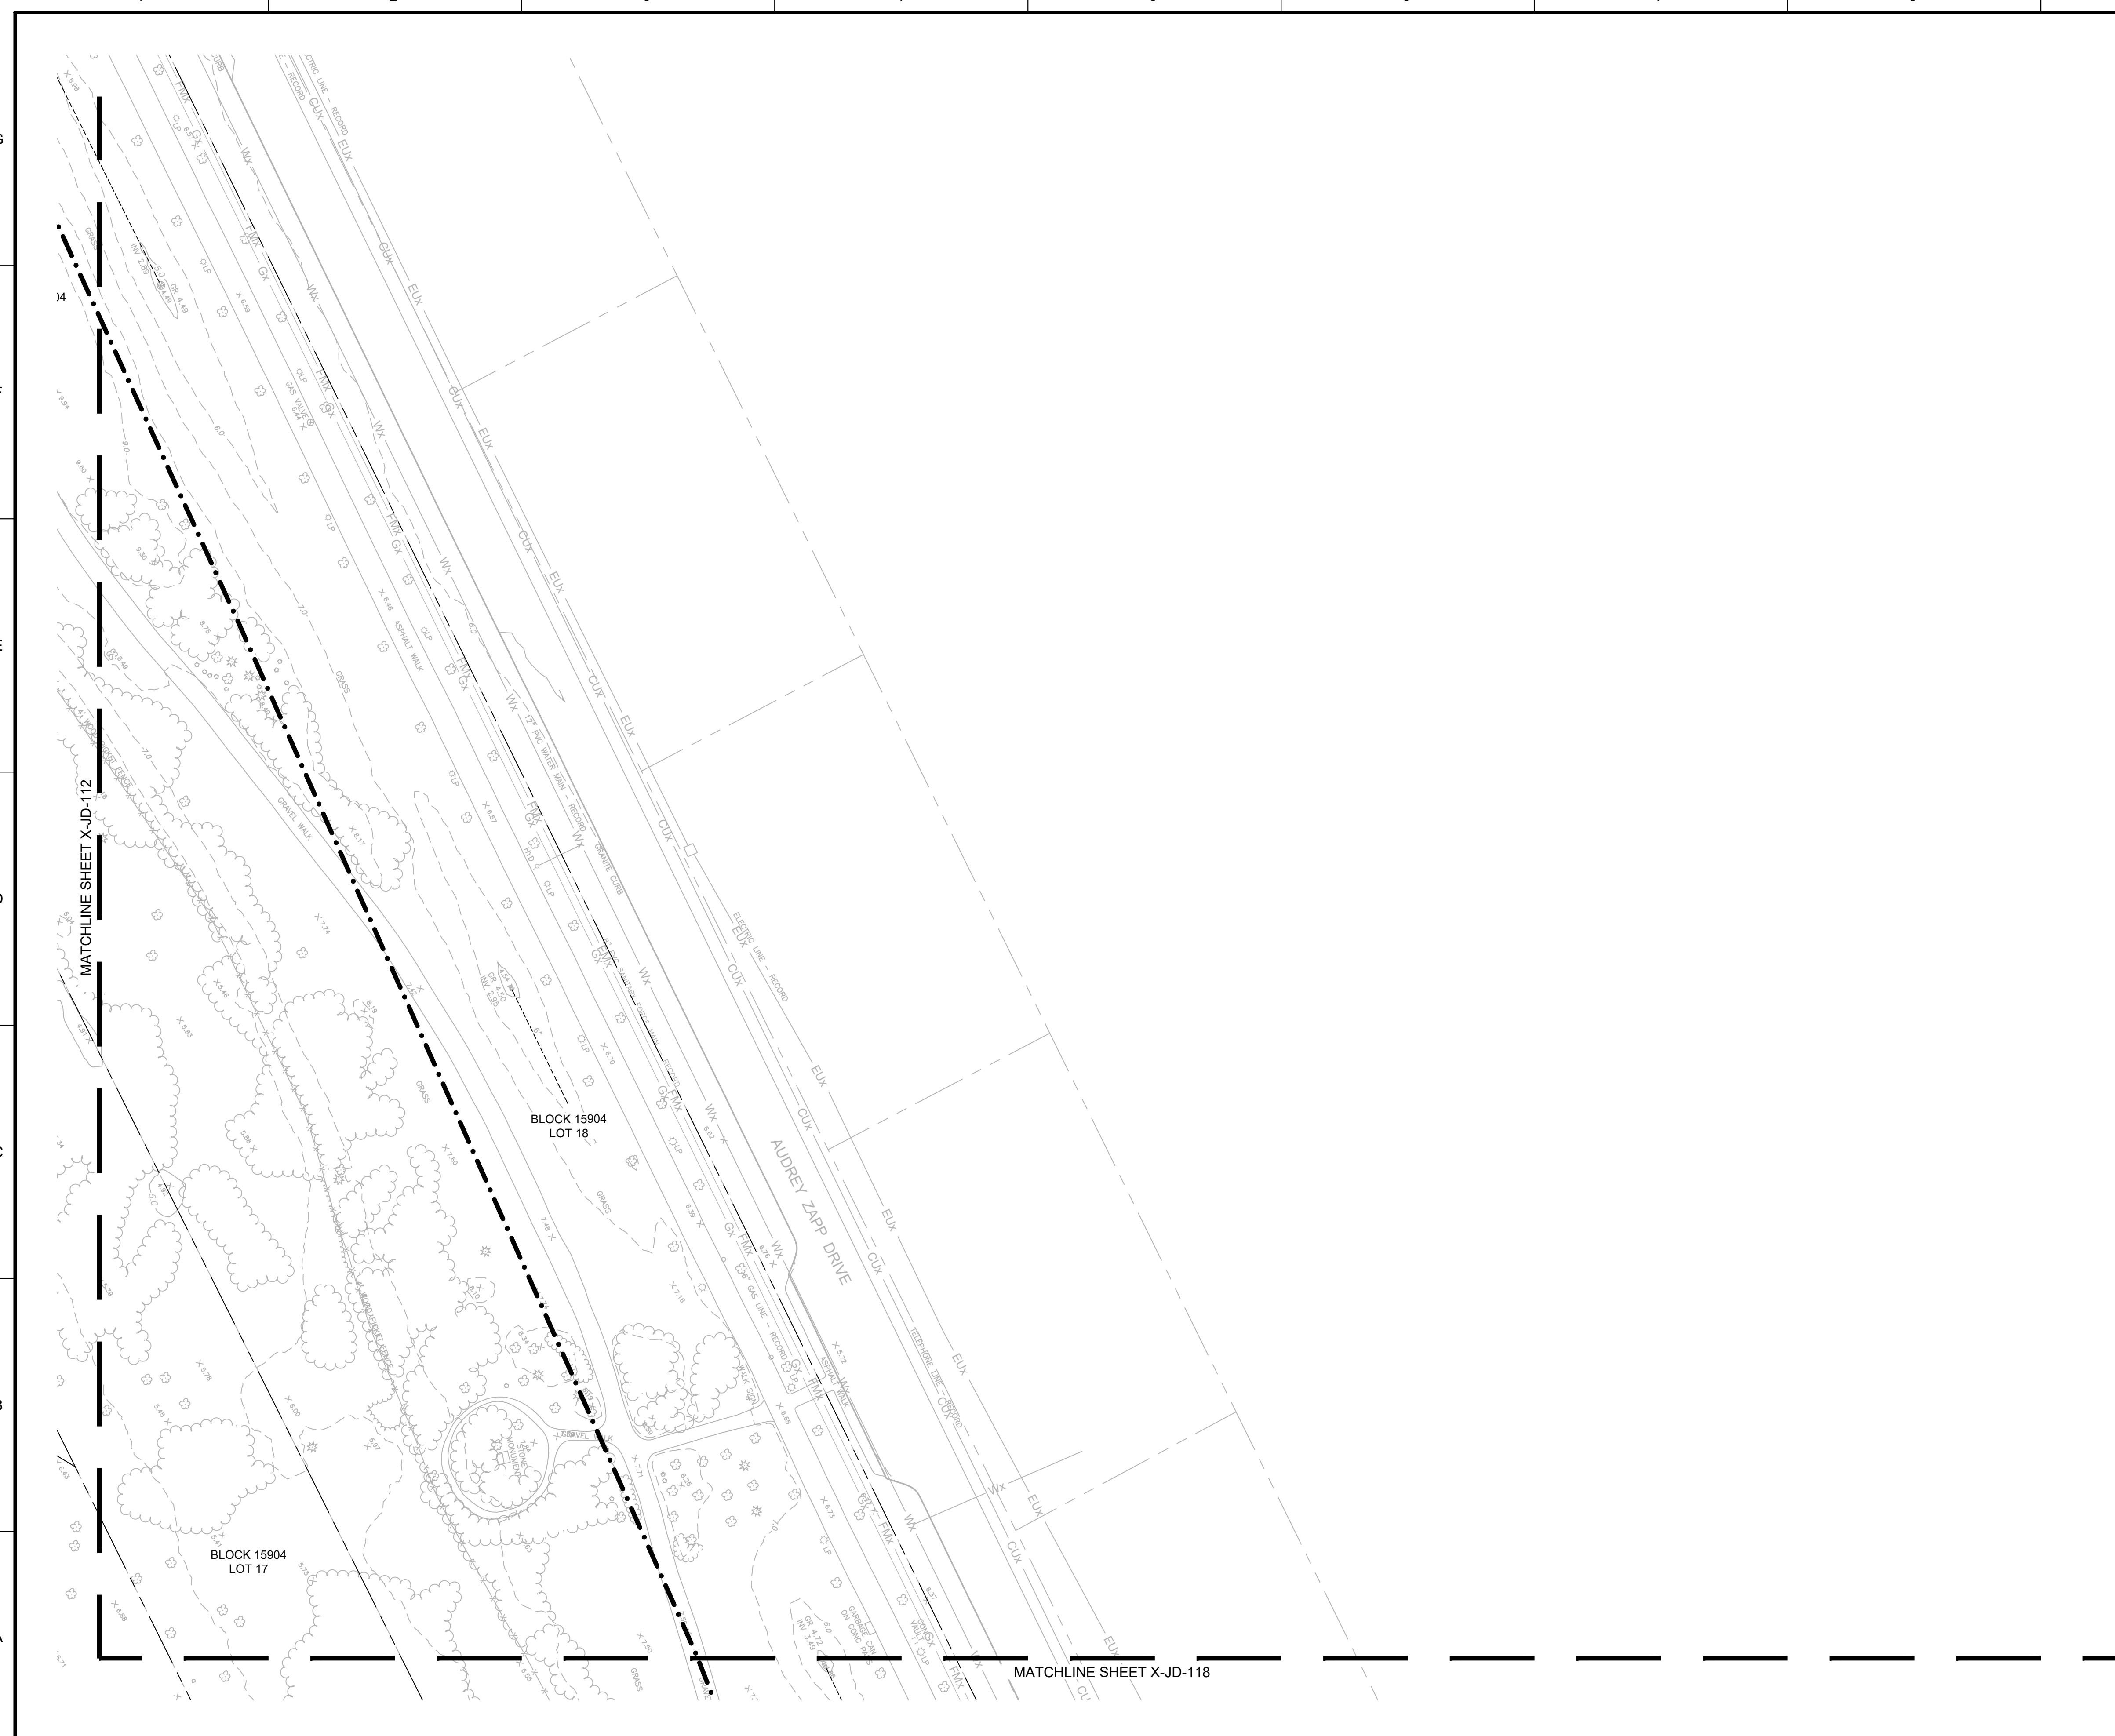
**US Army Corps  
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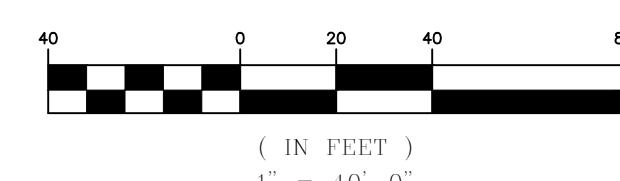
SIGNED BY:	ISSUE DATE: JANUARY 2023
AWN BY:	SOLICITATION NO.: W912DS-19-F-0011
EECKED BY: (CP)	CONTRACT NO.: W912DS-14-D-0001
BMITTED BY: (CNCETON HYDRO)	E: _____ SID: _____

## KEY PLAN

Key Plan				
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9	10	11	12	13
14	15	16	17	18
19	20	21	22	23





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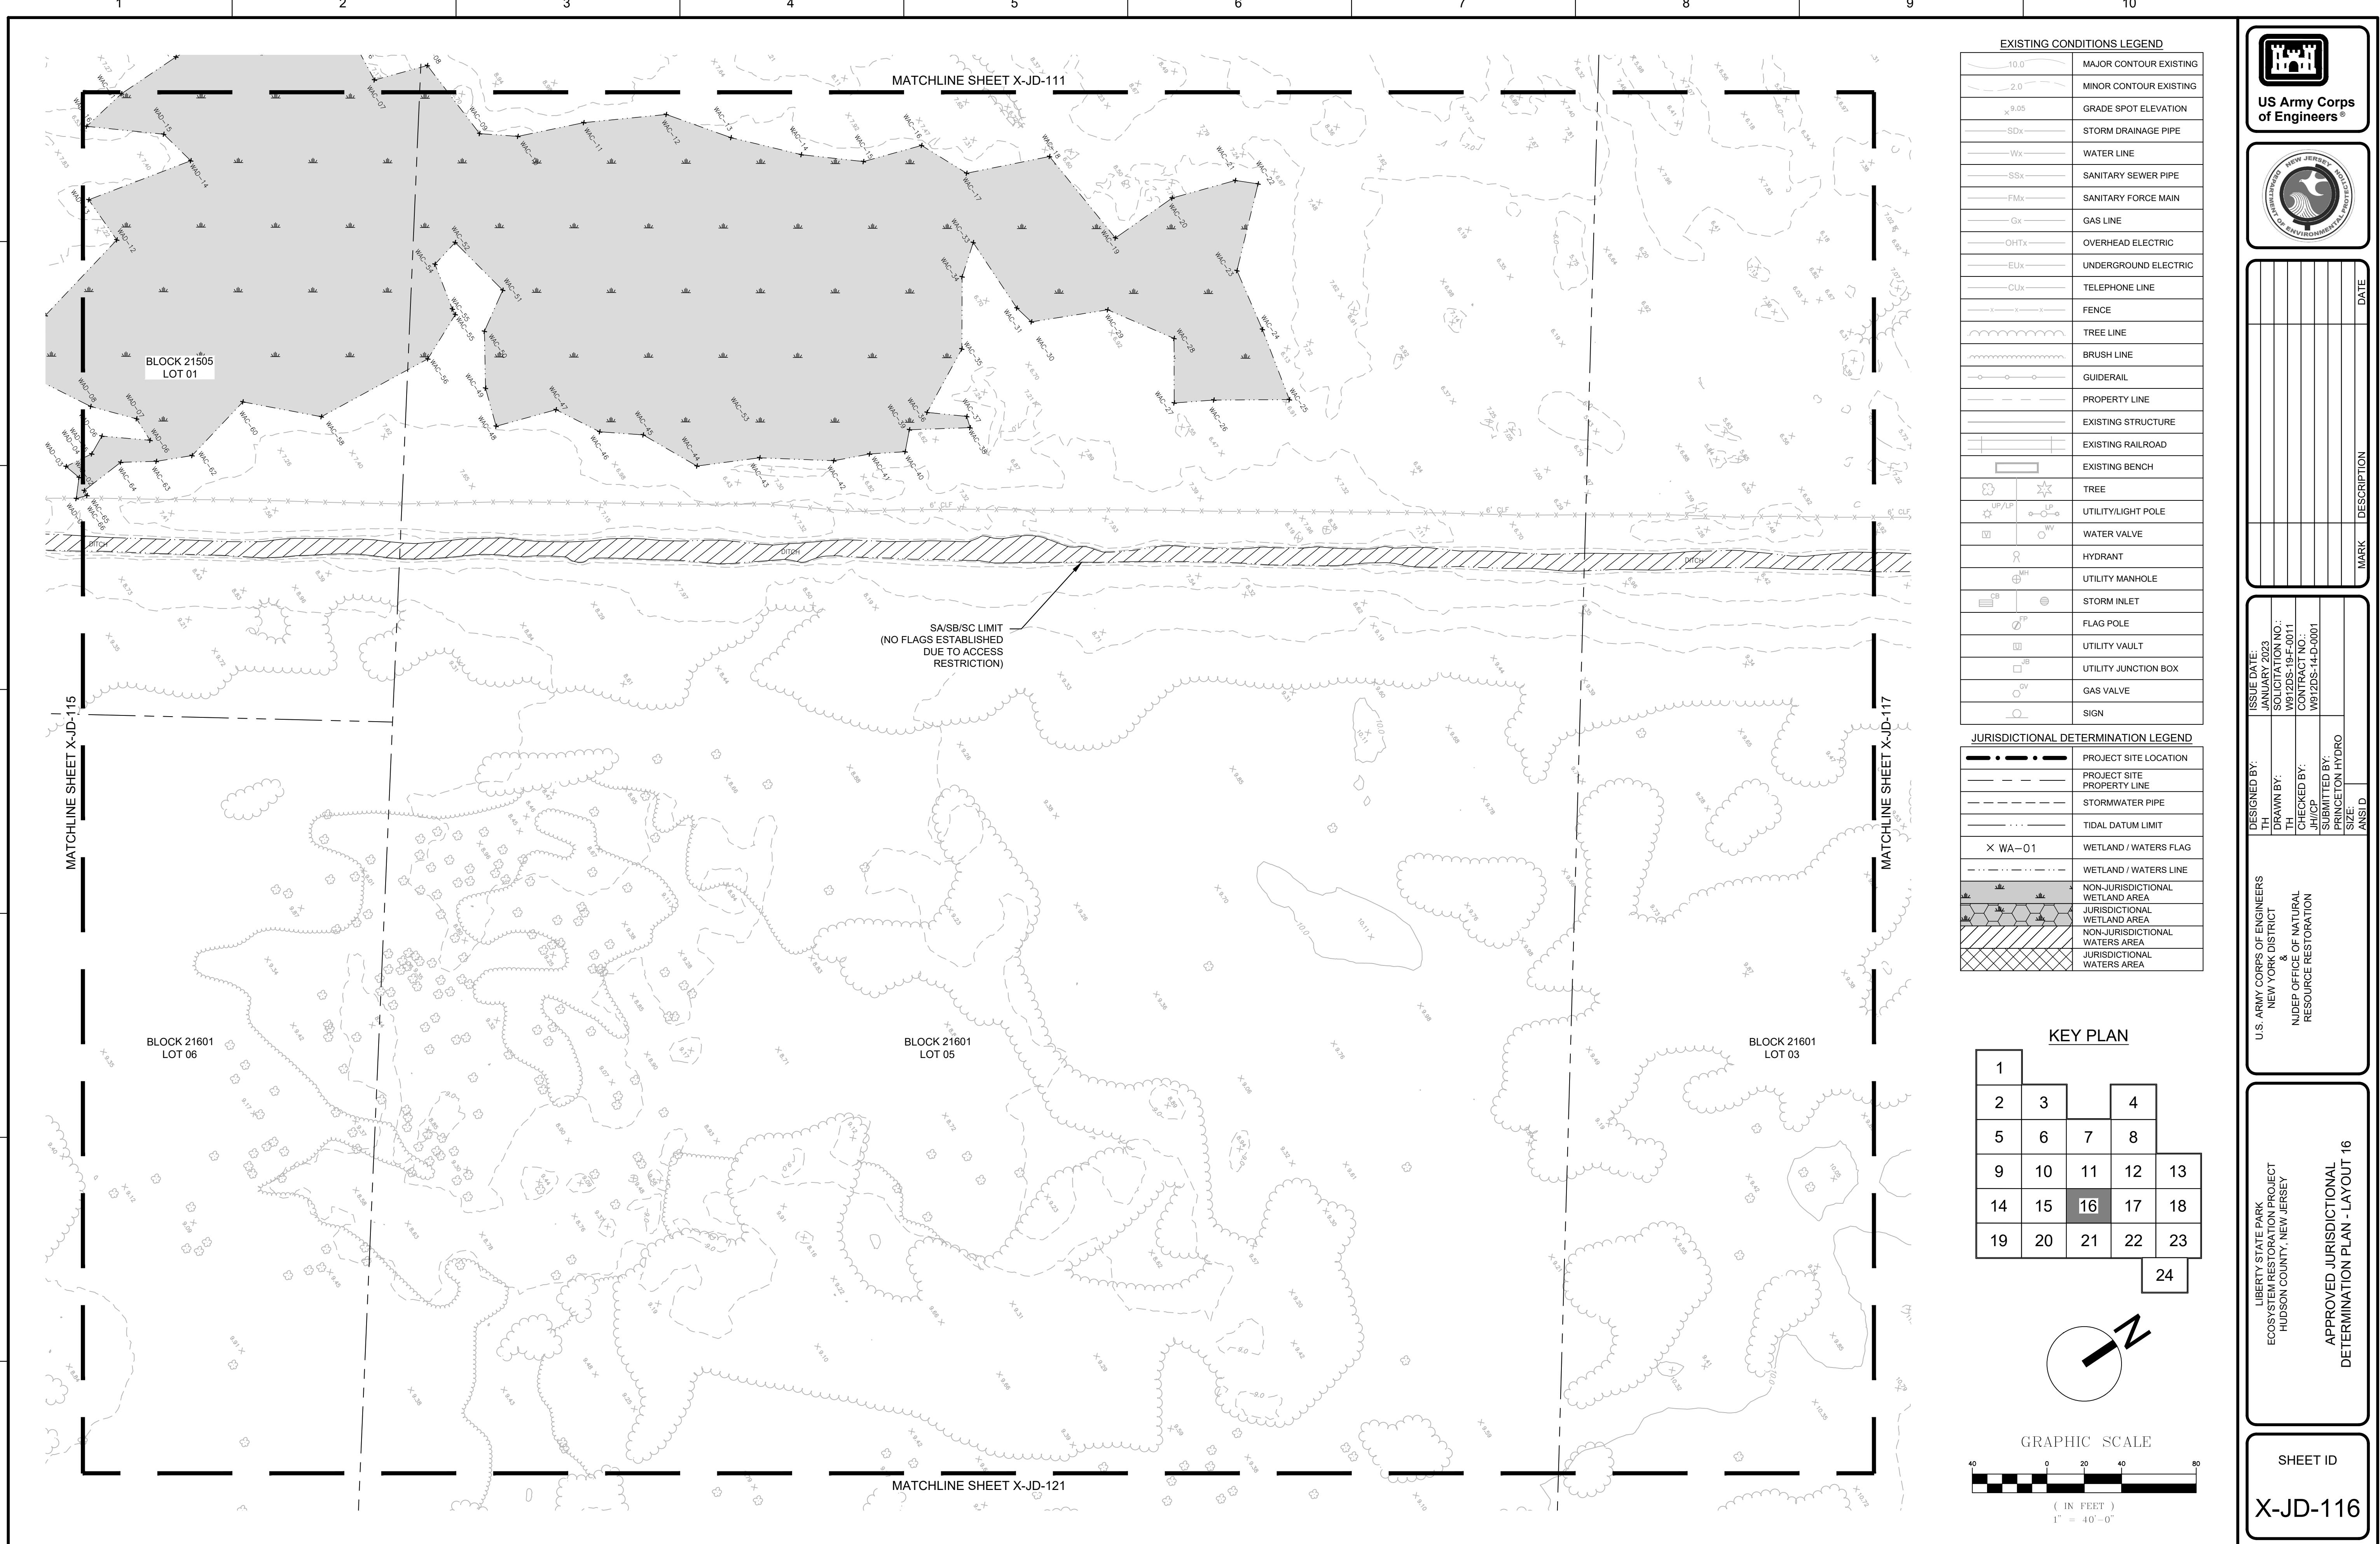
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**X-JD-113**

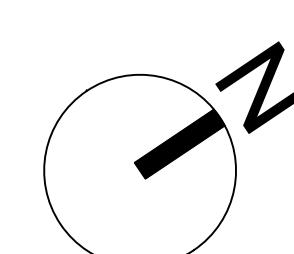SHEET ID  
X-JD-113




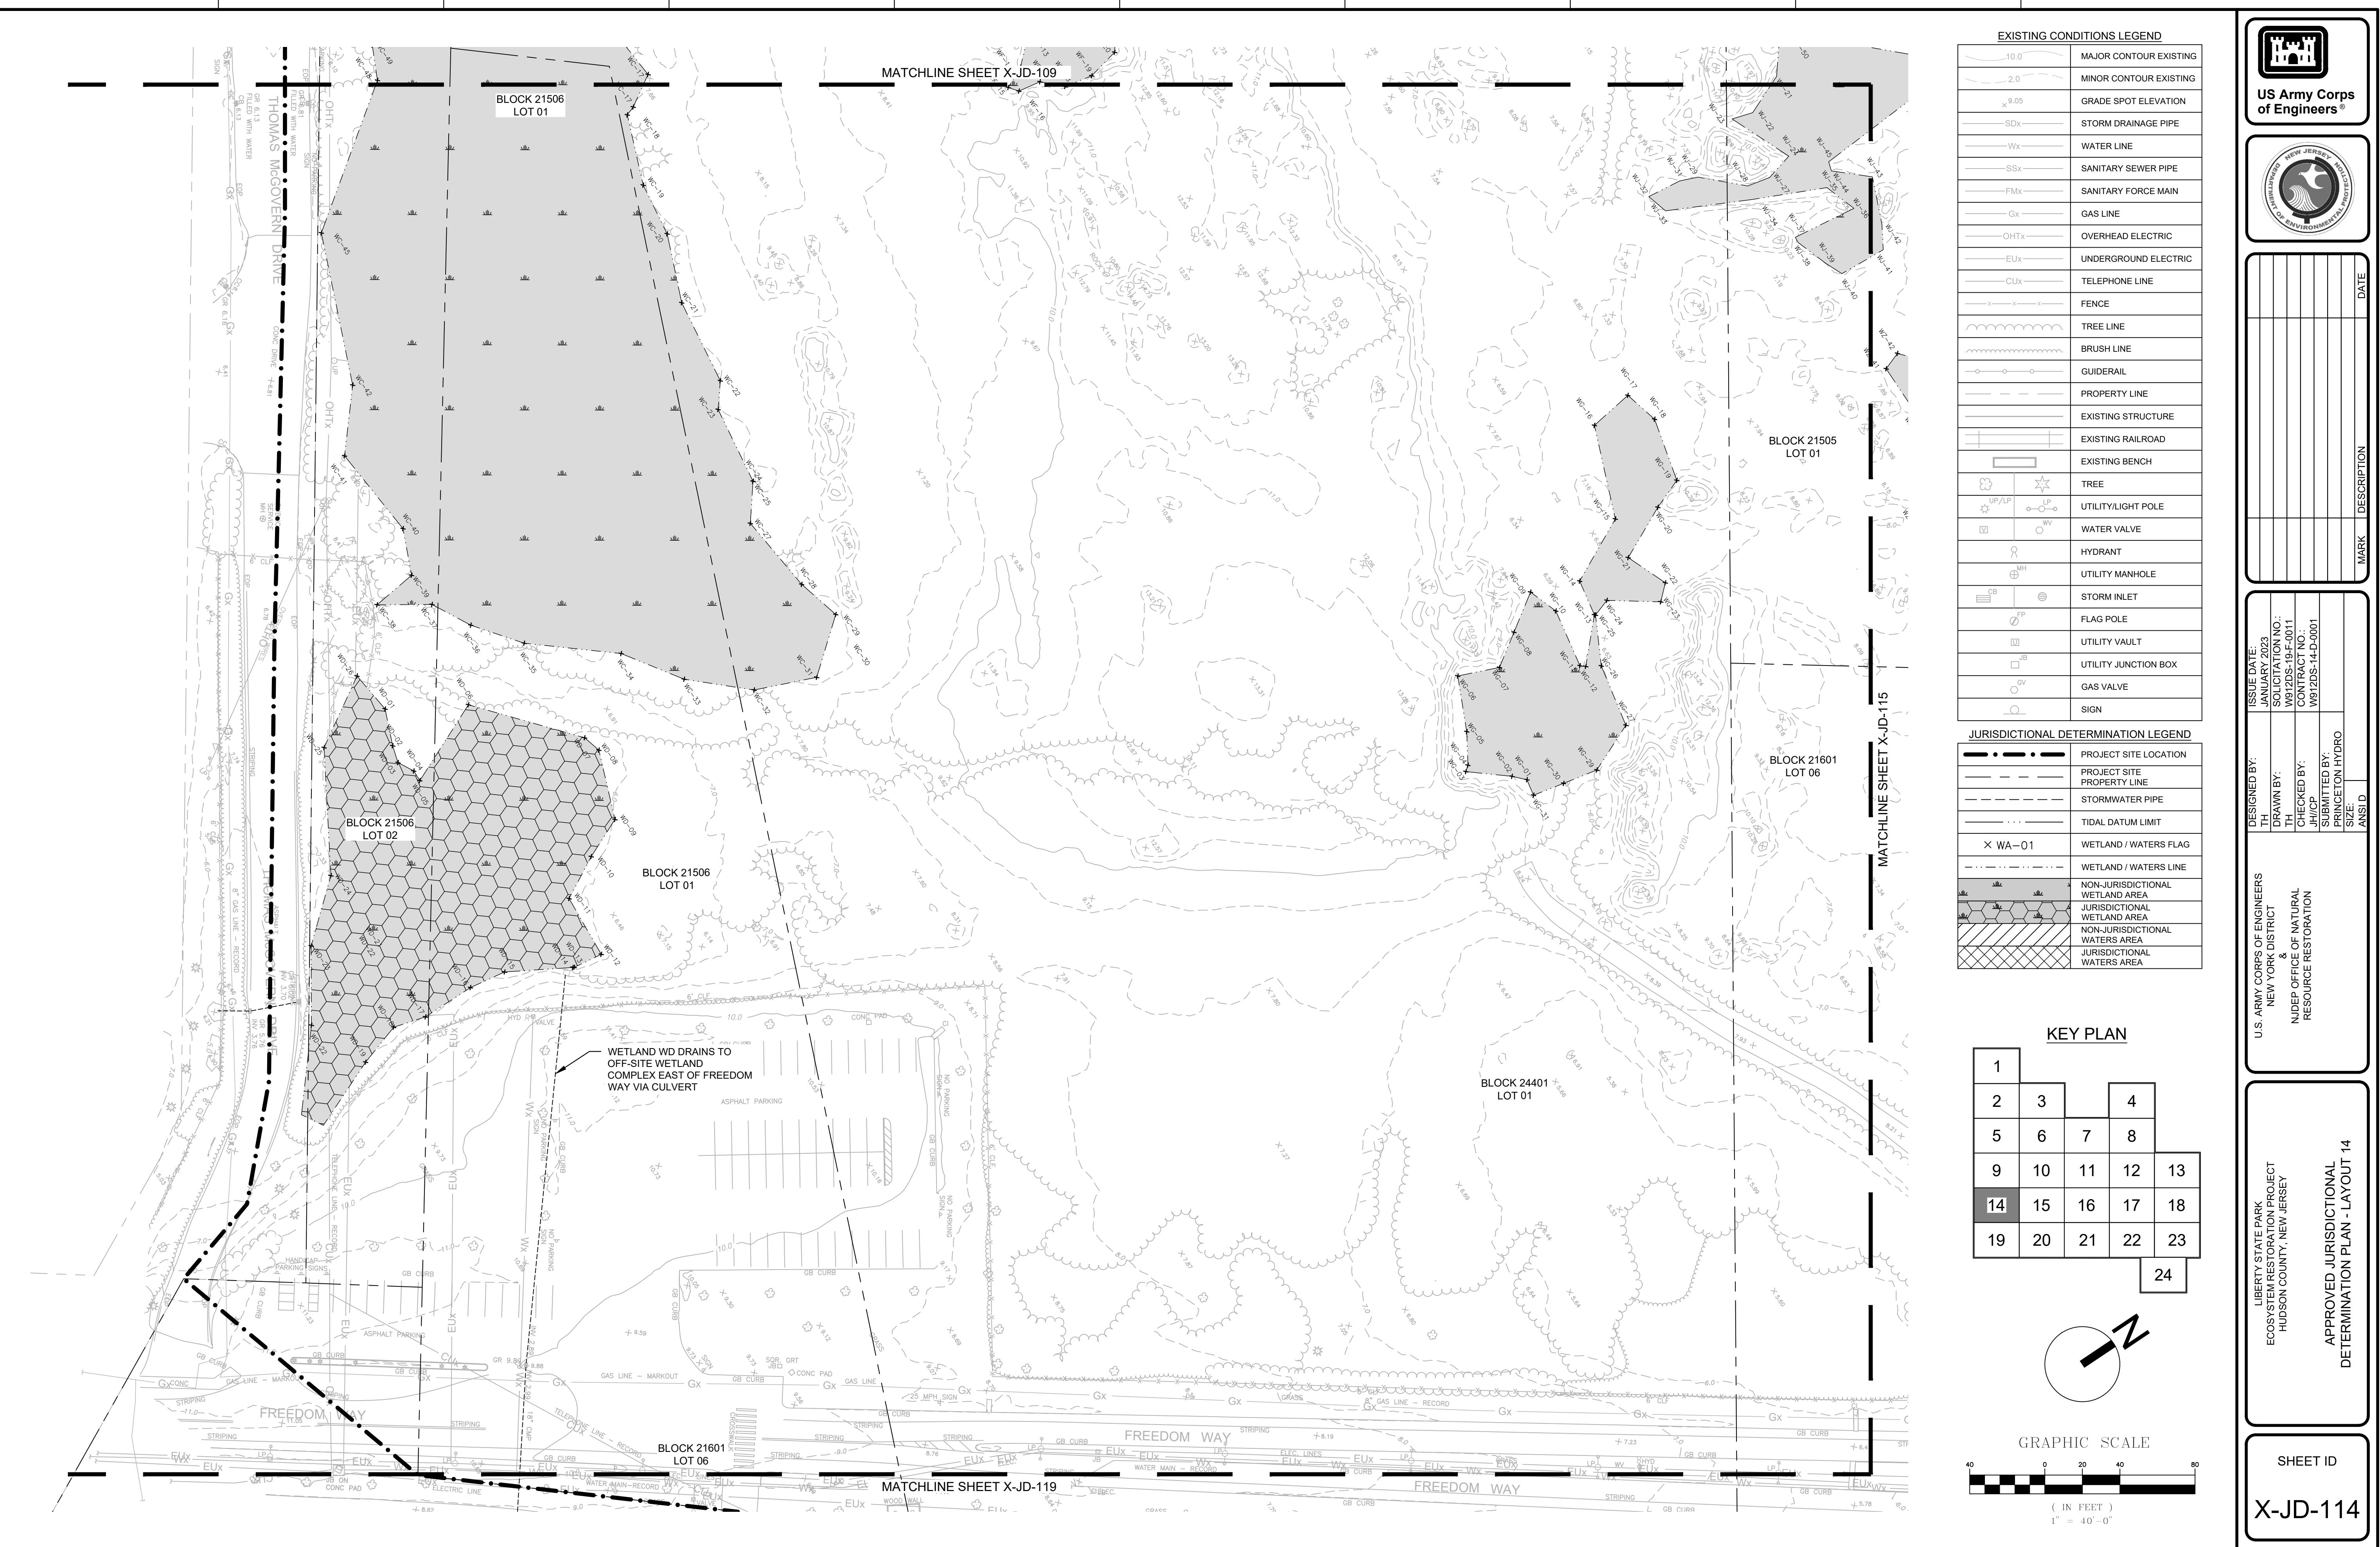


**60% CONCEPT - NOT FOR CONSTRUCTION**

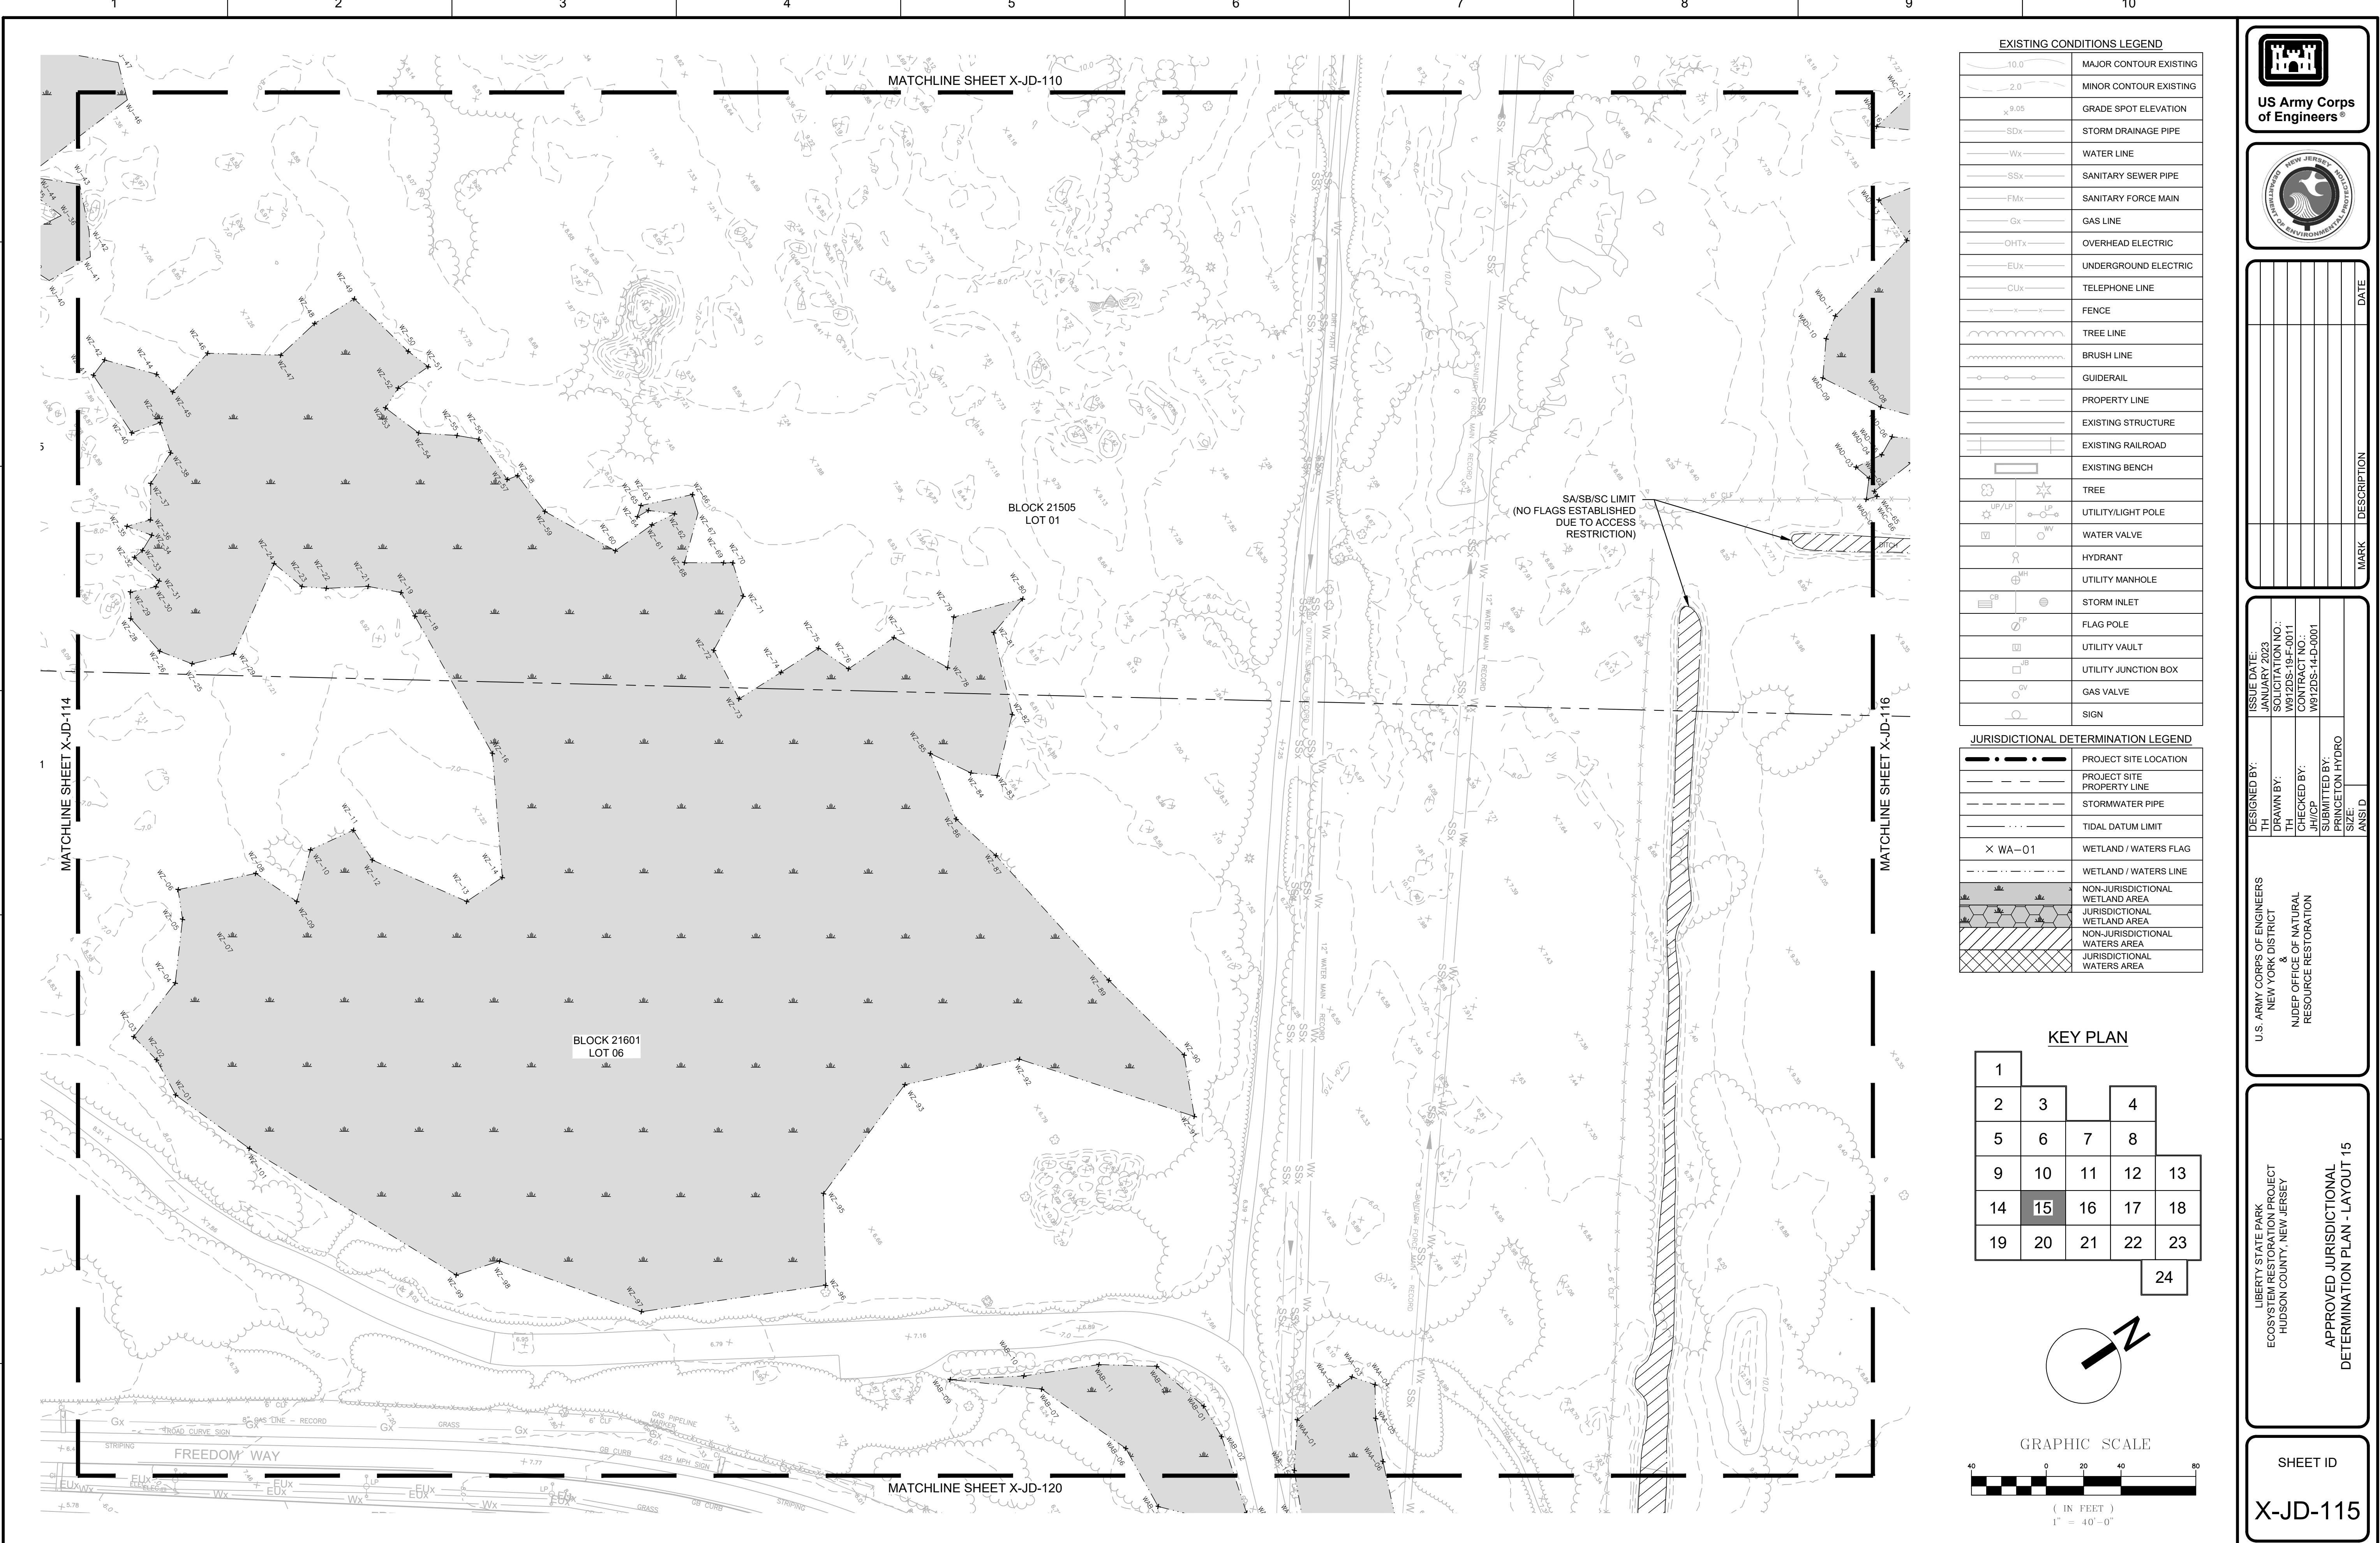


60% CONCEPT - NOT FOR CONSTRUCTION

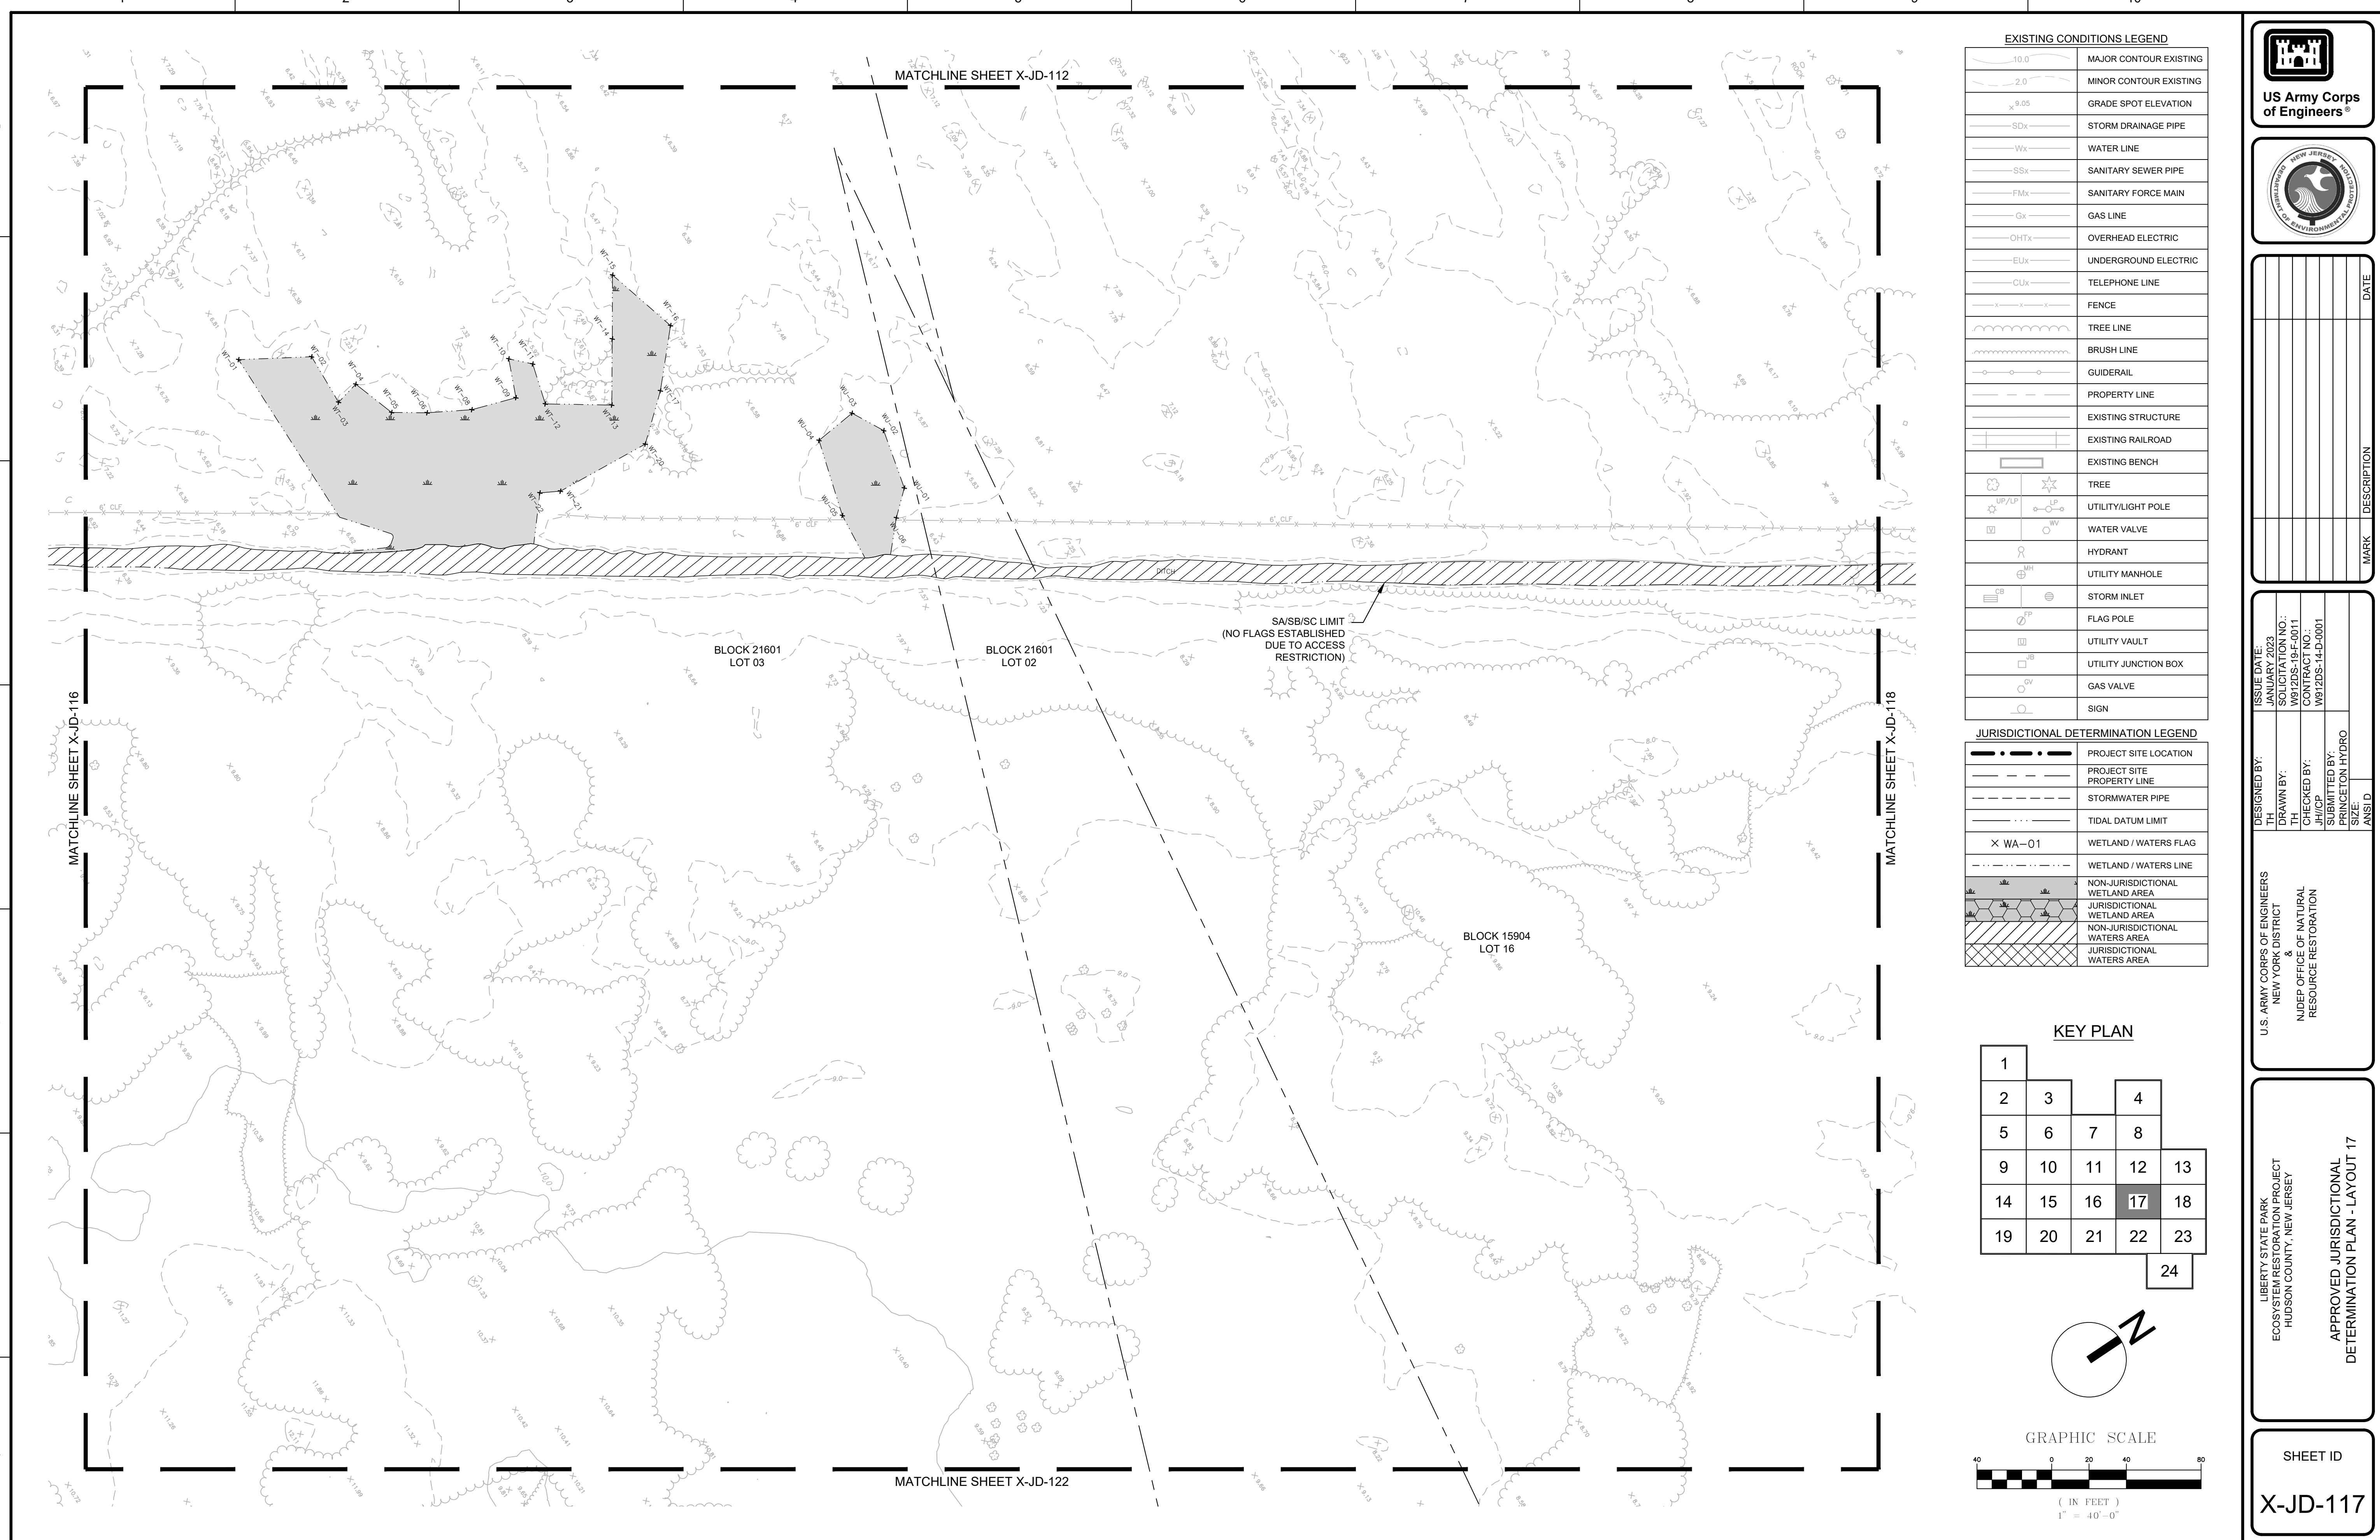

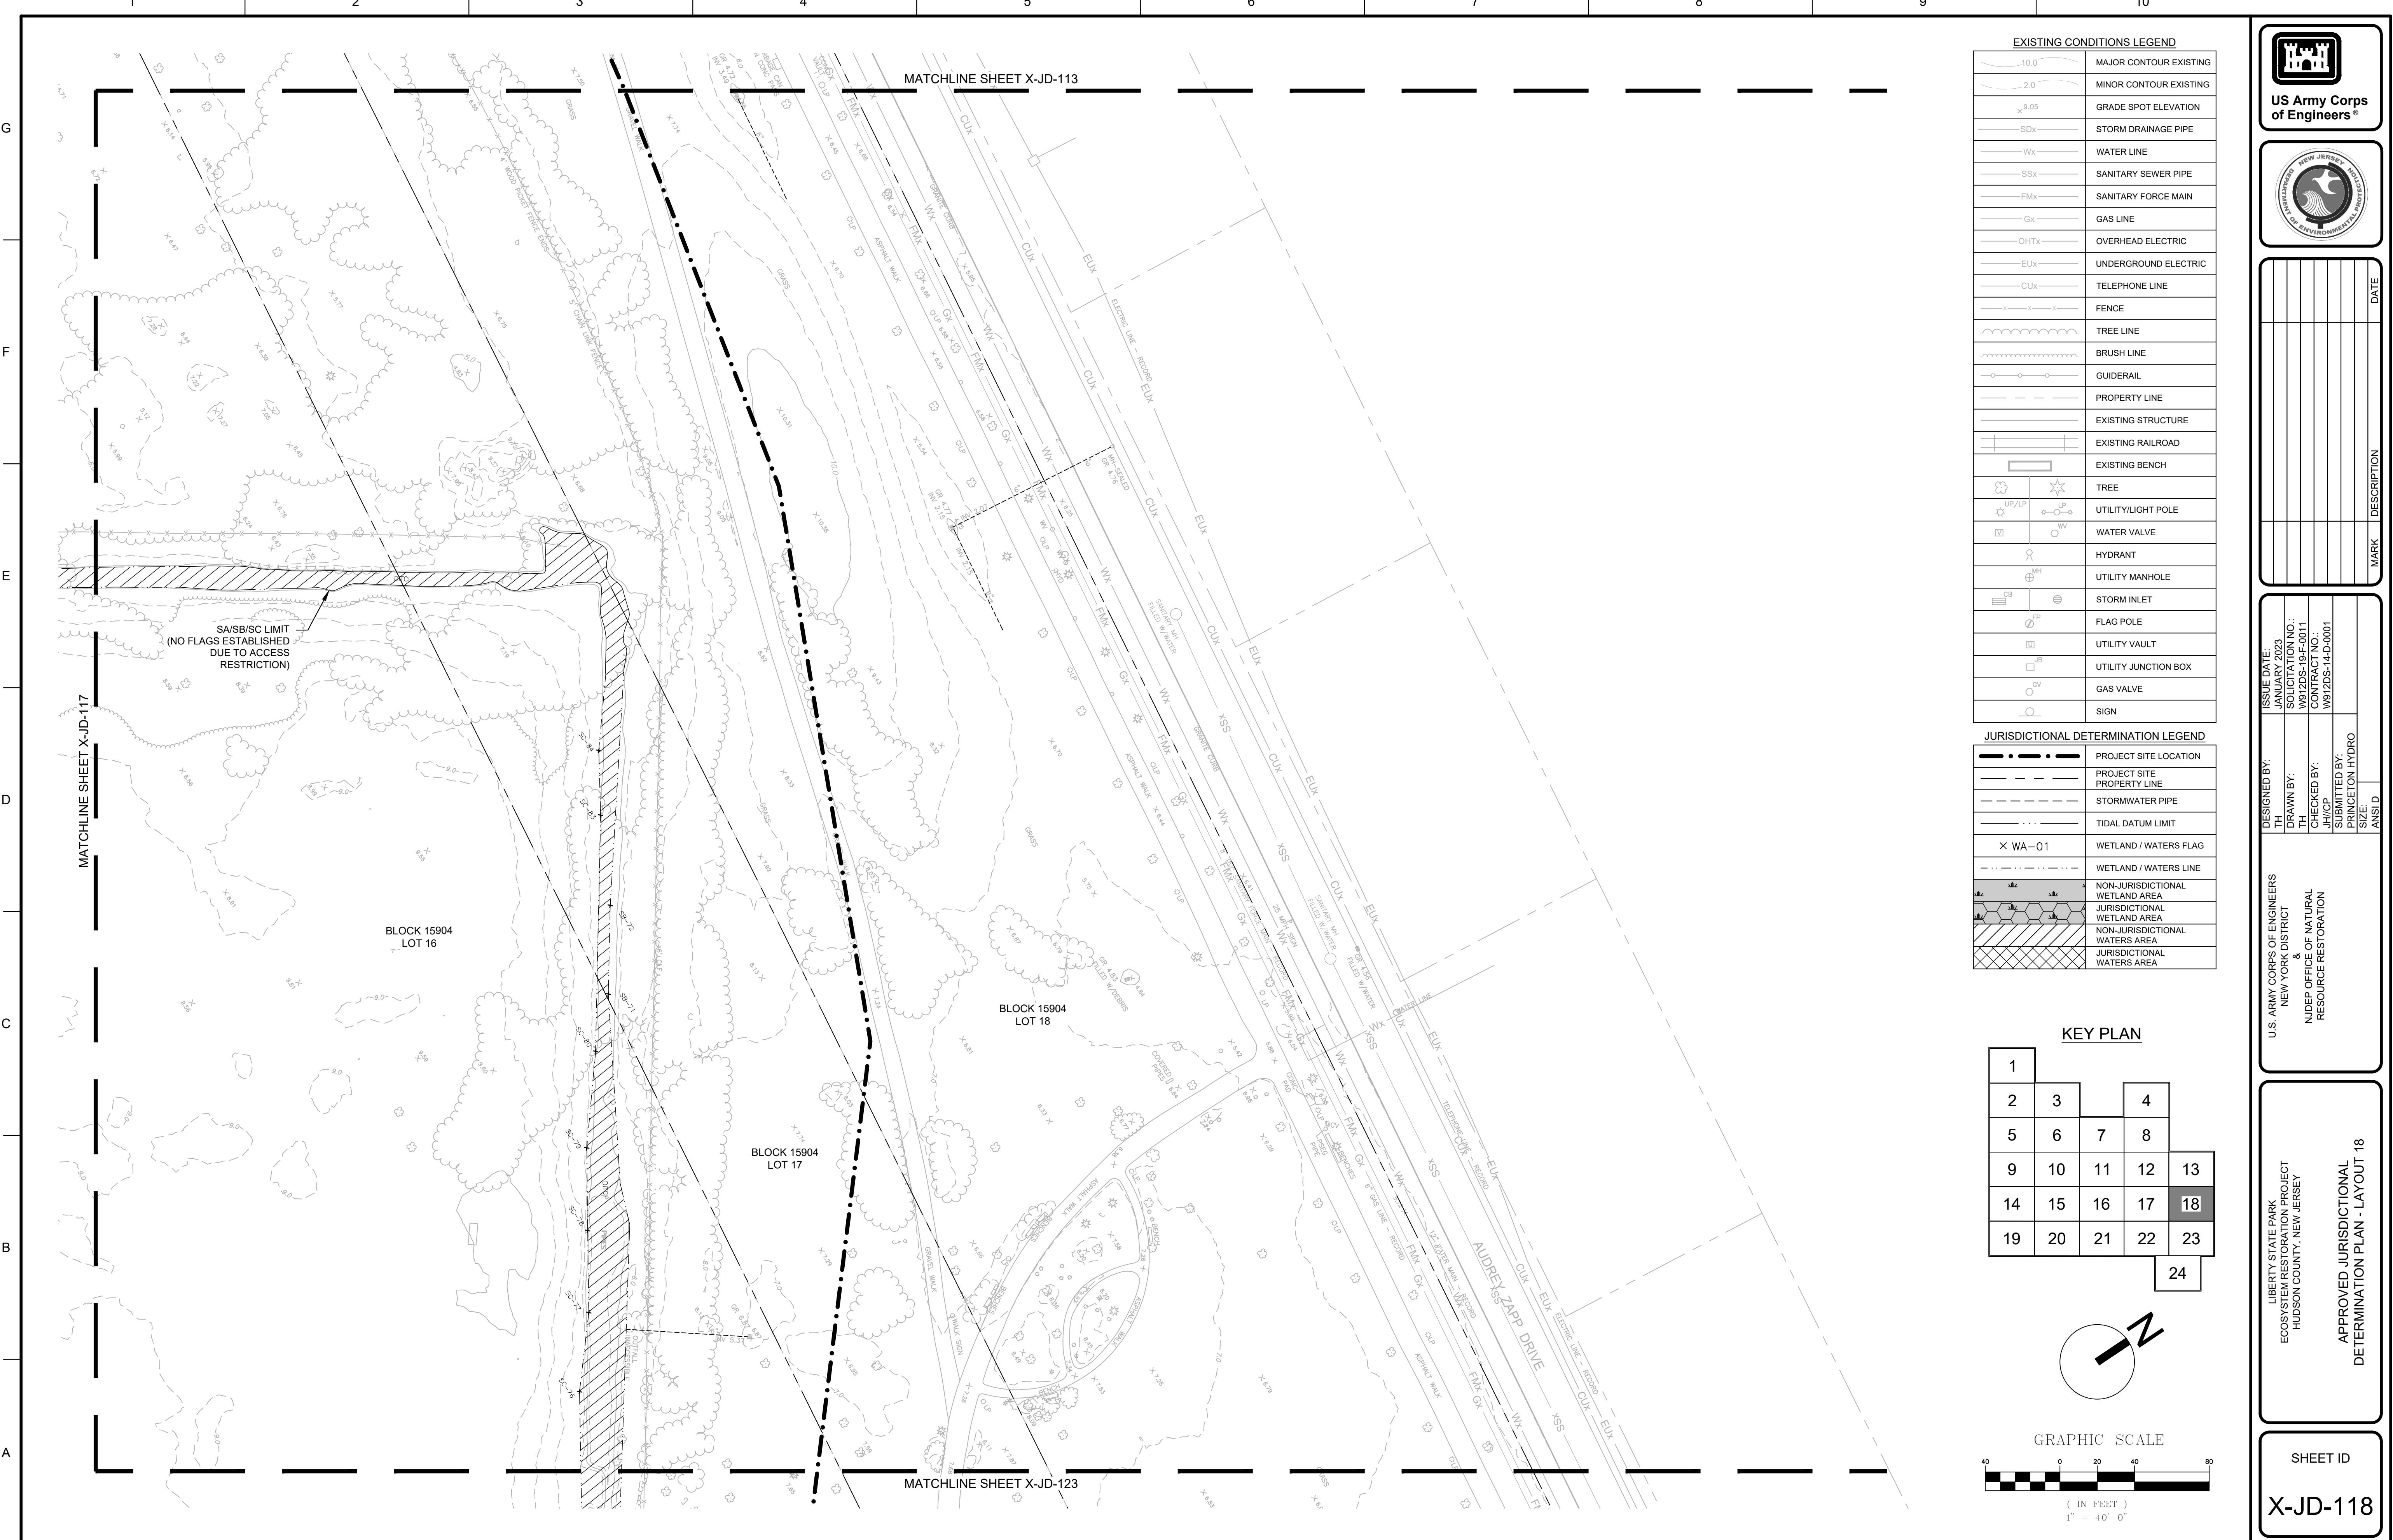

60% CONCEPT - NOT FOR CONSTRUCTION

1 2 3 4 5 6 7 8 9 10

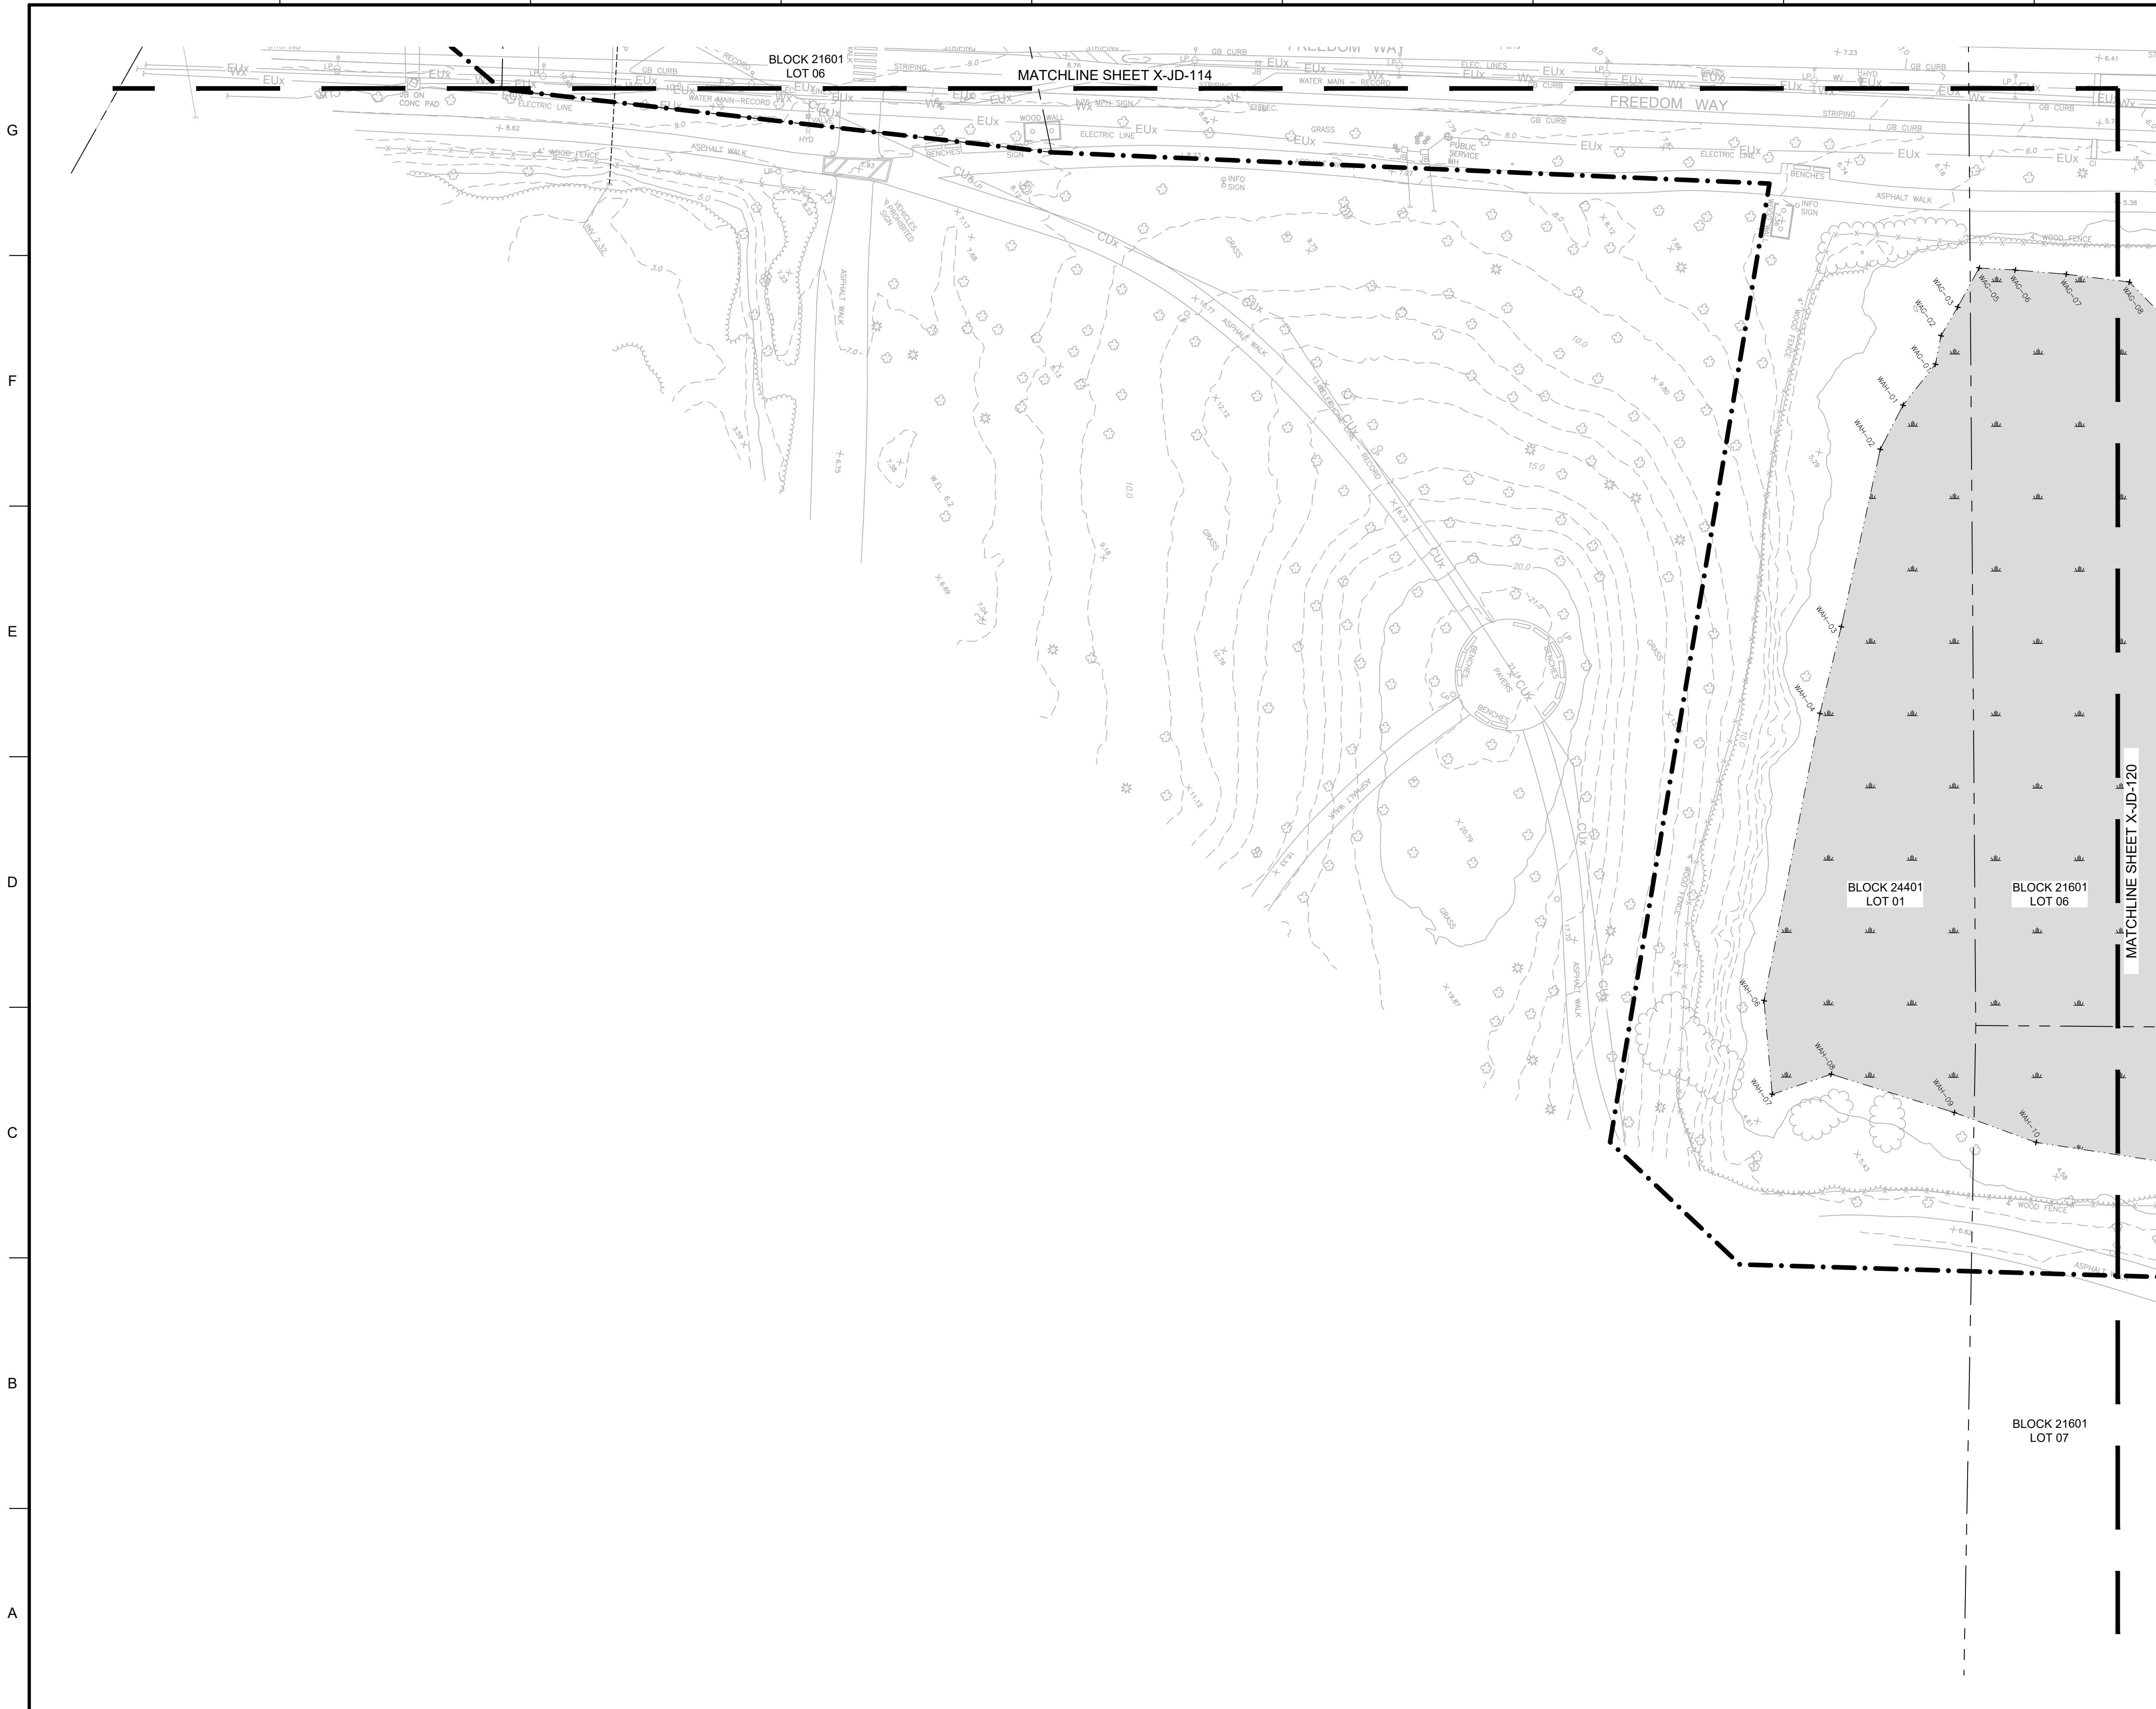

US Army Corps  
of Engineers®



DATE

MARK	DESCRIPTION

DESIGNED BY: TH	ISSUE DATE: JANUARY 2023
DRAWN BY: TH	SOLICITATION NO.: W912DS-19-F-0011
CHECKED BY: JH/CP	CONTRACT NO.: W912DS-14-D-0001
SUBMITTED BY: PRINCETON HYDRO	SIZE: ANSI D


LIBERTY STATE PARK ECO-SYSTEM RESTORATION PROJECT HUDDSON COUNTY, NEW JERSEY

APPROVED JURISDICTIONAL DETERMINATION PLAN - LAYOUT 19

SHEET ID  
**X-JD-119**

60% CONCEPT - NOT FOR CONSTRUCTION

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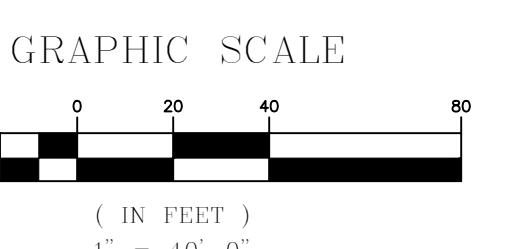
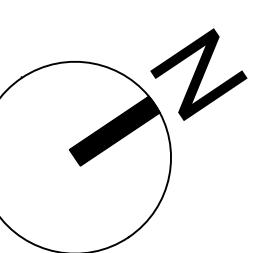


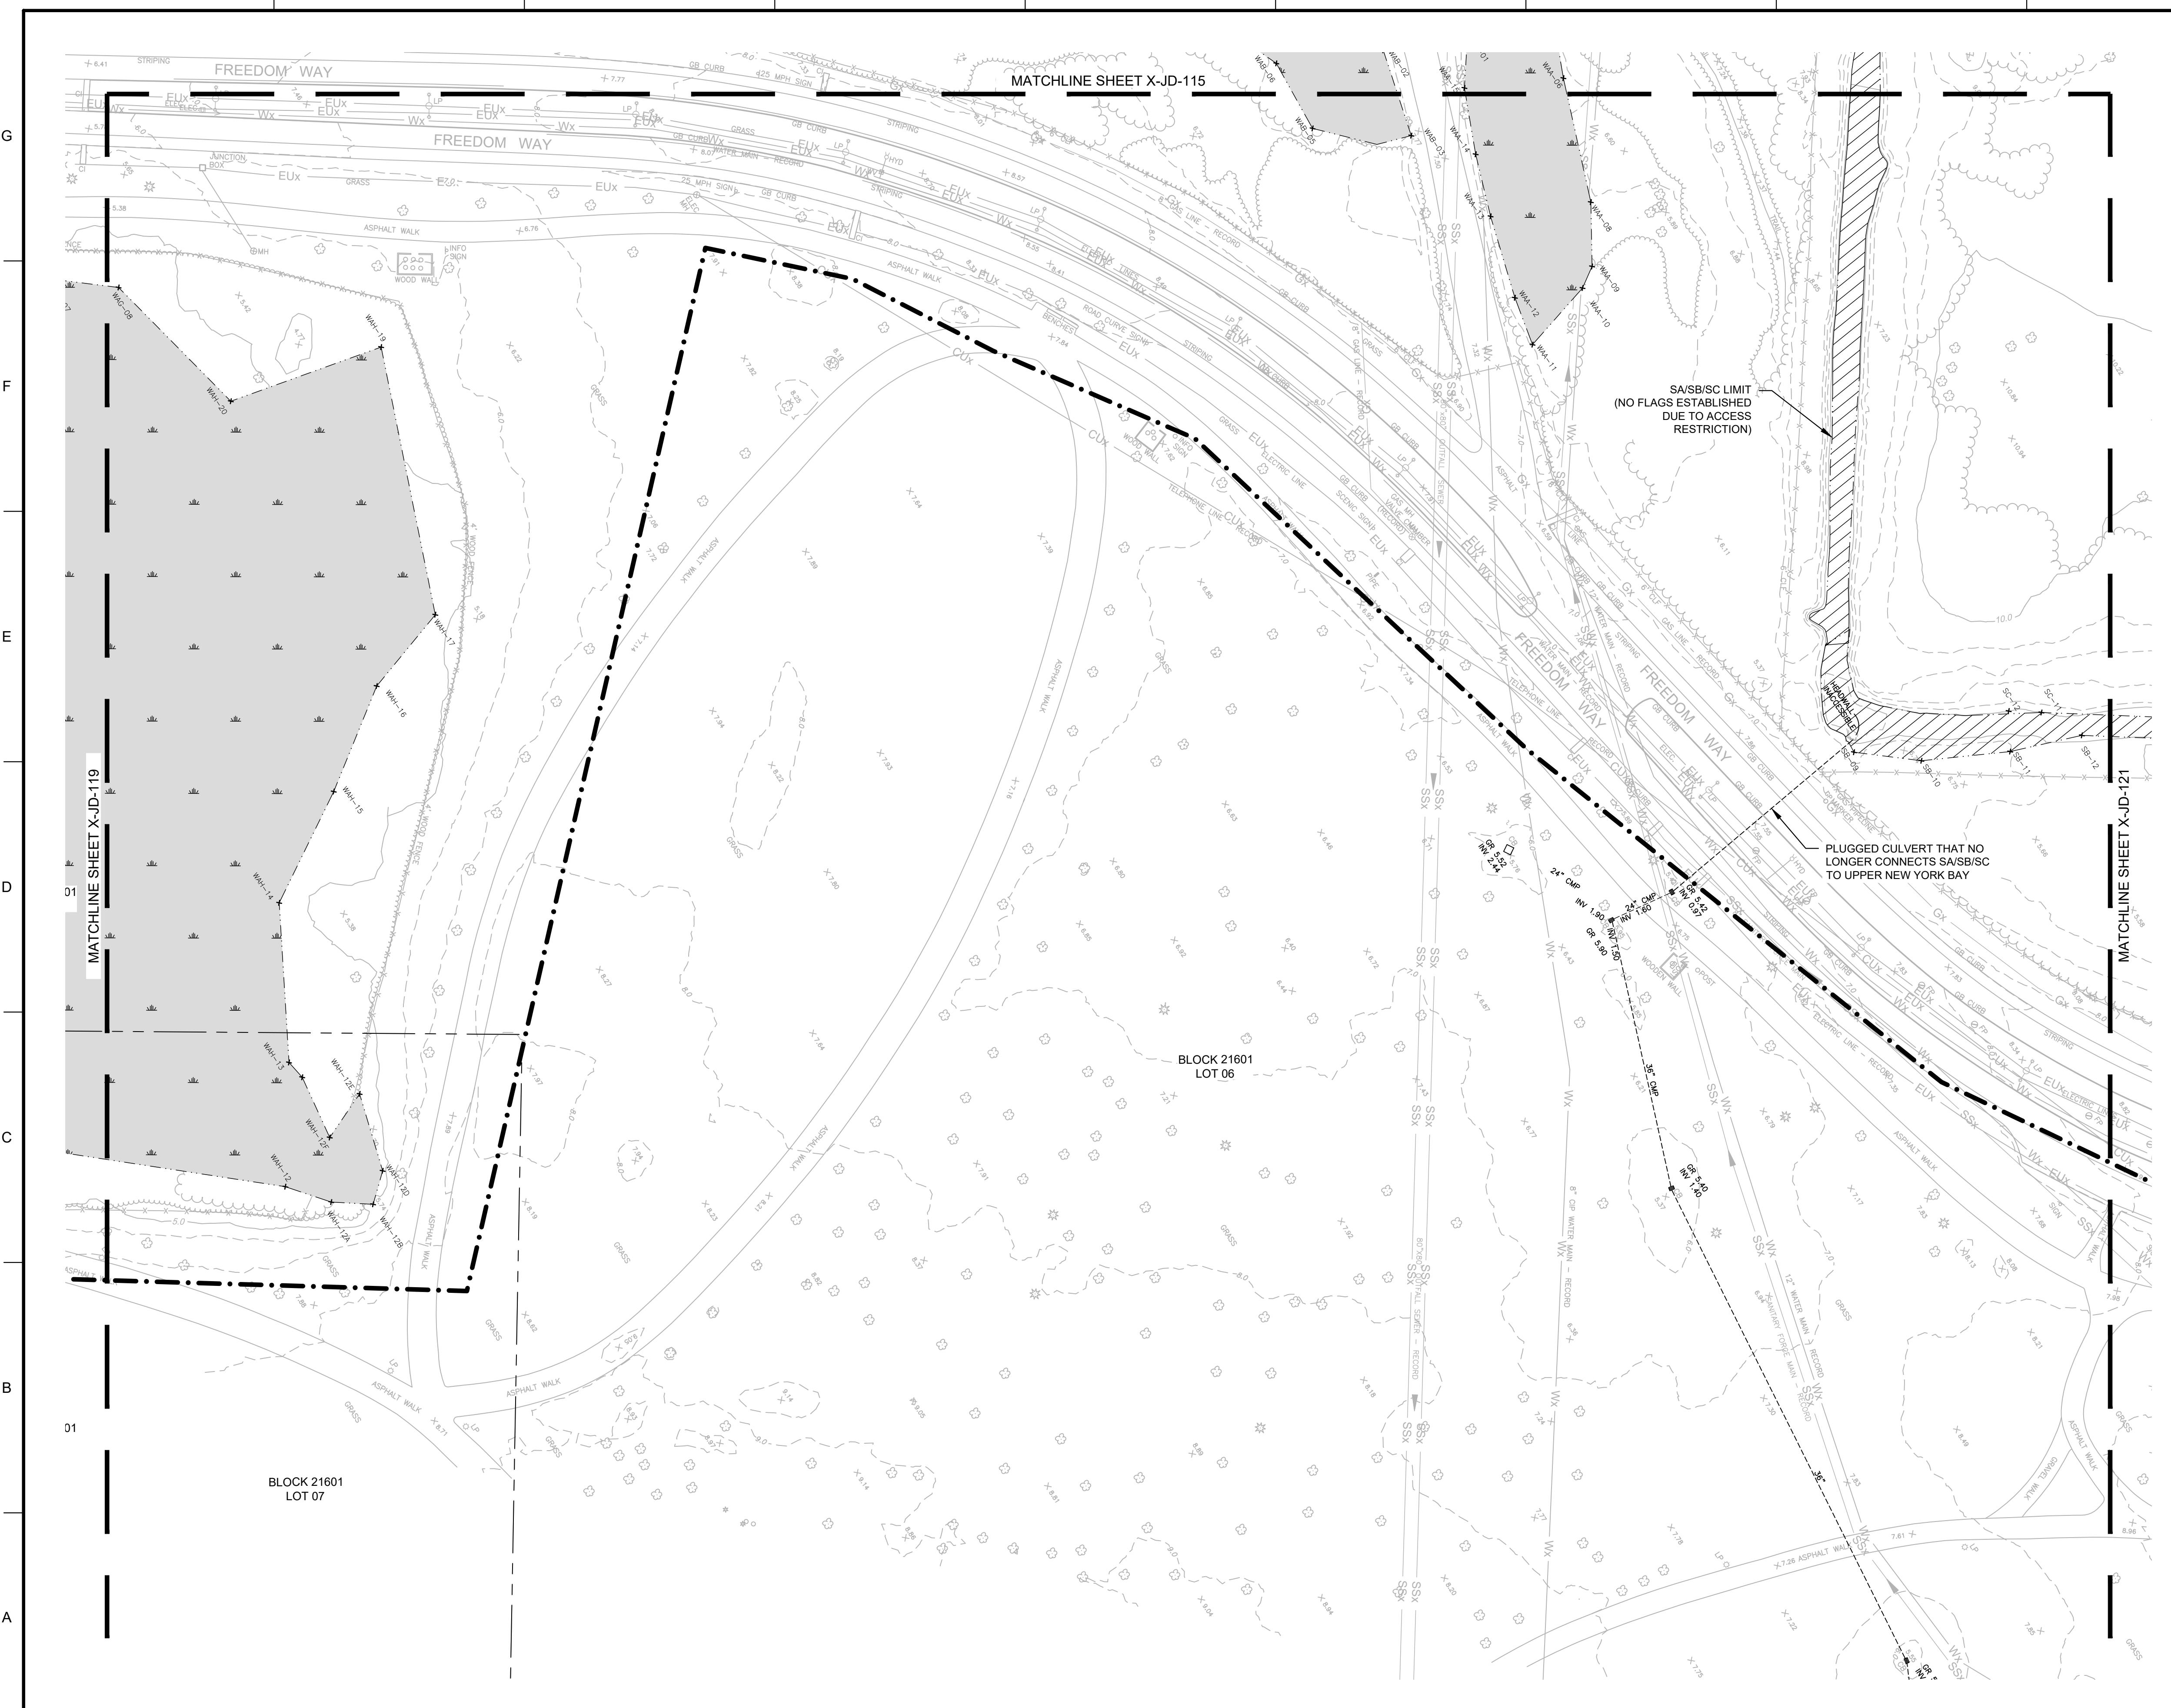	US Army Corps of Engineers®
	NEW JERSEY DEPARTMENT OF ENVIRONMENTAL PROTECTION
DATE	

MARK	DESCRIPTION
■	PROJECT SITE LOCATION
—	PROJECT SITE PROPERTY LINE
- - -	STORMWATER PIPE
—	TIDAL DATUM LIMIT
X	WETLAND / WATERS FLAG
— - -	WETLAND / WATERS LINE
*	NON-JURISDICTIONAL WETLAND AREA
#	JURISDICTIONAL WETLAND AREA
○	NON-JURISDICTIONAL WATERS AREA
△	JURISDICTIONAL WATERS AREA

**KEY PLAN**

1				4
2	3			
5	6	7	8	
9	10	11	12	13
14	15	16	17	18
19	20	21	22	23
				24



LIBERTY STATE PARK  
ECOSYSTEM RESTORATION PROJECT  
HUDSON COUNTY, NEW JERSEY  
APPROVED JURISDICTIONAL  
DETERMINATION PLAN - LAYOUT 20


SHEET ID

X-JD-120

60% CONCEPT - NOT FOR CONSTRUCTION

1 2 3 4 5 6 7 8 9 10

MATCHLINE SHEET X-JD-116

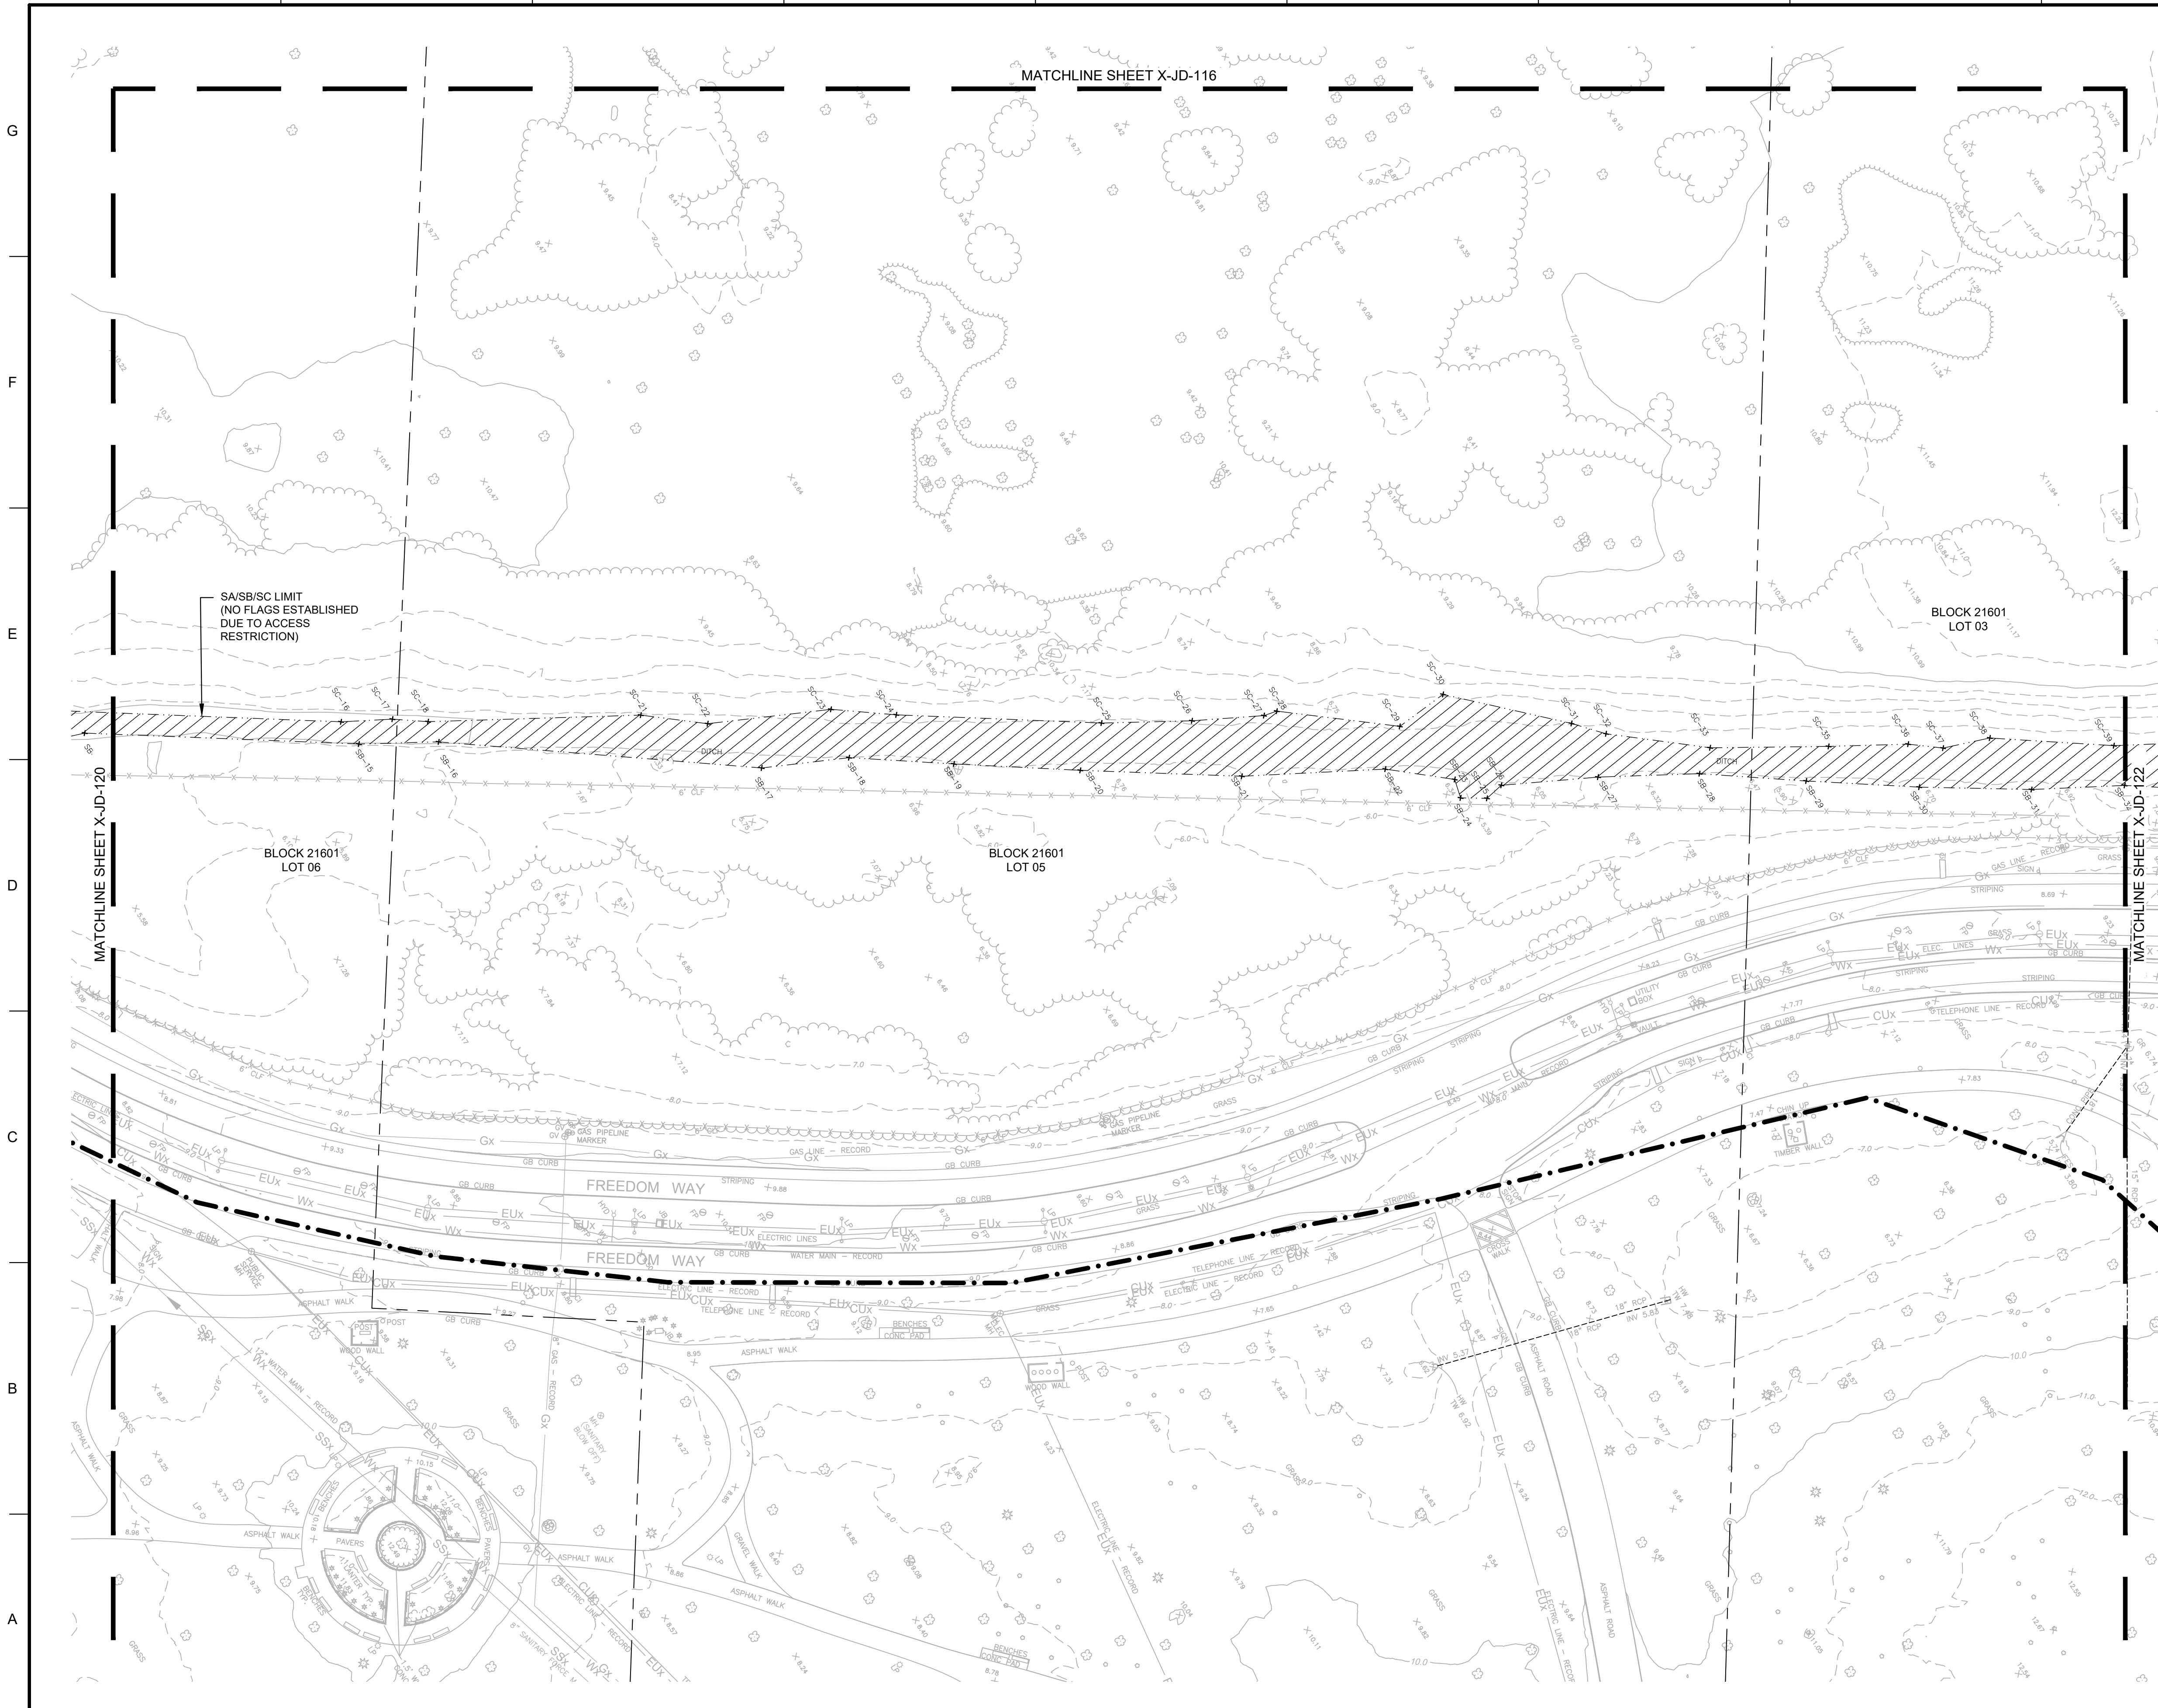

EXISTING CONDITIONS LEGEND

10.0	MAJOR CONTOUR EXISTING
2.0	MINOR CONTOUR EXISTING
x 0.05	GRADE SPOT ELEVATION
SDx	STORM DRAINAGE PIPE
Wx	WATER LINE
SSx	SANITARY SEWER PIPE
FMx	SANITARY FORCE MAIN
Gx	GAS LINE
OHTx	OVERHEAD ELECTRIC
EUX	UNDERGROUND ELECTRIC
CUX	TELEPHONE LINE
x - x - x	FENCE
~ ~	TREE LINE
~~~~~	BRUSH LINE
—○—○—○—	GUIDERAIL
— — —	PROPERTY LINE
— — —	EXISTING STRUCTURE
— — —	EXISTING RAILROAD
— — —	EXISTING BENCH
Tree	TREE
UP/LP	UTILITY/LIGHT POLE
WV	WATER VALVE
Hydrant	HYDRANT
MH	UTILITY MANHOLE
SI	STORM INLET
FP	FLAG POLE
UV	UTILITY VAULT
UJB	UTILITY JUNCTION BOX
GV	GAS VALVE
Sign	SIGN

MARK

DESCRIPTION


DATE

JURISDICTIONAL DETERMINATION LEGEND


— ● —	PROJECT SITE LOCATION
— — —	PROJECT SITE PROPERTY LINE
— — —	STORMWATER PIPE
— — —	TIDAL DATUM LIMIT
X WA-01	WETLAND / WATERS FLAG
— · —	WETLAND / WATERS LINE
■ ■ ■	NON-JURISDICTIONAL WETLAND AREA
■ ■ ■	JURISDICTIONAL WETLAND AREA
■ ■ ■	NON-JURISDICTIONAL WATERS AREA
■ ■ ■	JURISDICTIONAL WATERS AREA

KEY PLAN

1			4
2	3		
5	6	7	8
9	10	11	12
14	15	16	17
19	20	21	22
			23
			24

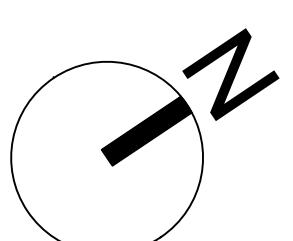

GRAPHIC SCALE

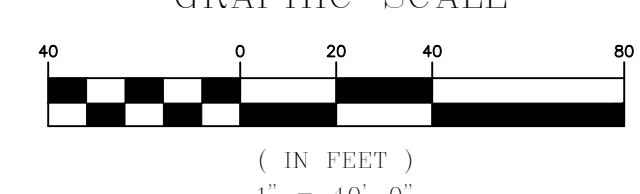

LIBERTY STATE PARK  
ECOSYSTEM RESTORATION PROJECT  
HUDSON COUNTY, NEW JERSEY  
APPROVED JURISDICTIONAL  
DETERMINATION PLAN - LAYOUT 21

SHEET ID  
X-JD-121

