

PUBLIC NOTICE

US Army Corps
of Engineers
New York District
Jacob K. Javits Federal Building
New York, N.Y. 10278-0090
ATTN: Regulatory Branch

In replying refer to:
Public Notice Number: **NAN-2016-01730-EYR**
Issue Date: November 14, 2017
Expiration Date: December 14, 2017

To Whom It May Concern:

The New York District, Corps of Engineers has received an application for a Department of the Army permit pursuant to Section 10 of the Rivers and Harbors Act of 1899 (33 U.S.C. 403) and Section 404 of the Clean Water Act (33 U.S.C. 1344):

APPLICANT: Town of Southampton – Parks Department
Attn: Kristen M. Doulos, Town Parks Director
6 Newtown Road
Hampton Bays, New York 11946

ACTIVITY: Dredge, with 10-years maintenance, an existing swimming area with sand stockpiled on site, dewatered, and placed on the adjacent beach

WATERWAY: Shinnecock Bay, a tributary of the Atlantic Ocean

LOCATION: Hampton Bays, Town of Southampton, Suffolk County, NY

A detailed description and plans of the applicant's activity are enclosed to assist in your review.

The decision whether to issue a permit will be based on an evaluation of the probable impact including cumulative impacts of the proposed activity on the public interest. That decision will reflect the national concern for both protection and utilization of important resources. The benefit which reasonably may be expected to accrue from the proposal must be balanced against its reasonably foreseeable detriments. All factors which may be relevant to the proposal will be considered including the cumulative effects thereof; among those are conservation, economics, aesthetics, general environmental concerns, wetlands, historic properties, fish and wildlife values, flood hazards, floodplain values, land use, navigation, shoreline erosion and accretion, recreation, water supply and conservation, water quality, energy needs, safety, food and fiber production, mineral needs, considerations of property ownership and, in general, the needs and welfare of the people.

The Corps of Engineers is soliciting comments from the public; Federal, state, and local agencies and officials; Indian Tribes; and other interested parties in order to consider and evaluate the impacts of this proposed activity. Any comments received will be considered by the Corps of Engineers to determine whether to issue, modify, condition or deny a permit for this proposal. To make this decision, comments are used to assess impacts on endangered species, historic properties, water quality, general environmental effects, and the other public interest factors listed above. Comments are used in preparation of an Environmental Assessment and/or an Environmental Impact Statement pursuant to the National Environmental Policy Act. Comments are also used to determine the need for a public hearing and to determine the overall public interest of the proposed activity.

ALL COMMENTS REGARDING THE PERMIT APPLICATION MUST BE PREPARED IN WRITING AND MAILED TO REACH THIS OFFICE BEFORE THE EXPIRATION DATE OF THIS NOTICE, otherwise, it will be presumed that there are no objections to the activity.

CENAN-OP-RE
Public Notice NAN-2016-01730-EYR

Comments submitted in response to this notice will be fully considered during the public interest review for this permit application. All written comments, including names and addresses, will be made a part of the administrative record, available to the public under the Freedom of Information Act. The Administrative Record, or portions thereof, may also be posted on a Corps of Engineers internet web site. Due to resource limitations, this office will normally not acknowledge the receipt of comments or respond to individual letters of comment.

Any person may request, in writing, before this public notice expires, that a public hearing be held to collect information necessary to consider this application. Requests for public hearings shall state, with particularity, the reasons why a public hearing should be held. It should be noted that information submitted by mail is considered just as carefully in the permit decision process and bears the same weight as that furnished at a public hearing.

Our preliminary determination is that the activity for which authorization is sought herein is not likely to affect any Federally-endangered or threatened species or their critical habitat. However, pursuant to Section 7 of the Endangered Species Act (16 U.S.C. 1531), the District Engineer is consulting with the appropriate Federal agency to determine the presence of and potential impacts to listed species in the project area or their critical habitat.

The Magnuson-Stevens Fishery Conservation and Management Act, as amended by the Sustainable Fisheries Act (Public Law 104-267), requires all Federal agencies to consult with the National Oceanic and Atmospheric Administration Fisheries Service (NOAA/FS) on all actions, or proposed actions, permitted, funded, or undertaken by the agency, that may adversely affect Essential Fish Habitat (EFH). The proposed construction work, fully described in the enclosed Work Description, could cause minimum disruption of habitat for various life stages of some EFH-designated species as a result of a minor short-term temporary increase in turbidity during construction. However, the New York District has made the preliminary determination that the site-specific minor adverse effects are not likely to be substantial because it is expected that fish populations would avoid the small area of minor disturbance. Further consultation with NOAA/FS regarding EFH impacts and conservation recommendations is being conducted and will be concluded prior to the final decision on this permit application.

Based upon a review of the latest published version of the National Register of Historic Places, there are no known sites eligible for, or included in, the Register within the permit area. Presently unknown archeological, scientific, prehistorical, or historical data may be lost by work accomplished under the required permit.

Review of activities pursuant to Section 404 of the Clean Water Act will include application of the guidelines promulgated by the Administrator, U.S. Environmental Protection Agency, under authority of Section 404 (b) of the Clean Water Act and the permit applicant will obtain a water quality certificate or waiver from the appropriate state agency in accordance with Section 401 of the Clean Water Act prior to a permit application decision.

Pursuant to Section 307 (c) of the Coastal Zone Management Act of 1972 as amended [16 U.S.C. 1456 (c)], for activities under consideration that are located within the coastal zone of a state which has a federally approved coastal zone management program, the applicant has certified in the permit application that the activity complies with, and will be conducted in a manner that is consistent with, the approved state coastal zone management program. By this public notice, we are requesting the state's concurrence with, objection to, or waiver of the applicant's certification.

No permit decision will be made until one of these actions occurs. For activities within the coastal zone of New York, the applicant's certification and accompanying information is available from the

*****PLEASE USE THE 18-CHARACTER FILE NUMBER ON ALL CORRESPONDENCE WITH
THIS OFFICE*****

CENAN-OP-RE
Public Notice NAN-2016-01730-EYR

New York State Department of State Division of Coastal Resources, Coastal Management Program, 99 Washington Avenue – Suite 1010, Albany, New York 12231-0001, Telephone (518) 474-6000. Comments regarding the applicant's certification, and copies of any letters to this office commenting upon this proposal, should be so addressed.

In addition to any required water quality certificate and coastal zone management program concurrence, the applicant has obtained or requested the following governmental authorization for the activity under consideration:

- New York State Department of Environmental Conservation

It is requested that you communicate the foregoing information concerning the activity to any persons known by you to be interested and who did not receive a copy of this notice.

If you have any questions concerning this application, you may contact Dr. Stephen Knowles at (917) 790-8715.

In order for us to better serve you, please complete our Customer Service Survey located at <http://www.nan.usace.army.mil/Missions/Regulatory/CustomerSurvey.aspx>. For more information on New York District Corps of Engineers programs, visit our website at <http://www.nan.usace.army.mil>.


For and In behalf of

Stephan A. Ryba
Chief, Regulatory Branch

Enclosures

WORK DESCRIPTION

The applicant, Town of Southampton Parks Department, has requested Department of the Army (DA) authorization to conduct dredging, with ten-years maintenance, to maintain a recreational swimming area. All resultant dredged material will be placed on the adjacent beach. The project is located on the south shore of Shinnecock Bay, at Tiana Bayside Beach in Hampton Bays, Town of Southampton, Suffolk County, New York.

Dredge, using a clamshell bucket dredge, approximately 650-cubic yards of shoaled sediments from two (2) irregular-shaped swimming areas totaling approximately 12,500-square feet, to a maximum depth of -3.0 feet below the Plane of Mean Low Water with placement of all resultant dredged material on the adjacent beach. Dredged material will be initially placed at an onsite, upland containment area for dewatering, with return flow to Shinnecock Bay. After dewatering, approximately 550 cubic yards will be placed below the Plane of Spring High Water, along approximately 375 feet of the Shinnecock Bay shoreline, comprising an area of approximately 16,800 square feet. Approximately 100 cubic yards of dredged material will be placed landward of Spring High Water along approximately 375 feet of the Shinnecock Bay shoreline. Four (4) additional maintenance dredging events are estimated to be undertaken during the 10-year life of the permit.

The applicant has stated that they have avoided, minimized, and mitigated for potential impacts proposed, to the maximum extent practicable, by limiting the dredging area to the minimum area required for safe recreation at Tiana Bayside Beach. Any potential impacts would be temporary and would be offset by implementing best management practices associated with the proposed use of a clamshell dredge.

The stated purpose of this project is to maintain the swimming area at Tiana Bayside Beach to provide safe recreation, as well as to provide sand nourishment for erosion and flood protection for the adjacent beach.



LOCATION MAP
 SCALE: 1"=2,000'
 NYS DOT QUADRANGLE MAP
 QUOGUE - 1:24000

APPLICANT: TOWN OF SOUTHAMPTON - PARKS DEPARTMENT
 C/O KRISTEN M. DOULOS, TOWN PARKS DIRECTOR
 6 NEWTOWN ROAD
 HAMPTON BAYS, N.Y. 11945

APPLICATION NO.: USACE: NAN-2016-01730-EYR
 NYS DEC: 1-4736-06883/00005

PURPOSE: 10 YEAR MAINTENANCE DREDGING OF TIANA BAYSIDE BEACH SWIMMING AREA WITH UPLAND PLACEMENT OF ALL RESULTANT DREDGED MATERIAL.

ACCESS: BY WATER USING BARGE AND BY LAND THROUGH APPLICANTS PROPERTY.

PROPOSED WORK: DREDGE, WITH 10-YEAR MAINTENANCE, AN EXISTING SWIMMING AREA AT TIANA BAYSIDE BEACH IN HAMPTON BAYS, TOWN OF SOUTHAMPTON, SUFFOLK COUNTY, N.Y. DREDGE, VIA CLAMSHELL BUCKET DREDGE, APPROXIMATELY 650 C.Y. OF SHOALED SEDIMENTS FROM TWO (2) IRREGULAR SHAPED SWIMMING AREAS TOTALING 12,500 S.F., TO A MAXIMUM DEPTH OF -3.0- FEET NAVD 88 DATUM, WITH PLACEMENT OF ALL RESULTANT DREDGED MATERIAL AT AN UPLAND CONTAINMENT AREA FOR FUTURE BEACH PLACEMENT ALONG THE SHINNECOCK BAY SHORELINE. RETURN FLOW TO THE WATERWAY IS PROPOSED. FOUR (4) ADDITIONAL MAINTENANCE DREDGING EVENTS ARE ESTIMATED TO BE UNDERTAKEN DURING THE 10-YEAR LIFE OF THE PERMIT. ALL DREDGING AND PLACEMENT ACTIVITIES ARE PROPOSED TO BE UNDERTAKEN BETWEEN 16 MAY AND 31 MAY PRIOR TO THE ONSET OF THE BATHING SEASON.

01/16/2017	TH	USACE COMMENTS DATED 6/13/2017	VAG
01/06/2017	TH	WETLAND BOUNDARY AND MEASUREMENT DETAIL	VAG
DATE	BY	DESCRIPTION	APPROV

REVISIONS


TOWN OF SOUTHAMPTON
 116 HAMPTON ROAD
 SOUTHAMPTON, NY 11958

TIANA BAYSIDE BEACH
 69 JUNE ROAD, HAMPTON BAYS, NY 11946
 TAX MAP NO. 000-586-00-01-00-0000

LOCATION MAP			
THE RAYNOR GROUP, P.E. & L.S., P.L.C. SURVEYORS CIVIL ENGINEERS SITE PLANNERS DEERFIELD GREEN WATERMILL, NY 11878 P.O. BOX 720 (516) 726-7622			
DESIGNED BY:	VAG	SCALE:	AS NOTED
DRAWN BY:	TH	DATE:	10/1/2016
APPROVED BY:	VAG	FILE NO.:	3336
			C-1

VINCENT A. GIARDOLLO
 PROFESSIONAL ENGINEERING NO. 03624

NAN-2016-01730-EYR

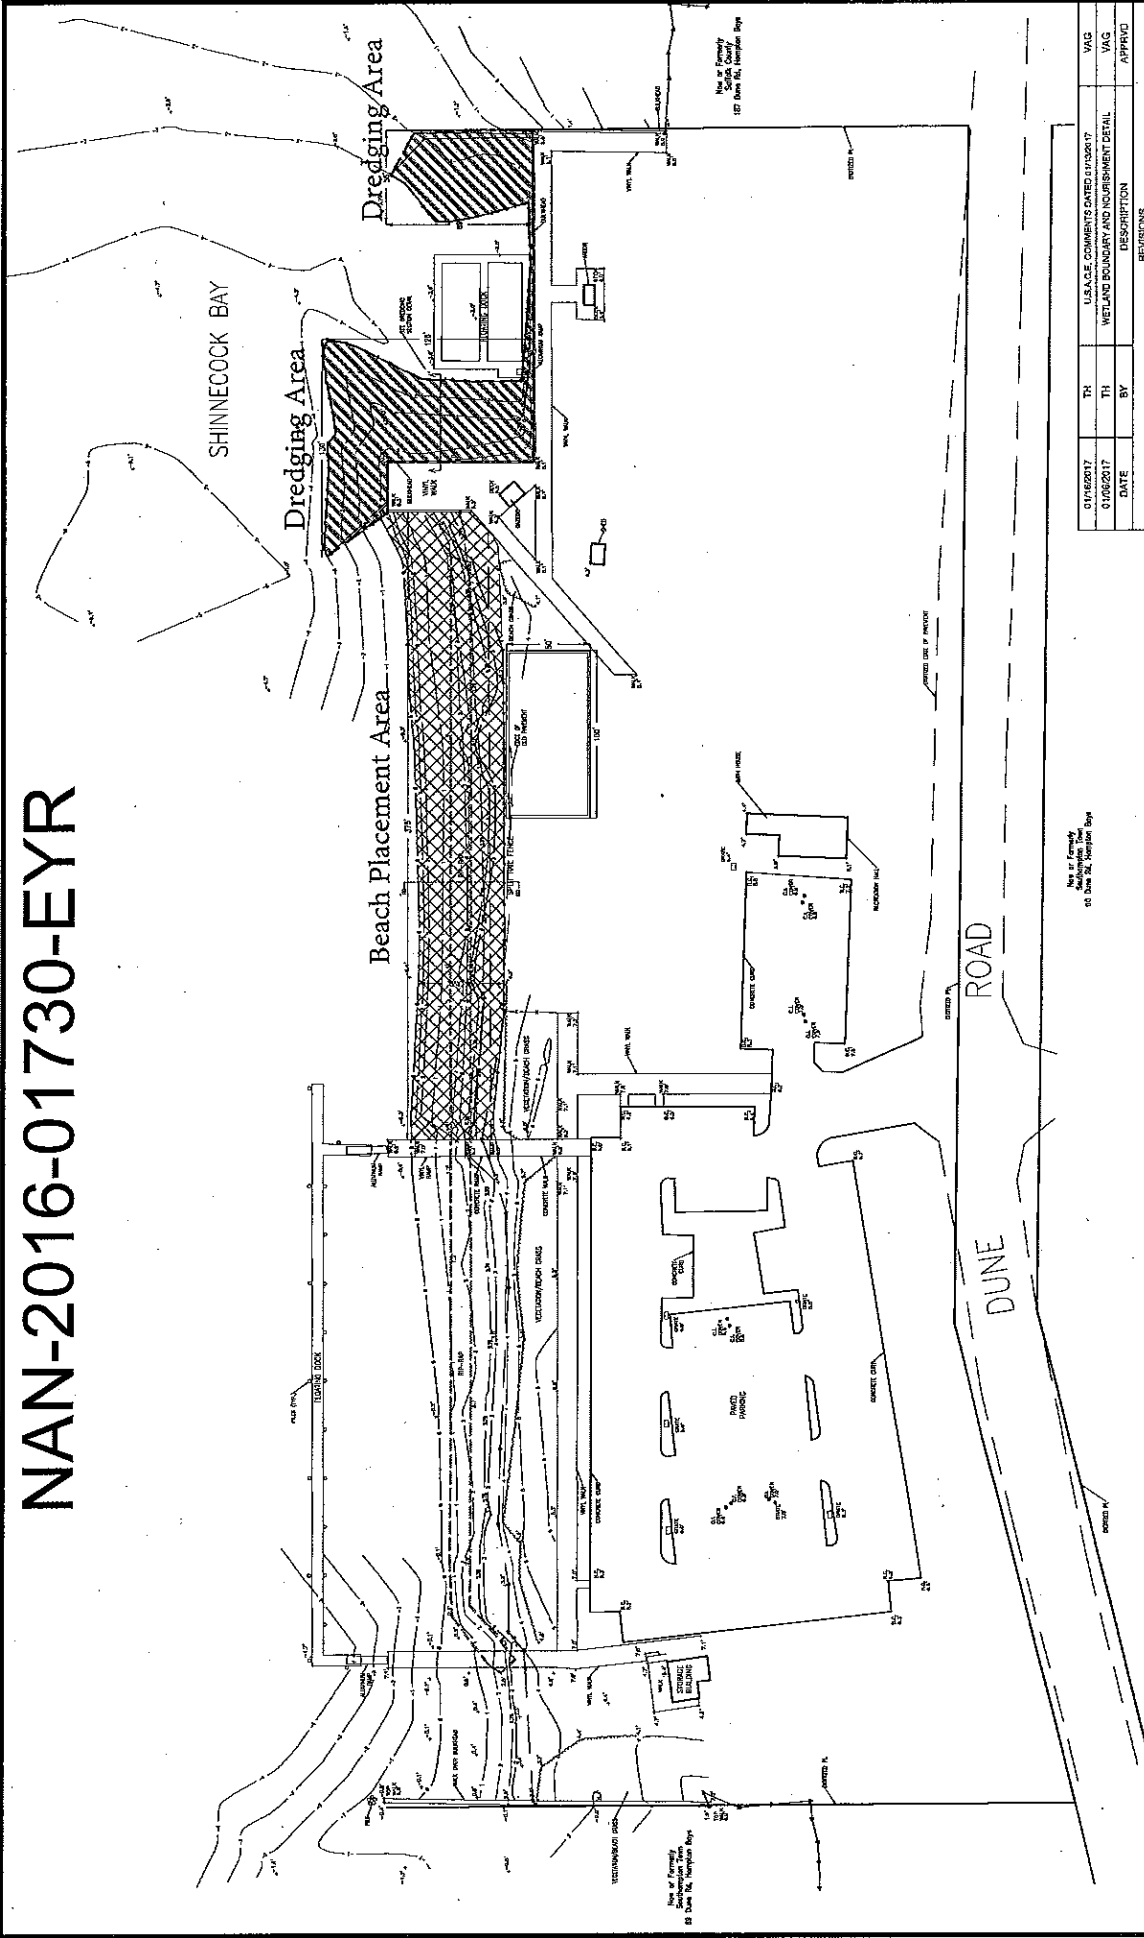

TR	01/16/2017	U.S.A.C.E. COMMENTS DATED 01/16/2017	VAG
TH	01/09/2017	WETLAND BOUNDARY AND NOURISHMENT DETAIL	VAG
BY		DESCRIPTION	APPROV
DATE		RESTRICTIONS	

TOWN OF SOUTHAMPTON
116 HAMPTON ROAD
SOUTHAMPTON, NY 11968

TIANA BAYSIDE BEACH
88 DUNE ROAD, HAMPTON BAYS, NY 11948
TAX MAP NO.: 0900-386.00-01-00-028.000

SITE PLAN

THE BAYNOR GROUP, P.E. & S. PLLC
SURVEYORS CIVIL ENGINEERS SITE PLANNERS
DEERFIELD GREEN
WATER MILL, NY 11978
P.O. BOX 720
(631) 284-7800

DESIGNED BY: VAG SCALE: 1" = 110'
DRAWN BY: TH DATE: 10/01/2016
APPROVED BY: VAG FILE NO.: 5028

C-2

VINCENT A. GARDIELLO
PROFESSIONAL ENGINEERING DESIGNER


- GENERAL NOTES:**
- PERMIT ID. NO.: USACE: NAN-2016-01730-EYR
NYS DEC: 1-4736-06683/00005
1. TYPE OF DREDGING: MAINTENANCE
 2. METHOD OF DREDGING: CLAMSHELL BUCKET
 3. APPROX. AMOUNT TO BE DREDGED: 650 CU. YDS.
 4. TYPE OF MATERIAL TO BE DREDGED: SHOALED SEDIMENTS
 5. MATERIAL PLACEMENT LOCATION: BEACH NOURISHMENT ON SHINNECOCK BAY SHORELINE
 6. VERTICAL DATUM TAKEN FROM: MAP BY L.K. McLEAN ASSOCIATES, P.C. ENTITLED "MAINTENANCE DREDGE PLAN DATED SEPTEMBER 5, 2007, SHEET 1 OF 1"
 7. MEAN LOW AND HIGH TIDE AVERAGE CALCULATED FROM TIDE MEASUREMENTS TAKE AT PONQUICQUE BRIDGE, SHINNECOCK BAY FROM 08-15-2016 THROUGH 08-19-2016.

NAN-2016-01730-EYR

SHINNECOCK BAY

Dredging of approximately 650 cubic yards of sand and gravel to a maximum depth of -3.0 feet MLW from an area of approximately 12,500 square feet

LEGEND	
	DREDGE AREA
	FILL AREA
	TIDAL WETLANDS BOUNDARY
	PHOTO

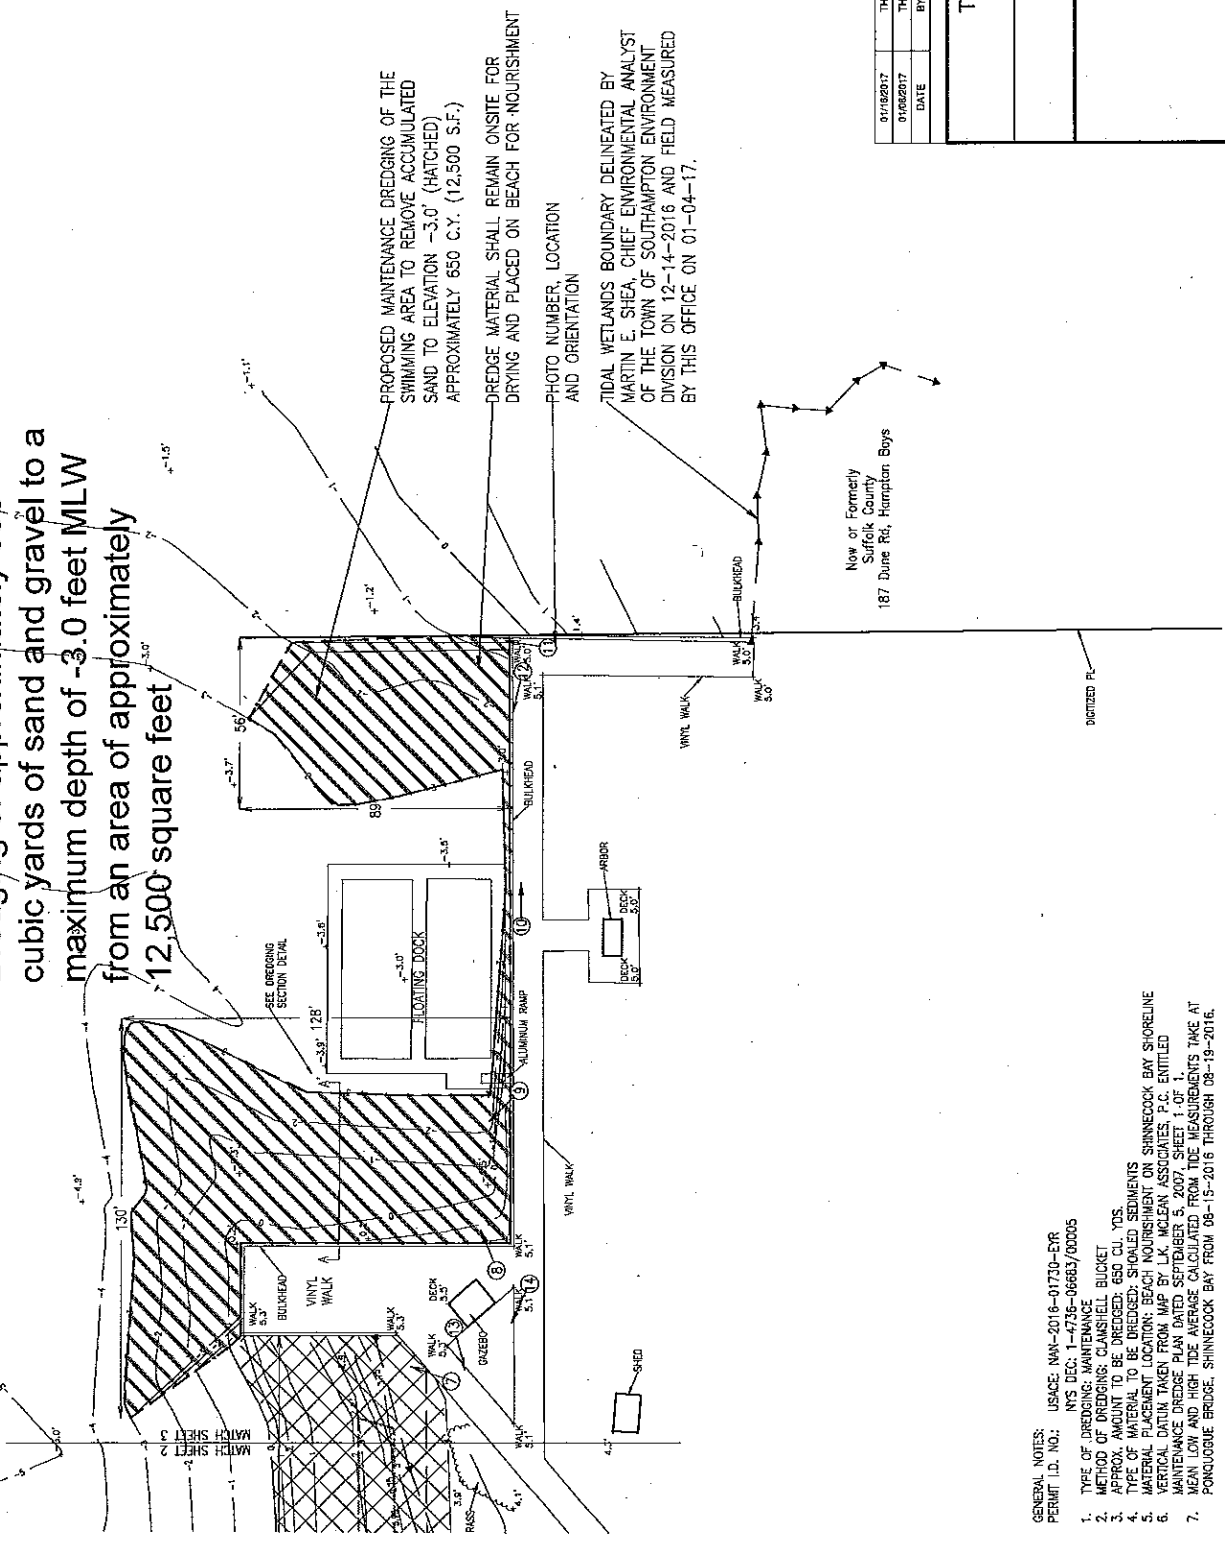

GENERAL NOTES:
 PERMIT I.D. NO.: NYS DEC: 1-4736-06683/00005
 NYS DEC: NAN-2016-01730-EYR

1. TYPE OF DREDGING: MAINTENANCE
2. METHOD OF DREDGING: CLAM-SHELL BUCKET
3. APPROX. AMOUNT TO BE DREDGED: 650 CU. YDS.
4. MATERIALS TO BE DREDGED: SAND, GRAVEL, CLAY, SILT, AND FINE SEDIMENTS
5. DATE OF MEASUREMENT: 01/04/2017
6. MAP DATA TAKEN FROM MAP BY THE NEW YORK ASSOCIATES OF PROFESSIONAL ENGINEERS, INC. ENTITLED "MAINTENANCE DREDGE PLAN DATED SEPTEMBER 5, 2016 SHEET 1 OF 1"
7. MEAN LOW AND HIGH TIDE AVERAGE CALCULATED FROM THE MEASUREMENTS TAKE AT PONDQUOGUE BRODGE, SHINNECOCK BAY FROM 08-15-2016 THROUGH 08-19-2016.

DATE	BY	DESCRIPTION	REVISIONS
01/02/2017	TH	USACE COMMENTS DATED 01/02/2017	VAG
01/02/2017	TH	WETLAND BOUNDARY AND NOURISHMENT DETAIL	VAG
			APPRD

TOWN OF SOUTHAMPTON	
114 HAMPTON ROAD SOUTHAMPTON, NY 11988	
TIANA BAYSIDE BEACH	
88 DUNE ROAD, HAMPTON BAYS, NY 11946 TAX MAP NO.: 0906-086,00-01,00-029,000	

MAINTENANCE DREDGE PLAN			
THE HAYNOR GROUP, P.E. I.L.S. P.L.C. SULFUR SPRINGS, CIVIL ENGINEERS SITE PLANNERS P.O. BOX 726 DEERFIELD GREEN WATER MILL, NY 11976		DWG. NO. 1-16-17	
DESIGNED BY: VAG	SCALE: 1" = 60'	DATE: 10/21/2016	FILE NO.: 2228
DRAWN BY: TH			
APPROVED BY: VAG			

NAN-2016-01730-EYR

- GENERAL NOTES:**
1. USACE: NAN-2016-01730-EYR PERMIT I.D. NO.
 2. NYS DEC: 1-4735-06637/00005
 3. TYPE OF DREDGING: MAINTENANCE BUCKET
 4. APPROX. AMOUNT TO BE DREDGED: 650 CU. YDS.
 5. TYPE OF MATERIAL TO BE DREDGED: SHOALED SEDIMENTS
 6. MATERIAL PLACEMENT LOCATION: BEACH NOURISHMENT ON SHINNECOCK BAY SHORELINE
 7. MATERIAL PLACEMENT DATE: SEPTEMBER 5, 2007, SHEET 1 OF 1
 8. VERTICAL CURVE: PAVEMENT PLAN DATED SEPTEMBER 5, 2007, SHEET 1 OF 1
 9. MEAN LOW WATER: TIDE MEASUREMENTS TAKE AT KEAYON POINT BRIDGE. TIDE RANGE CALCULATED FROM TIDE MEASUREMENTS TAKE AT PONDQUOQUE BRIDGE, SHINNECOCK BAY FROM 08-15-2016 THROUGH 08-19-2016.

Approximately 550 cubic yards will be placed below the Plane of Spring High Water across an area of approximately 16,800 square feet. Approximately 100 cubic yards will be placed above the plane of Spring High Water.

PROPOSED NOURISHMENT CONTOURS
 PROPOSED FILL AREA FOR BEACH NOURISHMENT APPROXIMATELY 20,177 S.F.
 650 C.Y. - (DRY) (SEE SECTION) (CROSS-HATCHED)

S.H.W. CONTOUR ELEVATION ($\pm 3.0'$)
 M.H.W. CONTOUR ELEVATION ($\pm 2.75'$)
 M.L.W. CONTOUR ELEVATION ($\pm 0.06'$)

SEE NOURISHMENT CROSS SECTION DETAIL

PROPOSED DREDGE SPOIL LOCATION (SEE DETAIL)

Placement of Approximately 650 cubic yards of sand:
 Approximately 100 cubic yards above the Plane of Spring High Water
 Approximately 550 cubic yards below the Plane of Spring High Water

LEGEND

- DREDGE AREA
- FILL AREA
- TIDAL WETLANDS BOUNDARY
- PHOTO

TH	DATE	DESCRIPTION	APPROVED
01/16/2017		USACE COMMENTS DATED 01/03/07	VAG
01/06/2017		WETLAND BOUNDARY AND NOURISHMENT DETAIL	VAG

TOWN OF SOUTHAMPTON
 17th HAMPTON ROAD
 SOUTHAMPTON, NY 11988


TIANA BAYSIDE BEACH
 88 JUNE ROAD, HAMPTON BAYS, NY 11948
 TAX MAP NO.: 9800-988-00-01-00-020-000

DRYING & NOURISHMENT PLAN

THE BEAVER GROUP, P.E. & L.S. PLLC
 1000 WEST 10TH AVENUE
 GREENSBORO, NC 27407-7300
 (336) 726-7600

DESIGNED BY: VAG
 DRAWN BY: TH
 SCALE: 1" = 40'
 DATE: 10/3/2018
 DWG. NO.: C-4
 APPROVED BY: VAG
 FILE NO.: 2829

VINCENT A. GAMBRIELLO
 PROFESSIONAL ENGINEER NO. 07954

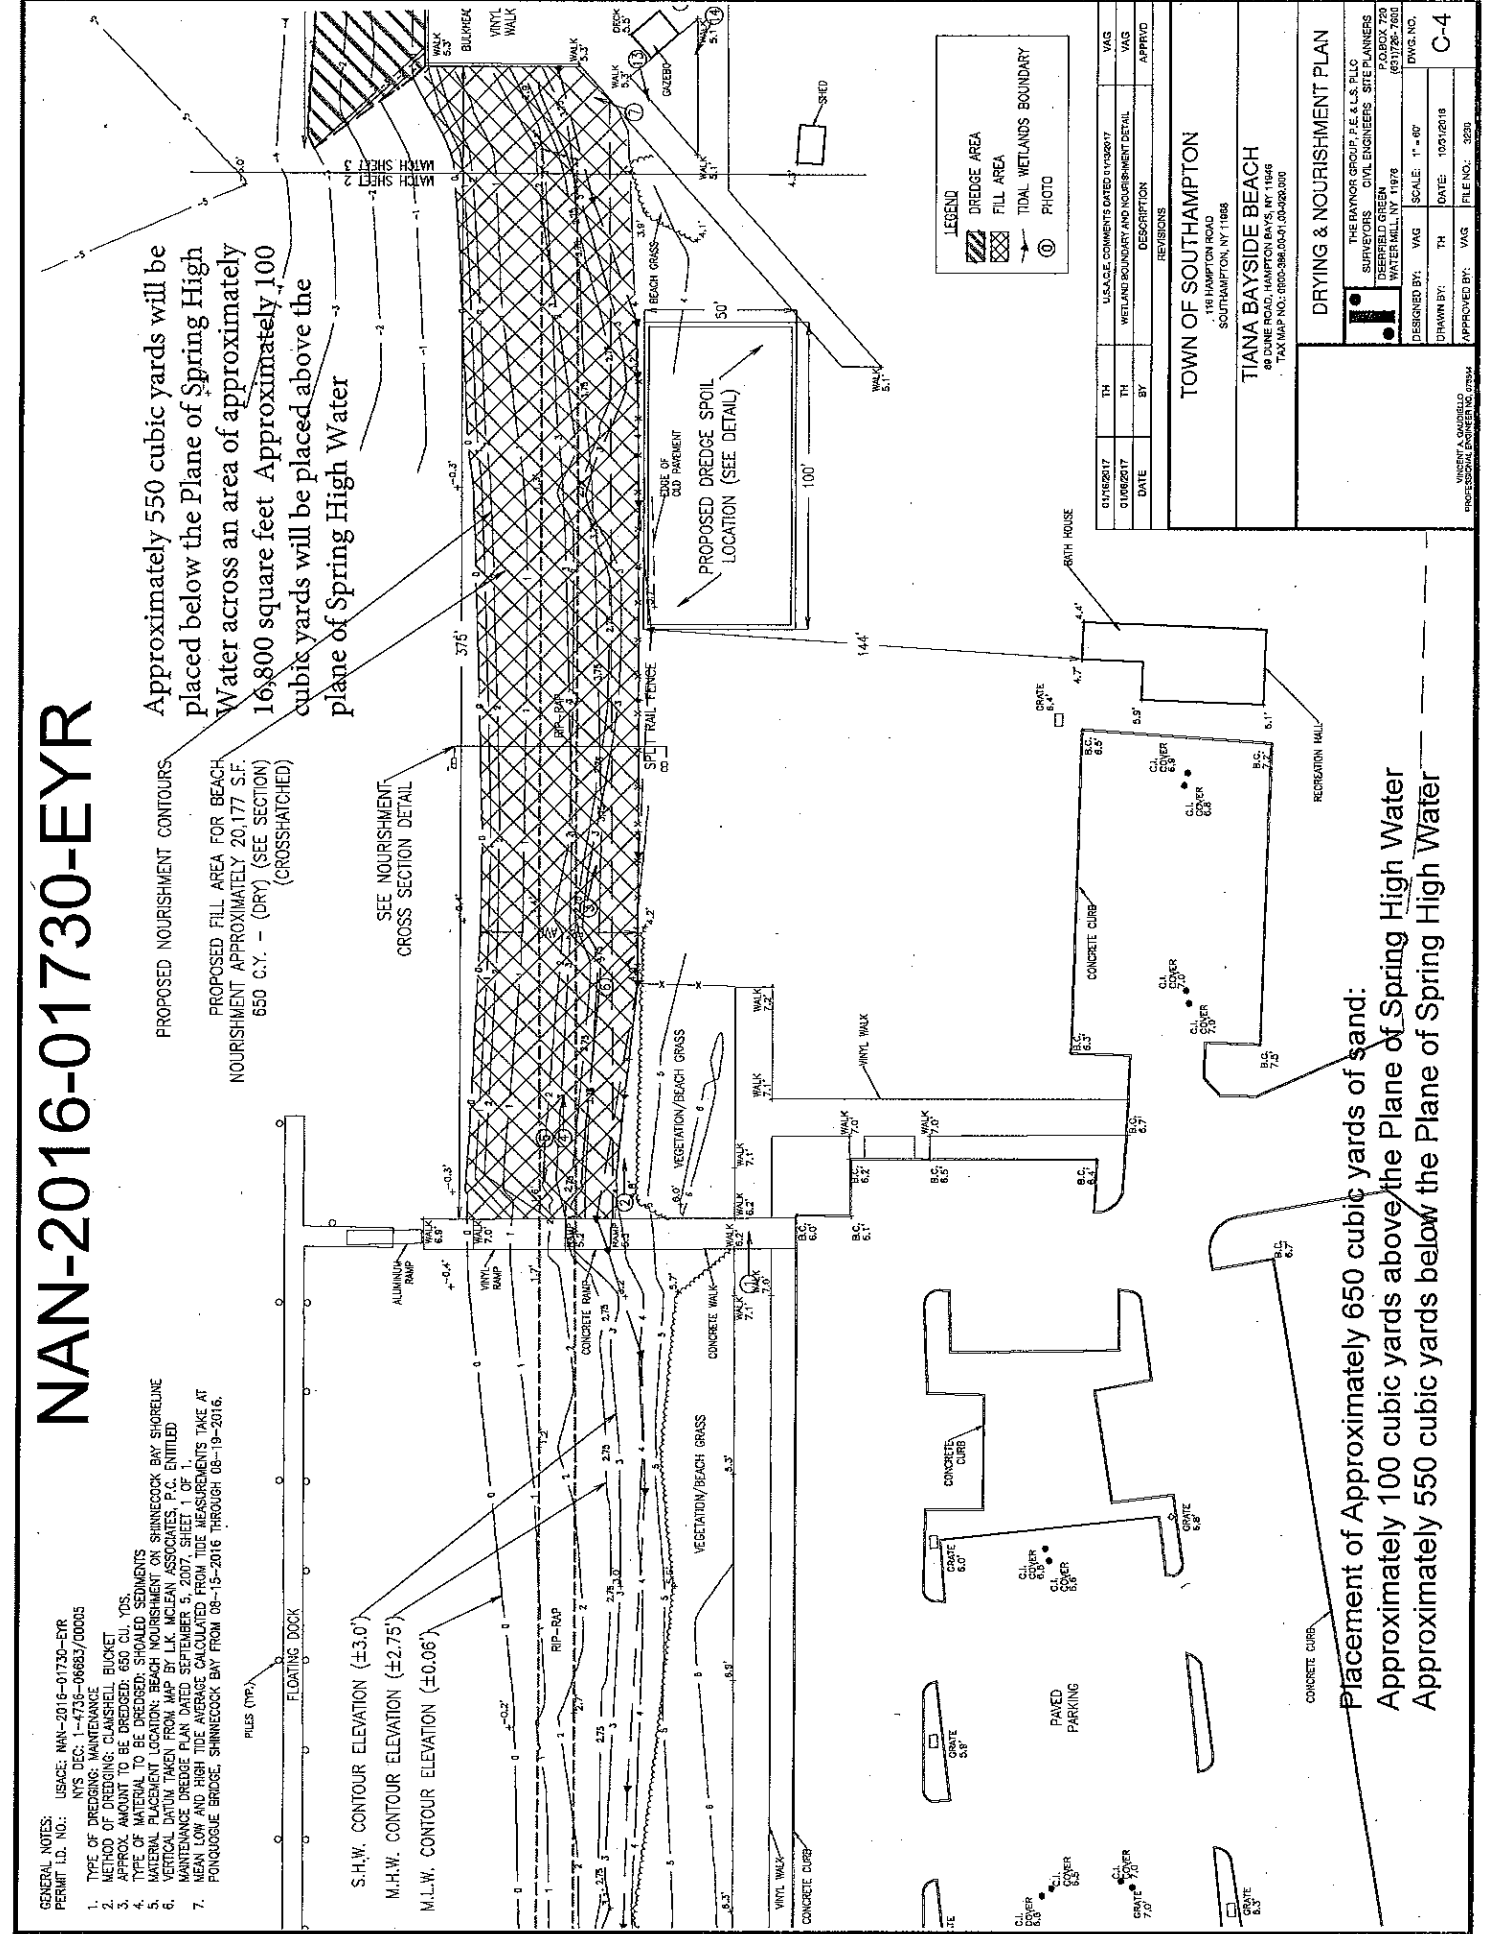


NAN-2016-01730-EYR

GENERAL NOTES:
 PERMIT I.D. NO.: USACE: NAN-2016-01730-EYR
 NYS DEC: 1-4736-06683/00005

1. TYPE OF DREDGING: MAINTENANCE
2. METHOD OF DREDGING: CLAWSHELL BUCKET
3. APPROX. AMOUNT TO BE DREDGED: 650 CU. YDS.
4. TYPE OF MATERIAL TO BE DREDGED: SHOALED SEDIMENTS
5. MATERIAL PLACEMENT LOCATION: BEACH NOURISHMENT ON SHINNECOCK BAY SHORELINE
6. VERTICAL DATUM TAKEN FROM MAP BY L.K. MCLEAN ASSOCIATES, P.C. ENTITLED MAINTENANCE DREDGE PLAN DATED SEPTEMBER 5, 2007, SHEET 1 OF 1.
7. MEAN LOW AND HIGH TIDE AVERAGE CALCULATED FROM TIDE MEASUREMENTS TAKE AT PONTOQUE BRIDGE, SHINNECOCK BAY FROM 08-15-2016 THROUGH 08-19-2016.

Placement of Approximately 650 cubic yards of sand:
 Approximately 100 cubic yards above the Plane of Spring High Water
 Approximately 550 cubic yards below the Plane of Spring High Water

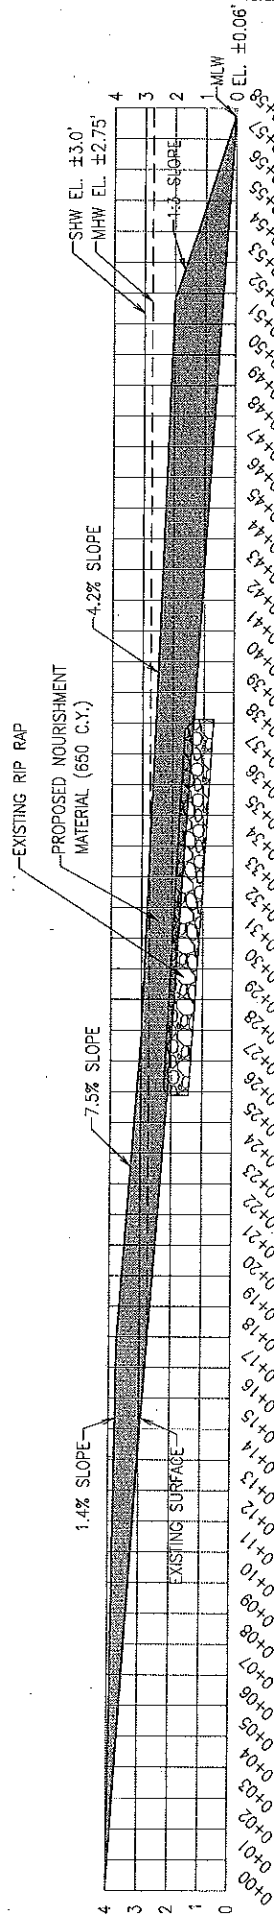


NOURISHMENT SECTION (B-B')

SCALE: 1" = 6'

NOTES:


- 1) DREDGING WILL BE PERFORMED WITH UPLAND EARTH MOVING EQUIPMENT. (EG. HYDRAULIC EXCAVATOR)
- 2) THE CONTRACTOR SHALL UTILIZE A CLOSED BUCKET FOR DREDGING.
- 3) THERE SHALL BE NO DOUBLE HANDLING OF DREDGE MATERIAL.
- 4) ALL DEBRIS AND UNUSED DRY SPOIL SHALL BE REMOVED AND DISPOSED OF AT AN APPROVED UPLAND DISPOSAL SITE.
- 5) A BULLDOZER AND PAYLOADER WILL BE UTILIZED TO SPREAD AND GRADE FILL

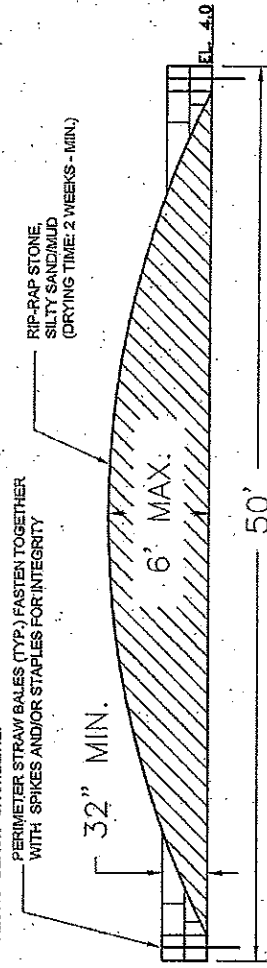

TYPICAL PROPOSED SPOIL RETENTION AREA CROSS SECTION

SECTION I - I

N.T.S.

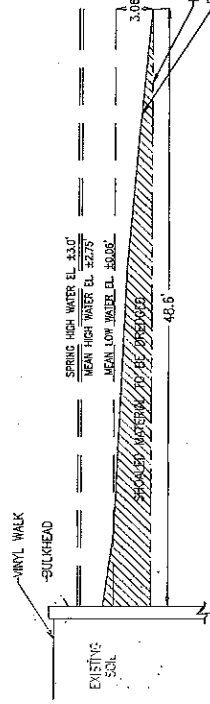

DREDGING SECTION (A-A')

SCALE: 1" = 15'

DATE	BY	DESCRIPTION	APPROVED
07/26/2017	TH	USACE COMMENTS DATED 07/26/17	VAG
07/26/2017	TH	WETLAND BOUNDARY AND NOURISHMENT DETAIL	VAG
			APPROV

REVISIONS	

TOWN OF SOUTHAMPTON	
118 HAMPTON ROAD	
SOUTHAMPTON, NY 11988	
TIANA BAYSIDE BEACH	
69 DUNE ROAD, HAMPTON BAYS, NY 11946	
PROJECT NO.: 0000-586-0001-00-00-000	

MAINTENANCE DREDGE DETAILS	
THE RAYNOR GROUP, P.E. & L.S. PLLC	
SURVEYORS CIVIL ENGINEERS SITE PLANNERS	
DEERFIELD GREEN	
WATERMILL, NY 11986	
DESIGNED BY:	VAG
SCALE:	AS NOTED
DWG. NO.:	C-5
DRAWN BY:	TH
DATE:	10/31/2016
APPROVED BY:	VAG
FILE NO.:	3226