

PUBLIC NOTICE

U.S. Army Corps of Engineers New York District, CENAN-OP-RU Upstate Regulatory Field Office 1 Buffington Street, Bldg. 10, 3rd Fl. North Watervliet. New York 12189-4000

In replying refer to:

Public Notice Number: NAN-2018-00568-UDA

Issue Date: March 10, 2022 Expiration Date: April 9, 2022

To Whom It May Concern:

The New York District, Corps of Engineers has received an application for a Department of the Army permit pursuant to Section 404 of the Clean Water Act (33 U.S. C. 1344).

APPLICANT: William J. Cade

195 Hilton Road

Slingerlands, New York 12159

ACTIVITY: Discharge of fill material into waters of the United States to facilitate the

construction of a residential subdivision and attendant features

WATERWAY: Wetlands (Hudson River Watershed)

LOCATION: Town of Bethlehem, Albany County, New York

A detailed description and plans of the applicant's activity are enclosed to assist in your review.

The decision whether to issue a permit will be based on an evaluation of the probable impact including cumulative impacts of the proposed activity on the public interest. That decision will reflect the national concern for both protection and utilization of important resources. The benefit which reasonably may be expected to accrue from the proposal must be balanced against its reasonably foreseeable detriments. All factors which may be relevant to the proposal will be considered including the cumulative effects thereof; among those are conservation, economics, aesthetics, general environmental concerns, wetlands, historic properties, fish and wildlife values, flood hazards, floodplain values, land use, navigation, shoreline erosion and accretion, recreation, water supply and conservation, water quality, energy needs, safety, food and fiber production, mineral needs, considerations of property ownership and, in general, the needs and welfare of the people.

The Corps of Engineers is soliciting comments from the public; Federal, state, and local agencies and officials; Indian Tribes; and other interested parties in order to consider and evaluate the impacts of this proposed activity. Any comments received will be considered by the Corps of Engineers to determine whether to issue, modify, condition or deny a permit for this proposal. To make this decision, comments are used to assess impacts on endangered species, historic properties, water quality, general environmental effects, and the other public interest factors listed above. Comments are used in preparation of an Environmental Assessment and/or an Environmental Impact Statement pursuant to the National Environmental Policy Act. Comments are also used to determine the need for a public hearing and to determine the overall public interest of the proposed activity.

ALL COMMENTS REGARDING THE PERMIT APPLICATION MUST BE PREPARED IN WRITING AND MAILED TO THE ATTENTION OF ANDREW DANGLER AT THE ABOVE ADDRESS, OR SENT VIA ELECTRONIC MAIL TO Andrew.c.dangler@usace.army.mil,

TO REACH THIS OFFICE BY THE EXPIRATION DATE OF THIS NOTICE, otherwise, it will be presumed that there are no objections to the activity. Due to COVID-19, and the limited in-office mail processing procedures, it is highly recommended that comments be sent by Electronic Mail only to prevent delays.

Comments submitted in response to this notice will be fully considered during the public interest review for this permit application. Comments provided will become part of the public record for this permit application. All written comments, including contact information, will be made a part of the administrative record, available to the public under the Freedom of Information Act. The Administrative Record, or portions thereof, may also be posted on a Corps of Engineers internet web site. Due to resource limitations, this office will normally not acknowledge the receipt of comments or respond to individual letters of comment.

Any person may request, in writing, before this public notice expires, that a public hearing be held to collect information necessary to consider this application. Requests for public hearings shall state, with particularity, the reasons why a public hearing should be held. It should be noted that information submitted by mail is considered just as carefully in the permit decision process and bears the same weight as that furnished at a public hearing.

Our preliminary determination is that the activity for which authorization is sought herein is not likely to affect any Federally endangered or threatened species or their critical habitat. However, pursuant to Section 7 of the Endangered Species Act (16 U.S.C. 1531), the District Engineer is consulting with the appropriate Federal agency to determine the presence of and potential impacts to listed species in the project area or their critical habitat.

Based upon a review of the GIS resources map on the N.Y.S. Office of Parks, Recreation and Historic Preservation (SHPO) website, the project site is located within areas identified by the SHPO as "Archeo Sensitive Areas". Further consultation with SHPO regarding these "Archeo Sensitive Areas" is being conducted and will be concluded prior to the final decision.

Reviews of activities pursuant to Section 404 of the Clean Water Act will include application of the guidelines promulgated by the Administrator, U.S. Environmental Protection Agency, under authority of Section 404 (b) of the Clean Water Act and the applicant will obtain a water quality certificate or waiver from the appropriate state agency in accordance with Section 401 of the Clean Water Act prior to a permit decision.

In addition to any required water quality certificate, the applicant has obtained or requested the following governmental authorization for the activity under consideration:

- New York State Department of Environmental Conservation Stormwater Permit
- Local building permit from the Town of Bethlehem

In order for us to better serve you, please complete our Customer Service Survey located at:

http://www.nan.usace.army.mil/Missions/Regulatory/CustomerSurvey.aspx

It is requested that you communicate the foregoing information concerning the activity to any persons known by you to be interested and who did not receive a copy of this notice. If you have any questions concerning this application, you may contact Andrew Dangler of this office at (518) 266-6356 or Andrew.C.Dangler@usace.army.mil.

For more information on New York District Corps of Engineers programs, visit our website at http://www.nan.usace.army.mil

FOR AND ON BEHALF OF

Stephan A. Ryba

Chief, Regulatory Branch

Enclosures


WORK DESCRIPTION

The applicant, William Cade, has requested Department of the Army authorization for the discharge of fill material into approximately 0.60 acres of waters of the United States, including wetlands to facilitate the construction of a PDD residential subdivision and attendant features to be known as "Phillipin Kill Manor". The project is located at 75 Fisher Boulevard, in the Town of Bethlehem, Albany County, New York.

The work would involve the construction of a 50-lot residential development and attendant features consisting of 36 town homes, 6 single-family home lots, and 8 estate lots, and the associated roads, utilities, and stormwater facilities. The proposed project would result in the permanent impacts to approximately 0.076 acres of emergent wetland, 0.42 acres of scrub-shrub wetland, 0.10 acres of forested wetland, and 150 linear feet of ephemeral stream channel. In addition to the proposed 0.60 acres of wetland impact, approximately 1.41 acres of unauthorized wetland impacts have occurred at the project site and are being reviewed cumulatively with the currently proposed impacts.

The applicant has stated that they have avoided and minimized proposed impacts to the maximum extent practicable by limiting construction to the smallest area practicable, including designing the layout of the houses and attendant features to limit impacts to waters of the United States. As mitigation for the proposed impacts to waters of the United States, the applicant has proposed to establish 2.57 acres of palustrine forested/scrubshrub wetlands, secure a restrictive covenant over the 8.5 acres of land comprised of the wetland mitigation sites, existing wetland, and upland buffer. In addition, the applicant proposes to secure a conservation easement over 28.68 acres of riparian corridor which contains approximately 3,800 linear feet of stream channel.

The stated purpose of this project is to construct a PDD residential development and attendant features within the Town of Bethlehem.

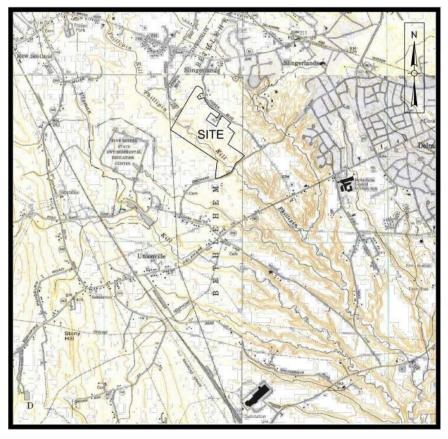

PHILL MAJ

VICINITY MAP SCALE: 1"=1000'

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| DEC-1 | DEC CONVEYANCE |



LIPIN KILL MANOR JOR SUBDIVISION

ADOPTED TOWN BOARD RESOLUTION NO. 23, DATED MAY 26, 2010

TOWN OF BETHLEHEM, ALBANY COUNTY NEW YORK

MARCH 30, 2018

LAST REVISED: September 13, 2021


Weston & Sampson

PE, LS, LA, PC

1 Winners Circle, Suite 130, Albany, New York 12205

Tel:(518) 463-4400 (800) SAMPSON www.westonandsampson.com



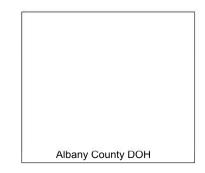

SHEET G-1

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SAFETY NOTES


- CONTRACTOR SHALL BE RESPONSIBLE FOR INITIATING, MAINTAINING AND SUPERVISING ALL WORK SAFETY PRECAUTIONS AND PROGRAMS IN CONNECTION WITH THE WORK. CONTRACTOR SHALL TAKE ALL NECESSARY PRECAUTIONS TO PREVENT DAMAGE, INJURY OR LOSS TO:
- ALL EMPLOYEES ON THE WORK SITE AND OTHER PERSONS WHO MAY BE AFFECTED THEREBY.
- ALL THE WORK AND ALL THE MATERIALS OR EQUIPMENT TO BE INCORPORATED THEREIN, WHETHER IN STORAGE ON OR OFF THE SITE.
- OTHER PROPERTY AT THE SITE OR ADJACENT THERETO, INCLUDING BUT NOT LIMITED TO TREES, SHRUBS, LAWNS, WALKS, PAVEMENTS, ROADWAYS, STRUCTURES AND UTILITIES NOT DESIGNATED FOR REMOVAL, RELOCATION, OR REPLACEMENT IN THE COURSE OF CONSTRUCTION.
- 2. CONTRACTOR SHALL COMPLY WITH ALL APPLICABLE LAWS, ORDINANCES, RULES, REGULATIONS AND ORDERS (INCLUDING O.S.H.A. REGULATIONS) OF ANY PUBLIC BODY HAVING JURISDICTION OVER THE SAFETY OF PERSONS OR PROPERTY ON THIS
- THE CONTRACTOR SHALL NOTIFY OWNERS OF ADJACENT PROPERTY AND UTILITIES WHEN EXECUTION OF WORK WILL AFFECT THEM.
- THE CONTRACTOR'S DUTIES AND RESPONSIBILITIES FOR THE SAFETY AND PROTECTION OF THE WORK SHALL CONTINUE UNTIL SUCH TIME AS ALL THE WORK IS COMPLETED.
- AT THE CLOSE OF EACH WORK DAY THE CONTRACTOR SHALL BACKFILL, OR ADEQUATELY BARRICADE, ALL OPEN TRENCHES OR OTHER PERCEIVED HAZARDS TO PROTECT THE PUBLIC.

DEMOLITION NOTES

- UNLESS OTHERWISE NOTED, THE CONTRACTOR IS RESPONSIBLE FOR THE REMOVAL AND PROPER DISPOSAL OF ALL FELLED TREES, CUT BRUSH, DEMOLISHED CONCRETE, ASPHALT, PIPING, EQUIPMENT AND BUILDING MATERIALS.
- THE CONTRACTOR SHALL CALL $Dig\ Safe @$ at $811\ \mbox{or}\ 888-DIG-SAFE$ at least 48 hours, saturdays, sundays, and holidays excluded, prior to excavating at any location.

SLOPE STABILITY NOTES

- EXCEPT AS NOTED IN DENTE ENGINEERING'S MARCH 20TH, 2020 SLOPE STABILITY REPORT, FILL SHOULD NOT BE PLACED DOWNSLOPE FROM THE SLOPE SETBACK
- EXCEPT AS NOTED IN DENTE ENGINEERING'S MARCH 20TH, 2020 SLOPE STABILITY REPORT, VEGETATION SHOULD NOT BE REMOVED, AND THE SLOPES SHOULD NOT OTHERWISE BE DISTURBED DOWNSLOPE FROM THE SLOPE SETBACK LINES UNLESS REVIEWED AND APPROVED BY THE GEOTECHNICAL ENGINEER.
- FILL MAY BE PLACED UPSLOPE FROM THE SLOPE SETBACK LINES AT A A MAXIMUM INCLINATION OF 1V: 4H.

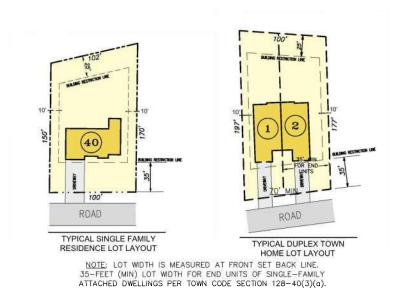

| PROJEC | T INFORMATION |
|--|---|
| ADDRESS | 75 FISHER BOULEVARD SLINGERLANDS, NY 12159 |
| TAX MAP NUMBERS (7 PARCELS) | PARCEL 1 = 84.0-3-1.1 PARCEL 2 = 84.0-3-1.3 PARCEL 3 = 84.0-16-1.1 PARCEL 4 = 84.0-3-16.2 PARCEL 5 = 84.0-3-15 PARCEL 6 = 84.0-3-4 PARCEL 7 = 84.0-3-11.2 |
| SITE COORDINATES (UTM — UNIVERSAL TRANSVERSE MERCATOR) | N 4,807,726 E 605,642 |
| TOTAL PROJECT AREA | 129.85± ACRES |
| ZONE DISTRICT AREA | PLANNED DEVELOPMENT DISTRIC |
| EXISTING USE | EXISTING SINGLE—FAMILY STRUC AND REMAINING LAND UNDEVEL |
| PROPOSED USE | (6) SINGLE FAMILY LOT (8) ESTATE LOTS (36) TOWNHOME UNITS |
| PARCEL FRONTAGE | 1752± LF ALONG FISHER BOULE 1778± LF ALONG ORCHARD STE |
| WATER SUPPLY | TOWN OF BETHLEHEM |
| SANITARY SERVICE | BETHLEHEM SEWER DISTRICT |
| FIRE PROTECTION | BETHLEHEM FIRE DEPARTMENT |
| SCHOOL DISTRICT | BETHLEHEM SCHOOL DISTRICT |

SITE STATISTICS * INCLUDES PAVEMENTS AND STRUCTURES

| ENTITY | CARRIN | GTON COURT | PRESTV | VICK DRIVE | FISHER | BOULEVARD | ORCHARD STREET | TOTAL |
|-----------------|--------------|-----------------------------|----------|-----------------------------|--------|------------------------------|------------------|--------------------|
| # OF STRUCTURES | 36 TOWNHOMES | | 6 SINGLI | E FAMILY LOTS | 1 ES | TATE LOT | 7 ESTATE LOTS | 50 UNITS |
| IMPERVIOUS* | 3.6 | 55± ACRES | 0.92 | 2± ACRES | 0.45 | ± ACRES | 1.15± ACRES | 6.17± ACRES |
| GREEN | 13. | 49± ACRES | 6.96 | 6± ACRES | 4.88 | ± ACRES | 13.98± ACRES | 39.31± ACRES |
| TOTAL | 17. | 14± ACRES | 7.88 | 3± ACRES | 5.22 | ± ACRES | 15.13± ACRES | 42.35± ACRES |
| WETLAND IMPACT | 0.3 | 37± ACRES | 0.10 | D± ACRES | 0.13 | ± ACRES | 0.0± ACRES | 0.60± ACRES |
| | AREA A | 670± S.F. (0.015± ACRES) | AREA D | 850± S.F. (0.02± ACRES) | AREA F | 1100± S.F. (0.025± ACRES) | EPHEMERAL STREAM | M IMPACTS (L.F.) |
| | AREA B | 15270± S.F (0.35± ACRES) | AREA E | 3272± S.F. (0.08± ACRES) | AREA G | 2660± S.F. (0.061± ACRES) | A - PRESTWICK DI | RIVE - 150+/- L.F. |
| | AREA C | 275± S.F. (0.006± ACRES) | | | AREA H | 1770± S.F. (0.04± ACRES) | TOTALIMPA | CTS - 150+/- L.F. |

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-FAMILY STRUCTURES

FISHER BOULEVARD

ORCHARD STREET

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MILY LOT

UNITS

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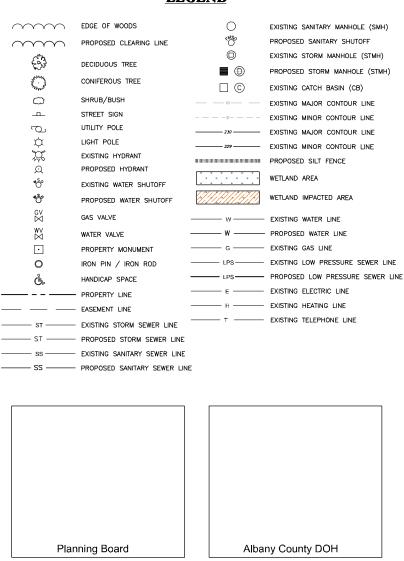
OOL DISTRICT

DTS

CONSTRUCTION NOTES

- LOCATIONS OF EXISTING PIPES, CONDUITS, UTILITIES, FOUNDATIONS AND OTHER UNDERGROUND OBJECTS ARE NOT WARRANTED TO BE CORRECT AND THE CONTRACTOR SHALL HAVE NO CLAIM ON THAT ACCOUNT SHOULD THEY BE OTHER THAN SHOWN.
- 2. ALL AREAS DISTURBED BY THE CONTRACTOR BEYOND GRADING LIMITS SHALL BE RESTORED AT NO ADDITIONAL COST TO THE OWNER.
- UNLESS OTHERWISE INDICATED, NEW CONCRETE USED SHALL HAVE A MINIMUM COMPRESSIVE STRENGTH OF 4000 PSI AT 28 DAYS.
- THE CONTRACTOR SHALL NOT STORE ANY APPARATUS, MATERIALS, SUPPLIES, OR EQUIPMENT ON DRAINAGE STRUCTURES OR WITHIN 100 FEET OF WETLANDS OR WATER BODIES.
- CONTRACTOR TO FIELD VERIFY DIMENSIONS AND ELEVATIONS AS NECESSARY FOR COMPLETION OF THE WORK DESCRIBED IN THE PLANS.
- CONTRACTOR SHALL INSTALL ALL MATERIALS IN ACCORDANCE WITH MANUFACTURER'S AND APPLICABLE CODE REQUIREMENTS.
- CONTRACTOR SHALL BE RESPONSIBLE FOR ALL MEANS AND METHODS REQUIRED TO CONSTRUCT WHAT IS SHOWN ON THE PLANS.
- 8. THE CONTRACTOR SHALL TAKE EXTRA PRECAUTIONS TO ENSURE THAT NO POLLUTANTS ENTER WATER BODIES OR THE GROUNDWATER TABLE FROM THE CONSTRUCTION AREA. THE CONTRACTOR SHALL NOT STORE FUELS OR OTHER HAZARDOUS MATERIALS OR POTENTIAL CONTAMINANTS ON THE CONSTRUCTION SITE. IN THE EVENT OF A SPILL, THE CONTRACTOR SHALL IMMEDIATELY NOTIFY THE NYSDEC.
- 9. CONTRACTOR SHALL TAKE ALL NECESSARY PRECAUTIONS TO PREVENT CONTAMINATION OF ANY WATER BODY, STREAMS OR DRAINAGE CHANNELS BY SILT, SEDIMENT, FUELS, SOLVENTS, LUBRICANTS, CONCRETE, OR ANY OTHER POLLUTANT ASSOCIATED WITH THE CONSTRUCTION ACTIVITIES.

LEGEND



AN INSTRUMENT OF SERVICE AND IS THE PHOPERTY OF WESTON & SAMESON, P. L. S. L. AP CHIES DEPARMISON MAY NOT BE REPRODUCED IN WHOLE OR IN PART BY ANY MEANS MHATSOEVER WITHOUT THE EXPRESS WHITEL CONSENT OF MESTON & SAMPSON PE LS. L.A. PC UNAUTHORIZED ALTERATION ON ADDITION TO THIS DOCUMENT IS A VIOLATION OF SECTION 700, SUBDIVISION 20 CT HEI NEW YORK STATE EDUCATION LAW. Project:


PHILLIPIN KILL MANOR MAJOR SUBDIVISION PHASE - 1

TOWN OF BETHLEHEM ALBANY COUNTY NEW YORK

APPLICANT: WILLIAM J. CADE

Weston & Sampson

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| Drawn By: | CGC |
| Reviewed By: | DTF |
| Approved By: | JFB |
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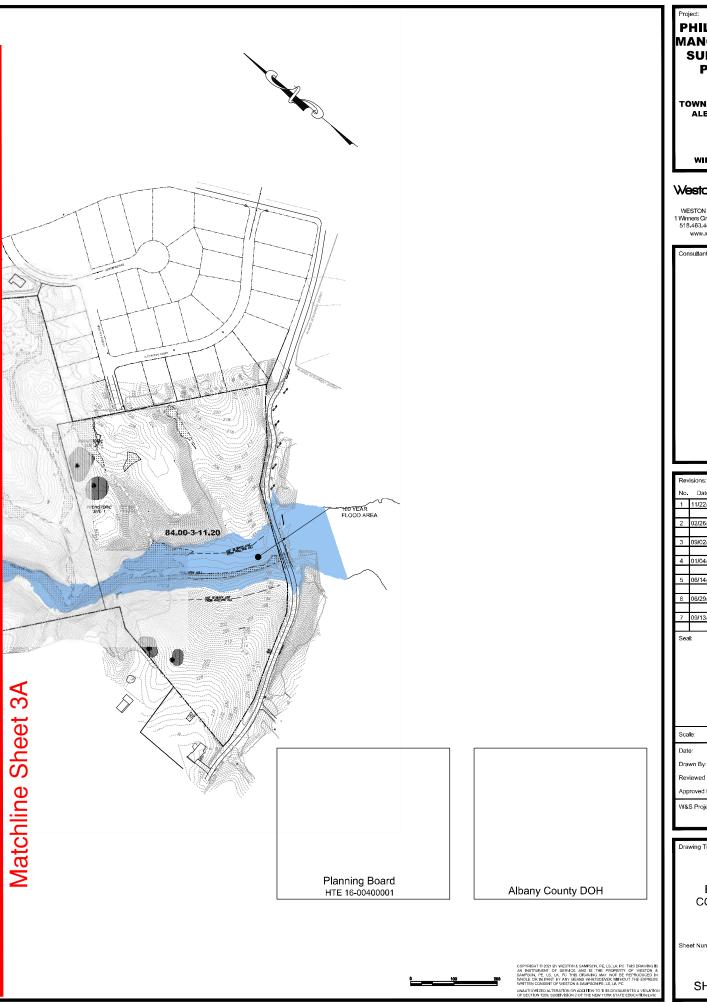
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GENERAL NOTES AND LEGEND
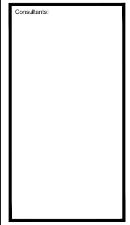
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G-2

SHT. 2 OF 30



PHILLIPIN KILL MANOR MAJOR **SUBDIVISION** PHASE - 1

TOWN OF BETHLEHEM ALBANY COUNTY NEW YORK

APPLICANT: WILLIAM J. CADE

Weston & Sampson

WESTON & SAMPSON, PE, LS, LA, PC 1 Winners Circle, Suite 130, Albarry, NY 12205 518.463.4400 800.SAMPSON www.westonandsampson.com

| Consultants: |
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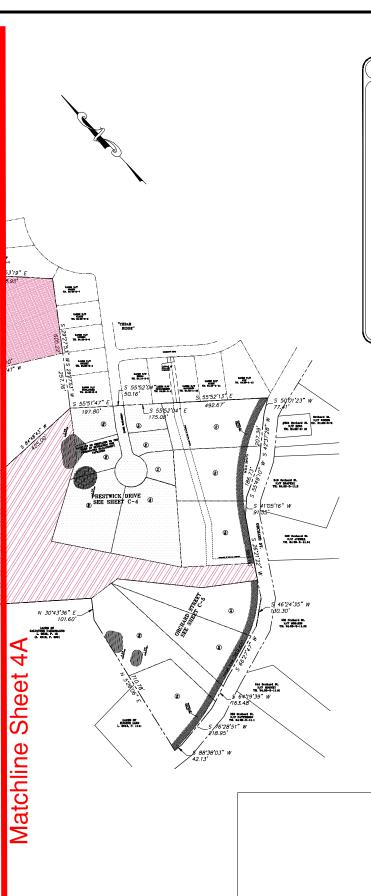
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EXISTING CONDITIONS

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C-1

SHT. 3 OF 30



SURVEY NOTES

- SURVEY SHOWN WAS PREPARED FROM A 2016 FIELD SURVEY.
- 2. THE OUTER BOUNDS OF THE P.D.D.'S LANDS ARE SHOWN ON THESE PLANS BASED ON DEED RECORDS WITHOUT THE BENEFIT OF AN UP—TO—DATE ABSTRACT OF TITLE OR TITLE REPORT AND IS SUBJECT TO ANY STATEMENTS OF FACT THAT SUCH DOCUMENTS MAY REVEAL. COMPLETED BOUNDARY SURVEY INFORMATION WILL BE UPDATED AT THE TIME THE FINAL SUBJOINSION PLAT PACKAGE IS PREPARED. INTERIOR LOT LINES BEARING AND DISTANCES SHOWN ARE PRELIMINARY, AS ADJUSTMENTS MAY BE NECESSARY DURING THE MUNICIPAL REVIEW PROCESS. FINAL SURVEY COMPUTATIONS AND LABELING OF INTERIOR LOT LINES WILL BE COMPLETED AT THE TIME THE FINAL SUBDIVISION PLAT PACKAGE IS PREPARED.
- 4. UNAUTHORIZED ALTERATION OR ADDITION TO A SURVEY MAP BEARING A LICENSED LAND SURVEYOR'S SEAL IS A VIOLATION OF SECTION 7209, SUBDIVISION 2 OF THE NEW YORK STATE EDUCATION LAW.
- 6. CERTIFICATIONS INDICATED OR IMPLIED HEREON SIGNIFY THAT THIS SURVEY WAS PREPARED IN ACCORDANCE WITH THE EXISTING CODE OF PRACTICE FOR LAND SURVEYS ADOPTED BY THE NEW YORK STATE ASSOCIATION OF PROFESSIONAL LAND SURVEYORS. SAID CERTIFICATIONS SHALL RUN ONLY TO THE PERSON OR PERSONS FOR WHOM THIS SURVEY WAS PREPARED, AND ON HIS OR THEIR BEHALF TO THE TITLE COMPANY, GOVERNMENTAL AGENCY AND LENDING INSTITUTION LISTED HEREON, AND TO THE ASSIGNEES OF THE LENDING INSTITUTION. CERTIFICATIONS ARE NOT TRANSFERRABLE TO ADDITIONAL INSTITUTIONS OR SUBSEQUENT OWNERS.

3. SURVEY SHOWN IS SUBJECT TO ANY SUBSURFACE CONDITIONS THAT MAY EXIST, IF ANY.

5. ONLY COPIES FROM THE ORIGINAL OF THIS SURVEY MARKED WITH AN ORIGINAL OF THE LAND SURVEYOR'S SEAL, AND SIGNATURE IN RED, SHALL BE CONSIDERED TO BE TRUE AND VALID COPIES.

Albany County DOH

Project

PHILLIPIN KILL MANOR MAJOR **SUBDIVISION** PHASE - 1

TOWN OF BETHLEHEM ALBANY COUNTY **NEW YORK**

> APPLICANT: WILLIAM J. CADE

Weston&Sampsoñ

WESTON & SAMPSON, PE, LS, LA, PC 1 Winners Circle, Suite 130, Albany, NY 12205 518,463,4400 800,SAMPSON

www.westonandsampson.com

Consultants:

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Scale 1" = 200" MARCH 30, 2018 ZAL Drawn By: Reviewed By:

Approved By:

W&S Project No: N2150091

Drawing Title:

OVERALL PRELIMINARY PLAT

Sheet Number:

C-2

SHT. 4 OF 30

Planning Board

HTE 16-00400001

_S 34°31′10″ E 150.00′

_N 79°23'51" E 91.58'

FISHER

LANDS N/F HILDRETH TM. 84.00-3-1.4


> LOT 1 249,037.0 SQ FT 5.717 ACRES

LANDS N/F MOLINO TM. 84.16-3-30

> S 53'05'05" E 18.13

LANDS N/F ROSENBLATT TM. 84.16-3-31

^{1.} LOT FRONTAGE DIMENSION IS MEASURED AT BUILDING SETBACK LINE AND HAS BEEN DISPLAYED FOR EACH LOT.

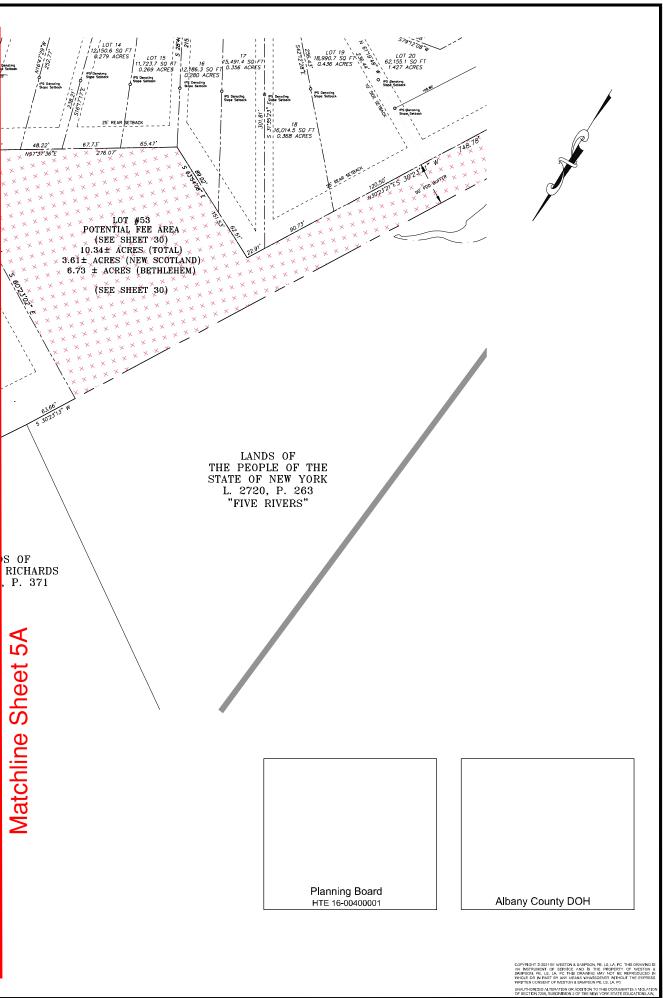

Project: **PHILLIPIN KILL**

MANOR MAJOR **SUBDIVISION** PHASE - 1

TOWN OF BETHLEHEM ALBANY COUNTY NEW YORK

APPLICANT: WILLIAM J. CADE

Weston & Sampsoñ

WESTON & SAMPSON, PE, LS, LA, PC 1 Winners Circle, Suite 130, Albany, NY 12205 518.463.4400 800 SAMPSON www.westonandsampson.com

| Consultants | : | | |
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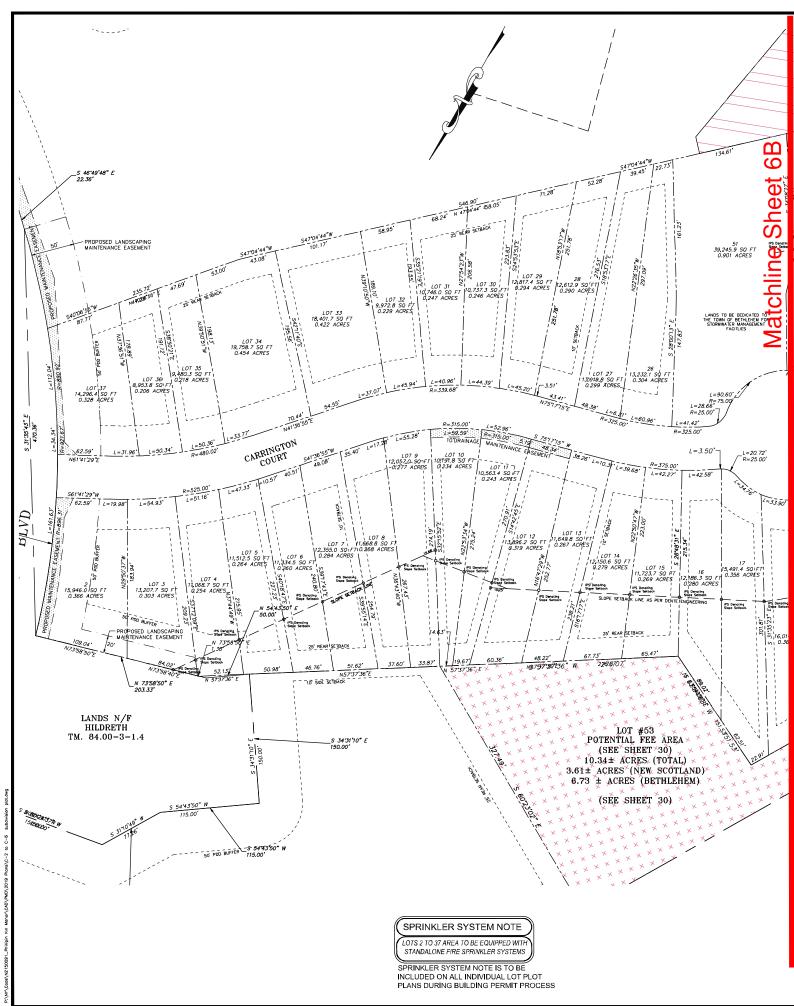
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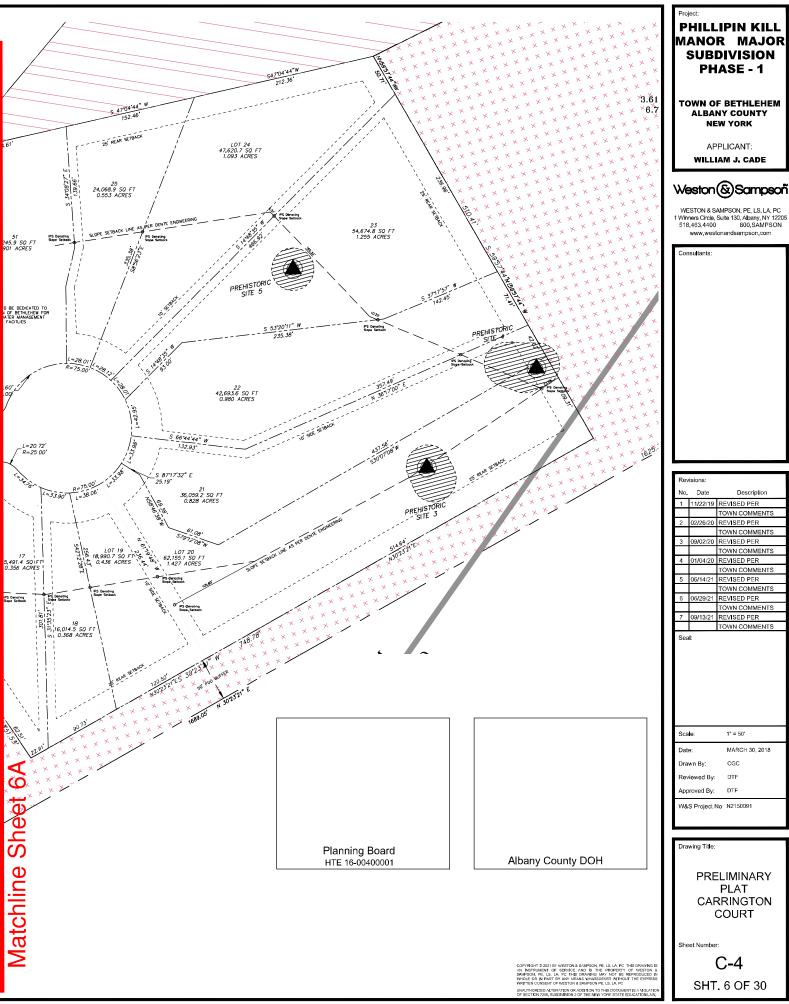
W&S Project No: N2150091


PRELIMINARY PLAT - FISHER **BOULEVARD**


C-3

SHT. 5 OF 30





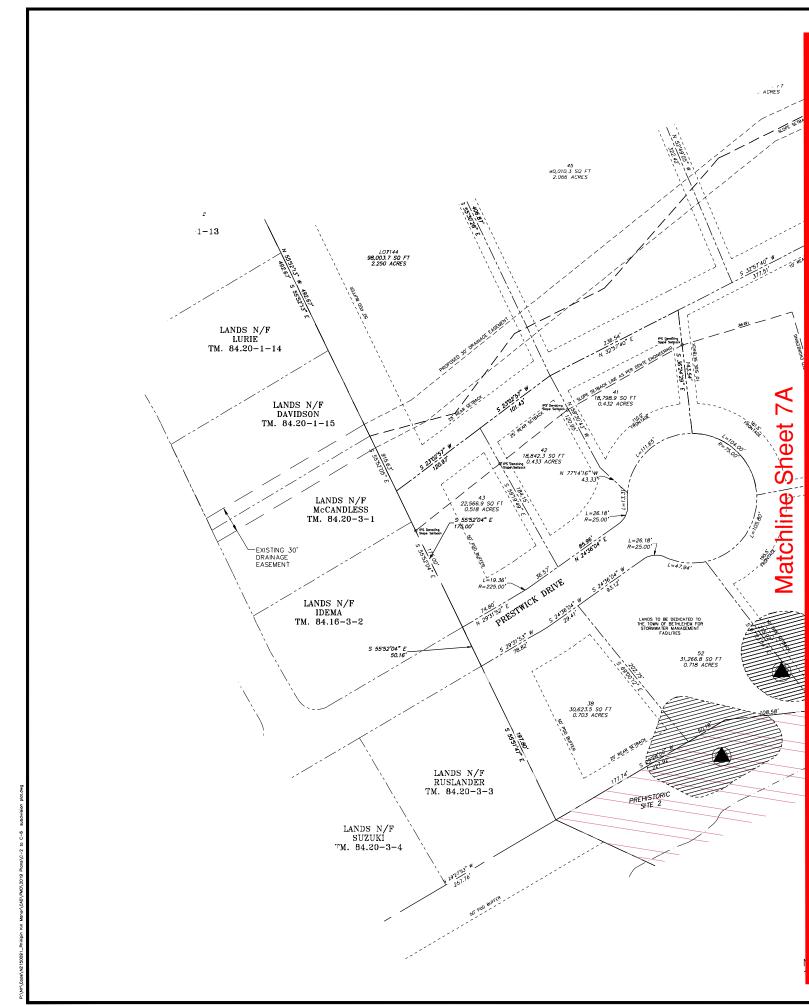

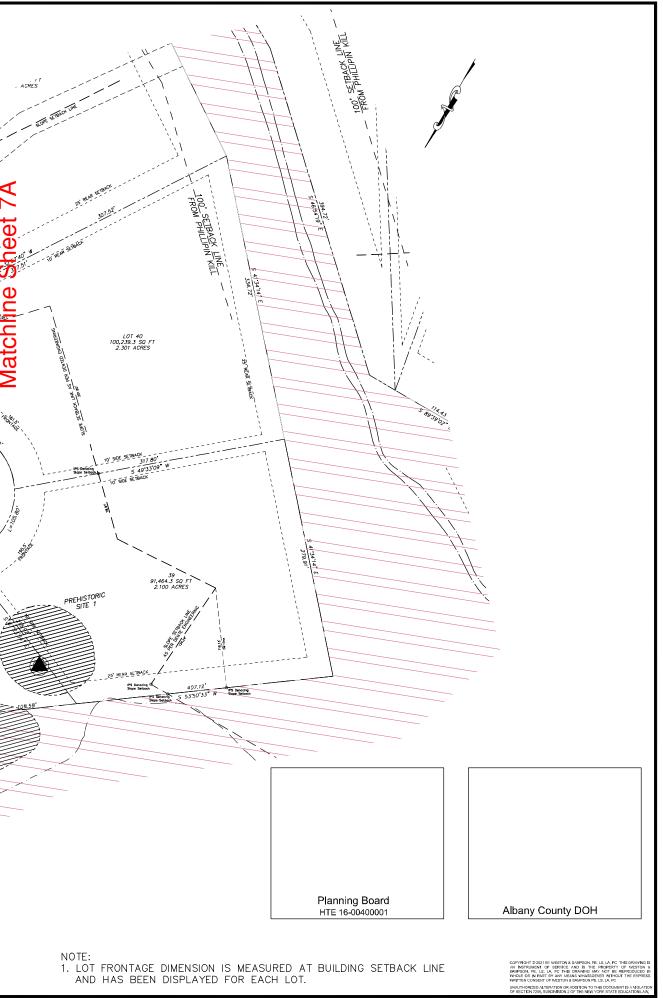

PHILLIPIN KILL MANOR MAJOR SUBDIVISION

> TOWN OF BETHLEHEM ALBANY COUNTY NEW YORK

PHASE - 1

APPLICANT: WILLIAM J. CADE

Weston & Sampson

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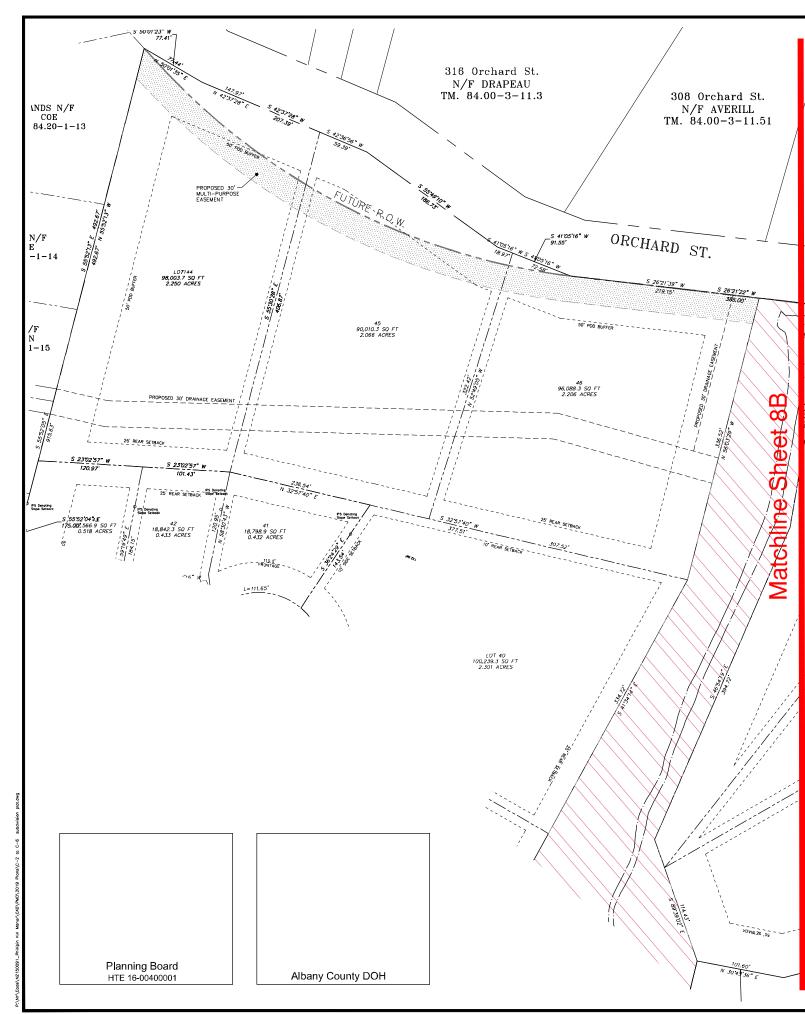
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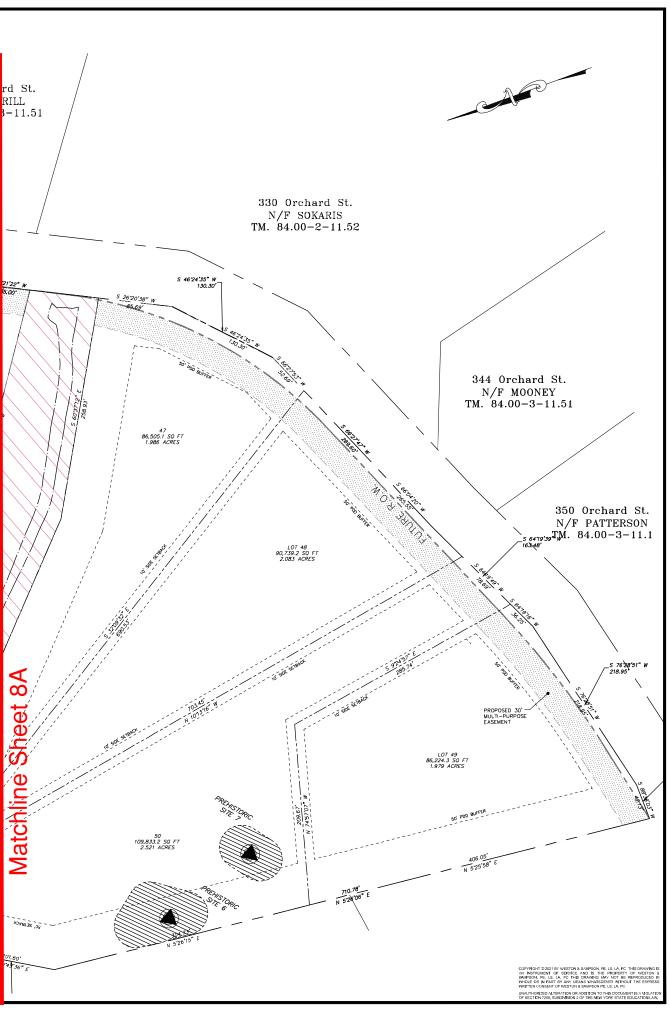
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PRELIMINARY PLAT PRESTWICK DRIVE

Sheet Number

C-5 SHT. 7 OF 30





PHILLIPIN KILL MANOR MAJOR SUBDIVISION PHASE - 1

> TOWN OF BETHLEHEM ALBANY COUNTY NEW YORK

> > APPLICANT: WILLIAM J. CADE

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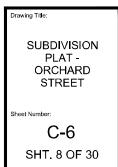
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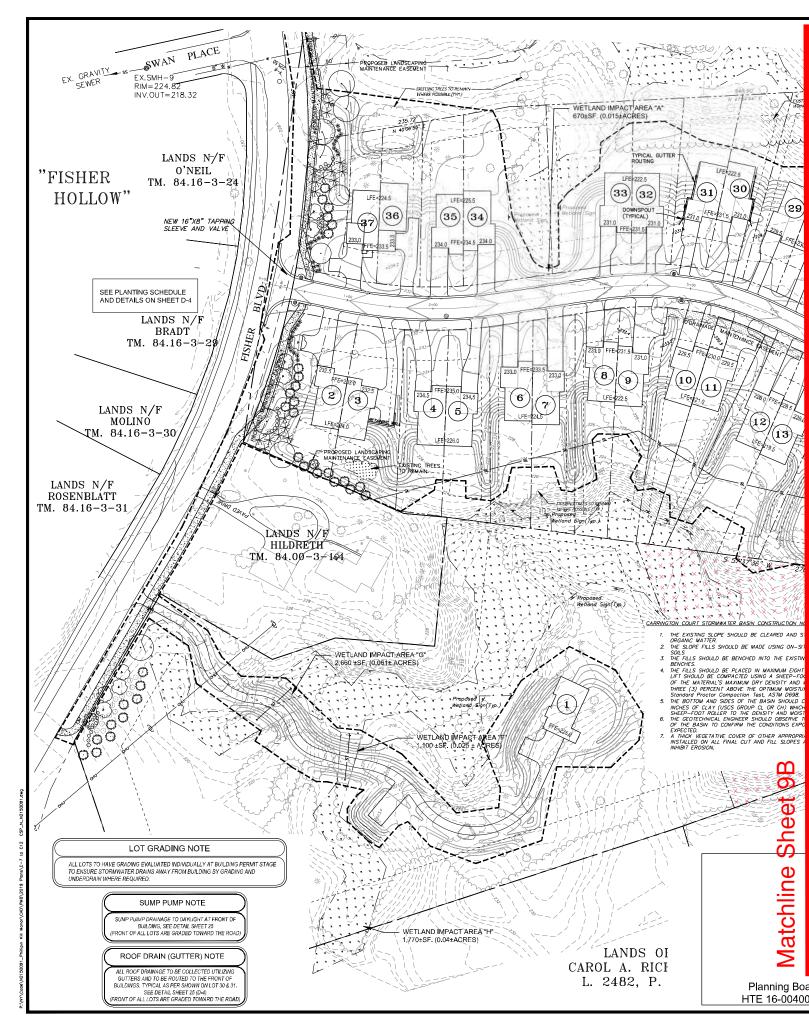
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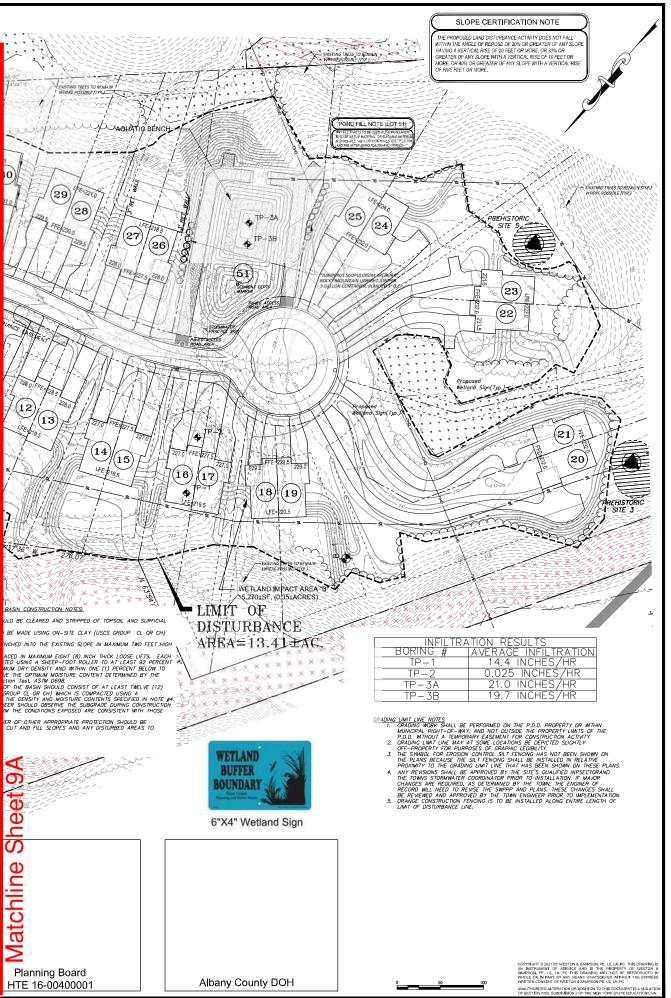
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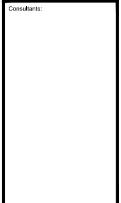
PHILLIPIN KILL MANOR MAJOR SUBDIVISION PHASE - 1

> TOWN OF BETHLEHEM ALBANY COUNTY NEW YORK

> > APPLICANT: WILLIAM J. CADE

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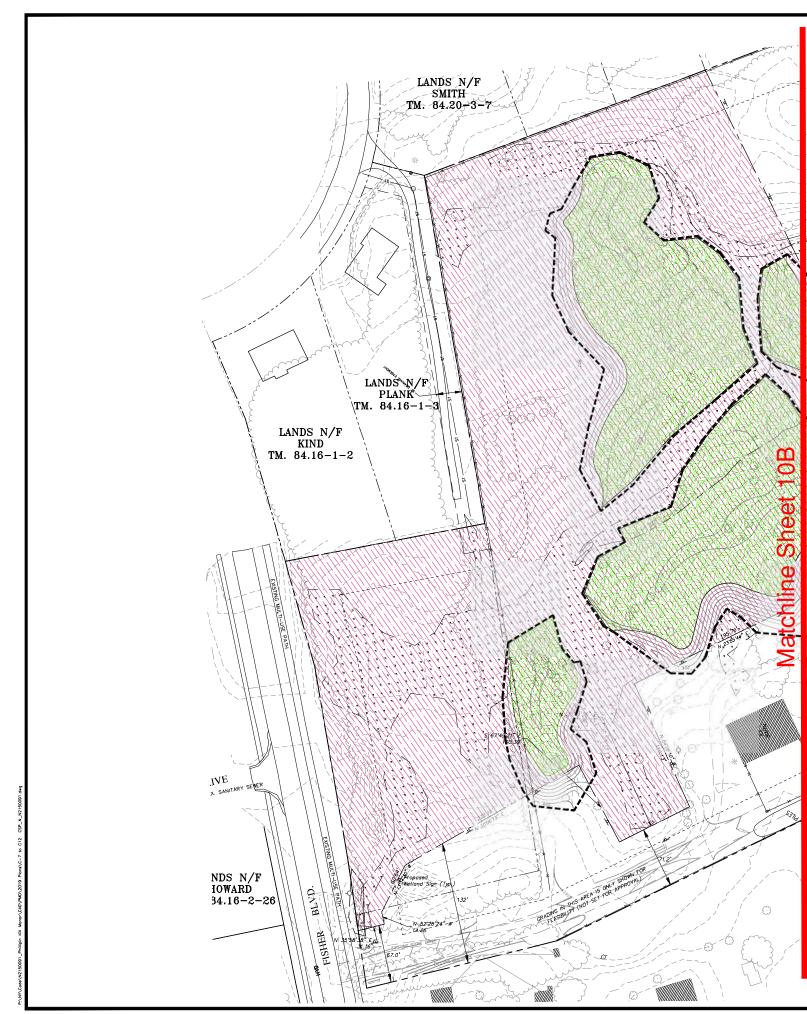
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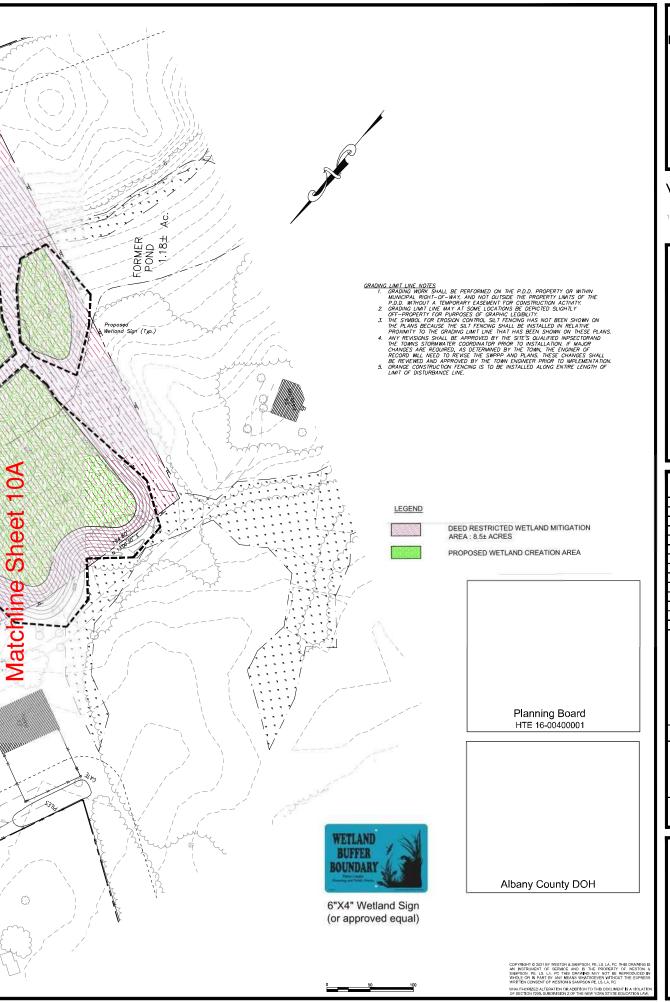
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GRADING PLAN -CARRINGTON COURT

Sheet Number:

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PHILLIPIN KILL

MANOR MAJOR **SUBDIVISION** PHASE - 1

TOWN OF BETHLEHEM **ALBANY COUNTY NEW YORK**

> APPLICANT: WILLIAM J. CADE

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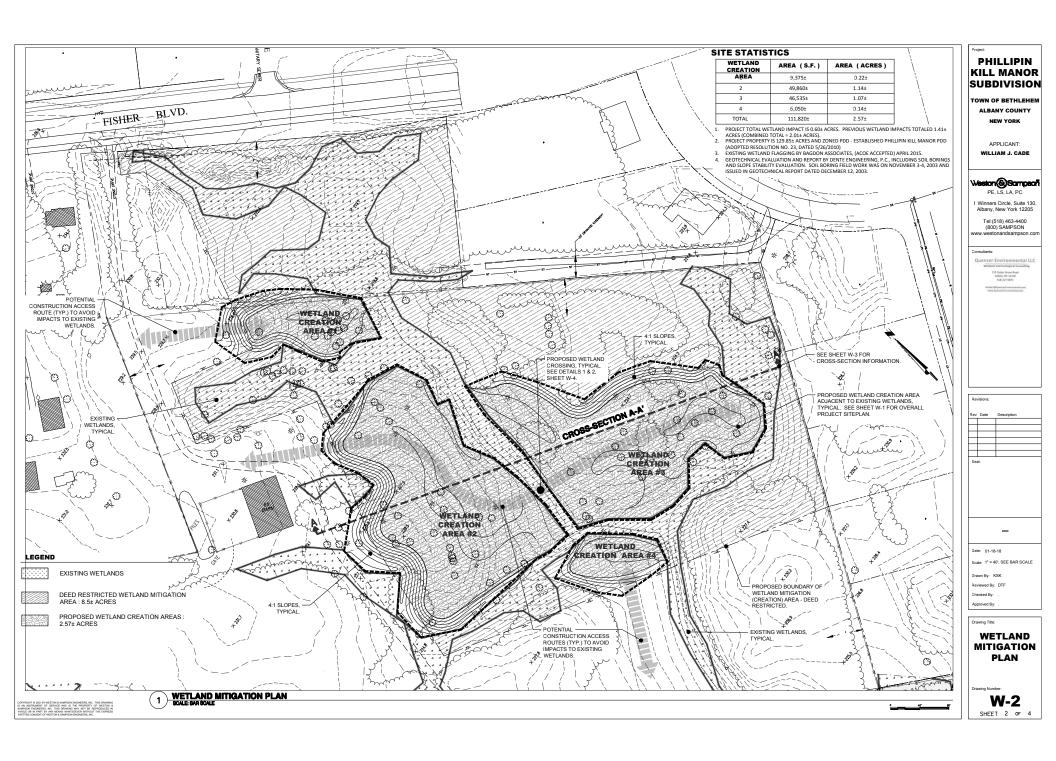
GRADING PLAN -WETLAND MITIGATION

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Sheet Number:

C-8

SHT. 10 OF 30



PLANTING SCHEDULE - Scrub-Shrub /Forested Wetland Plantings

SCIENTIFIC NAME COMMON NAME

SILKY DOGWOOD ELDERBERRY WINTERBERRY HOLLY SWAMP WHITE OAK CORNUS AMOMUM SAMBUCUS CANADENSIS ILEX VERTICILLATA QUERCUS BICOLOR SALIX DISCOLOR AND S. SERICEA SEIBAEA LA LADECULA SPIRAEA LATIFOLIA VACCINIUM CORYMBOSUM

NOTES:

PLANT SIZE IS POTTED (18"-36") WITH ESTABLISHED ROOT SYSTEMS.
NUMBERS OF SPECIMENS ARE BASED ON 12" ON-CENTER (00) - ~600± SHRUBS/SAPLINGS TOTAL.
ACTUAL PLANTION MIL BE DONE WITH RANDOM SPACING TO SIMULATE NATURAL PLANT ESTABLISHMENT.

ANNUAL RYEGRASS (LOLIUM MULTIFLORUM) AT A RATE OF 1,5 LBS. / 1000 SQ. FT.

NORTHEAST WETLAND DIVERSITY MIX® - 1 POUND WILL COVER 21.750 SQ. FT. @ 100+ SEEDS PER SQ. FT. (4

NORTHEAST UPLAND WILDLIFE SEED MIX® - 48 LBS. / ACRE

DETAILED CONSTRUCTION PLANS, INCLUDING GRADING AND EROSION CONTROL PLANS, WILL BE PROVIDED TO THE SITE CONTRACTOR THE WETLAND CONSULTANT WILL MEET WITH THE ENGINEER AND SITE CONTRACTOR PRIOR TO CONSTRUCTION TO REVIEW THE CONSTRUCTION DETAILS AND WORK LIMITS. THE WEITAND CONSULTATIVILL INSPECT ALL PHASES OF THE MITIGATION DURING CONSTRUCTION. ORANGE CONSTRUCTION FENCING WILL BE PLACED, AS PER PLAN, TO DEMARCATE THE LIMITS OF EARTH WORK BY THE EXCAVATION/CONSTRUCTION CONTRACTOR TO PREVENT ENCROACHMENT ON WETLANDS OUTSIDE OF THE WORK LIMITS. SILT FENCE WILL BE INSTALLED IN ACCORDANCE WITH NEW YORK STATE STANDARDS FOR EROSION AND SEDIMENT CONTROL AND THE SWIPPE AS ARRIVED INSPECTION OF SILT FENCE WILL BE

ROUGH GRADING WILL BE IMPLEMENTED TO INCLUDE NUMEROUS SHALLOW "PITS & MOUNDS" CREATING MICRO-TOPOGRAPH" IN THE WETLAND CREATION AREAS. A MINIMUM OF 12 INCHES OF TOPSOIL WILL BE PLACED TO BRING THE MITIGATION AREA TO FINAL GRADE TOPSOIL SHOULD CONSIST OF LOAM FREE OF INVASIVE SPECIES, AND CONTAIN SUITABLE ORGANIC MATTER TO FACILITATE PLANT GROWTH

THE WETLAND CREATION AREAS AND ADJACENT SLOPES WILL BE SEEDED WITH ANNUAL RYE (LOLIUM MULTIFLORUM) AT A RATE OF 1.5 LBS/1000SQ.FT. IMMEDIATELY FOLLOWING FINAL GRADING.

WETLAND PLANTING PLAN:

THE WETLAND MITIGATION AREA WILL BE PLANTED IN THE SPRING OR FALL WITH APPROXIMATELY 600 18 TO 36- INCH POTTED SHRUBS AND SAPLINGS ON A 12-FOOT MATRIX IN THE SCRUB-SHRUBFORESTED WETAND CREATION AREAS. PLANTING PATTERN FOR ALL SPECIES SHOULD BE DONE IN A RANDOM FASHION AS OPPOSED TO EVENLY SPACED ROWS.

THE WETLAND MITIGATION AREA WILL BE SEEDED WITH 4 LBS. OF NORTHEAST WETLAND DIVERSITY MIX OR EQUIVALENT. (1 POUND WILL COVER 21,750 SQ.FT @ 100+ SEEDS PER SQ.FT.)

UPLAND BUFFER ENHANCEMENT NOTES:

THE ADJACENT GRADED UPLANDS OF EACH WETLAND CREATION AREA WILL BE SEEDED WITH 48 LBS/ACRE OF NORTHEAST UPLAND WILDLIFE SEED MIX. THIS SEED MIX WILL HELP STABILIZE THE UPLAND SOILS AND PROVIDE WILDLIFE BENEFITS

NOTES:

EROSION CONTROL PLAN DETAILS CONTAINED IN STORM WATER POLLUTION PREVENTION PLAN (SWPPP) PREPARED BY WESTON & SAMPSON, DISPOSAL SITE(S) FOR SPOILS FROM THE WETLAND CREATION AREAS WILL BE VERIFIED AS NON, ILIPISDICTIONAL LANDS BY THE WETLAND CONSULTAN

3 PLANTING SCHEDULE


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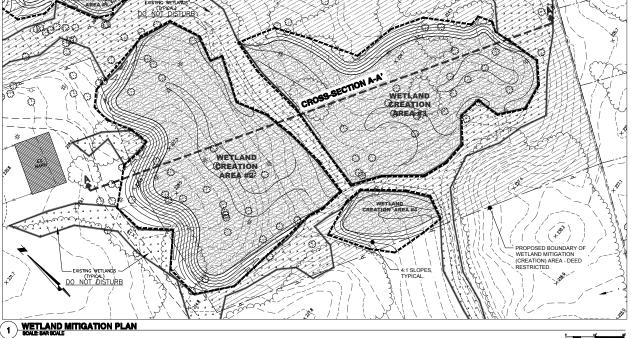
 A RISTALLATION OF SAFETY ORANGE PLASTIC FENCING (MINMUM 4° N HEIGHT) AROUND INDIVIDUAL
 TIRESS DESIGNED FOR PROTECTION. FENCINC SHALL BE NISTALLED AT THE OUTWARD UNIT OF THE
 BENEFICIAL TONG OF METER ORANGE PLANCE (MINMUM 4° N HEIGHT) AROUND GROUPS OF
 TREES DESIGNATED FOR PROTECTION.
 C. TREE MAYOR SHRUB BRANCHES IN THE WAY OF EQUIPMENT SHALL BE TRIMADED ACCORDING TO
 PROFESSIONAL HORTICULTURAL STANDARDS. UNDER NO CIRCUMSTANCES SHALL THE CONTRACTOR
 AND SUBE-CONTRACTORS USE COMPILATED TO DEBUT SHAND THE PROTECTION.


REQUIRED FENONS SHALL BE INSTALLED PRIOR TO THE INTIATION OF LIAND DISTURBING ACTIVITIES AND SHALL BE REMOVED AT THE CONCLUSION OF CONSTRUCTION, REMOVE DISTALED ROCKS FROM WILLIAMED MERCES, BY APPROVED EXCANATION, REMOVE TIESS WILLIAMED AREAS, BY APPROVED EXCANATION, REMOVE TIESS WILLIAM DO PERCONT ON MORE OF THEIR ROOT SYSTEMS DESTROYED. TREES DESIGNATED FOR REMOVAL SHALL BE REMOVED IN A MANNER THAT WILL NOT IMPROVED ADJACENT TIESS.

LANDSCAPE REPLACEMENT.
REMOVE TREES AND OTHER LANDSCAPE FEATURES SCARRED OR DAMAGED BY EQUIPMENT OPERATIONS, AND REPLACE WITH EAVISACE IL UNDAMAGED TREES AND LANDSCAPE FEATURES. REPLACEMENT OF TREES SHALL OCCUR ON A ONE-TO-ONE BASIS.





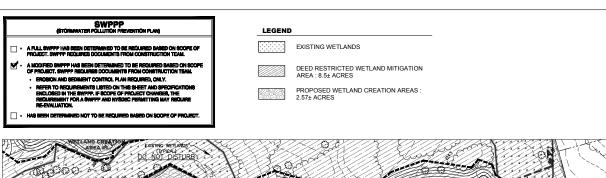

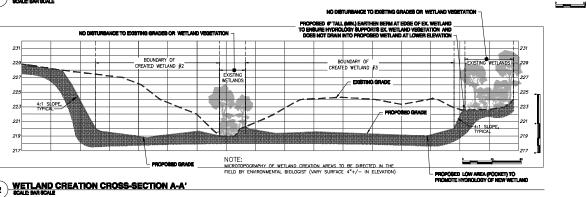

APPLICANT: WILLIAM J. CADE Weston@Sampsoff Winners Circle, Suite 130 Albany, New York 12205 Tel:(518) 463-4400 (800) SAMPSON ww.westonandsampson.co Date: 01-18-18 Scale: 1" = 40', SEE BAR SCALE Reviewed By: DTF Approved By

PHILLIPIN

KILL MANOR

SUBDIVISION


TOWN OF BETHLEHEN


ALBANY COUNTY

Drawing Title: WETLAND **MITIGATION PLAN**


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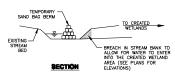
SHEET 3 OF 4



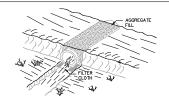

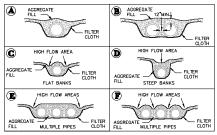
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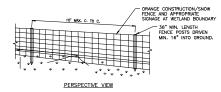


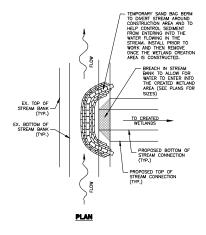

STREAM DIVERSION AND PROTECTION

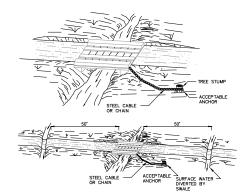


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CONSTRUCTION SPECIFICATIONS


- ORANGE CONSTRUCTION/SNOW FENCE TO BE FASTENED SECURELY TO FENCE POSTS WITH WIRE TIES OR STAPLES. POSTS SHALL BE 2''x2'' HARDWOOD.
- WHEN TWO SECTIONS OF GRANGE CONSTRUCTION/SNOW FENCE ADJOIN EACH OTHER THEY SHALL BE OVER-LAPPED BY 12 INCHES AND SECURED.

WETLAND FENCE DETAIL



- 2. EMBED FILTER CLOTH A MINIMUM OF 6" BELOW FINISHED GRADE.
- 3. WHEN TWO SECTIONS OF FILTER CLOTH ADJOIN EACH OTHER THEY SHALL BE OVER A MINIMUM OF SIX INCHES AND FOLDED.
- 5. ENCIRCLE ALL SOIL STOCKPILES, TEMPORARY OR PERMANENT.
- 6. PREFABRICATED UNITS SHALL BE GEOFAB, ENVROFENCE OR APPROVED EQUIVALENT

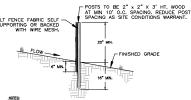SILT FENCE DETAIL

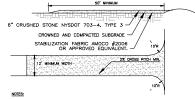

- STABILIZATION FABRIC SHALL BE PLACED OVER THE ENTIRE ENTRANCE AREA PRIOR TO PLACING OF STONE, OVERLAP FABRIC PER MANUFACTURER'S SPECIFICATIONS.
- 3. WHEN EQUIPMENT WASHING IS REQUIRED IT SHALL BE DONE ON A SEPARATE AREA ADJACENT TO THE ENTRANCE ROAD AND STABILIZED WITH STORE, EQUIPMENT WASHING WILL BE REQUIRED IF ROAD RECEIVES SIGNIFICANT SOLIS OR DEBRIS ACCORDING TO JUDGMENT BY OWNER OR OWNER'S REPRESENTATIVE.
- KEEP ROADS CLEAR OF STONES, MUD, AND OTHER CONSTRUCTION DEBRIS, CLEAN PAVEMENT AS ACCUMULATIONS WARRANT AND AS ORDERED BY ENGINEER,
- 5. REMOVE SILT ACCUMULATIONS ROUTINELY AND DISPOSE OF PROPERLY SUCH THAT WATER QUALITY IS NOT IMPAIRED, DO NOT INTRODUCE SILT INTO DRAINAGE SYSTEM OR TOPPOUT (RESTORATION APPEA).

STABILIZED CONSTRUCTION ENTRANCE PAD DETAIL

GENERAL NOTES

- THE CONTRACTOR SHALL VERIFY PROPOSED GRADES PRIOR TO CONSTRUCTION AND REPORT ANY DISCREPANCIES TO THE OWNER'S REPRESENTATIVE.

- 18. ANY AREA OUTSIDE THE LIMIT OF WORK THAT IS DISTURBED SHALL BE RESTORED TO ITS ORIGINAL CONDITION AT NO COST TO THE OWNER.
- 20. CONSTRUCTION AND/OR DISTURBANCE SHALL NOT EXTEND BEYOND OWNER'S PROPERTY WITHOUT WRITTEN PERMISSION (PERMIT'S) (FROM AD INCENT LANCOWNERS

SUGGESTED EROSION CONTROL CONSTRUCTION SCHEDULE:

- - WHERE THE INITIATION OF STABILIZATION MEASURES BY THE 14TH DAY AFTER CONSTRUCTION ACTIVITY TEMPORARILY OR

GENERAL MAINTENANCE PLAN:

PHILLIPIN

KILL MANOR SUBDIVISION

TOWN OF BETHLEHEN ALBANY COUNTY

> APPLICANT: WILLIAM J. CADE

Weston@Sampsoff

Winners Circle, Suite 130, Albany, New York 12205

Tel:(518) 463-4400 (800) SAMPSON ww.westonandsampson.cor


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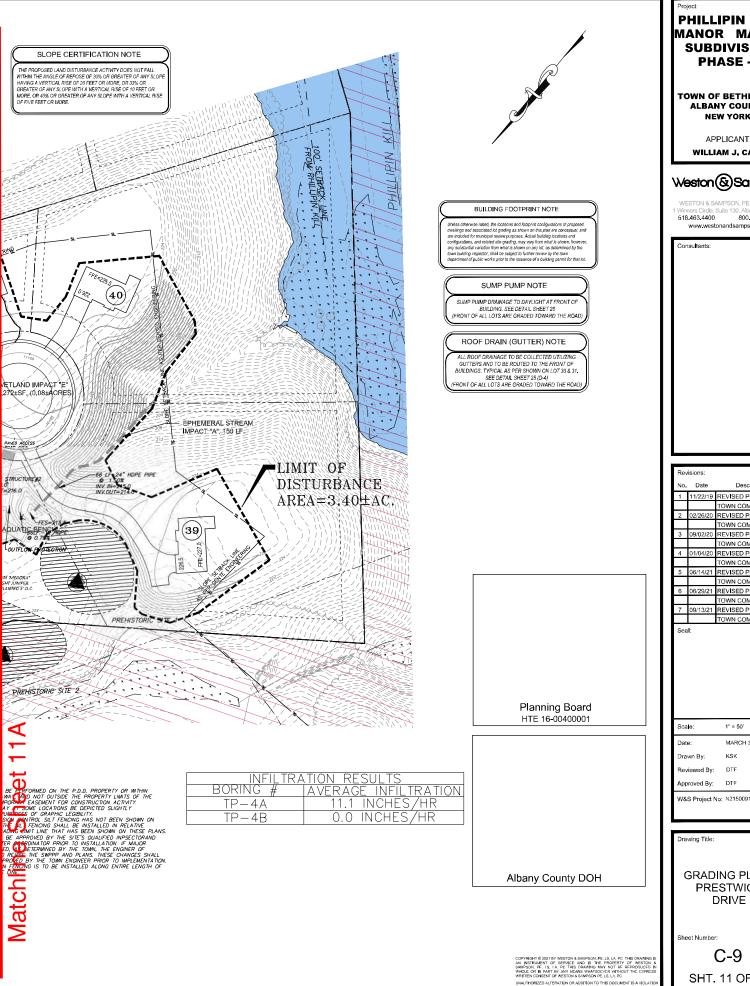
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WETLAND MITIGATION PLAN

W-4 SHEET 4 OF 4





PHILLIPIN KILL

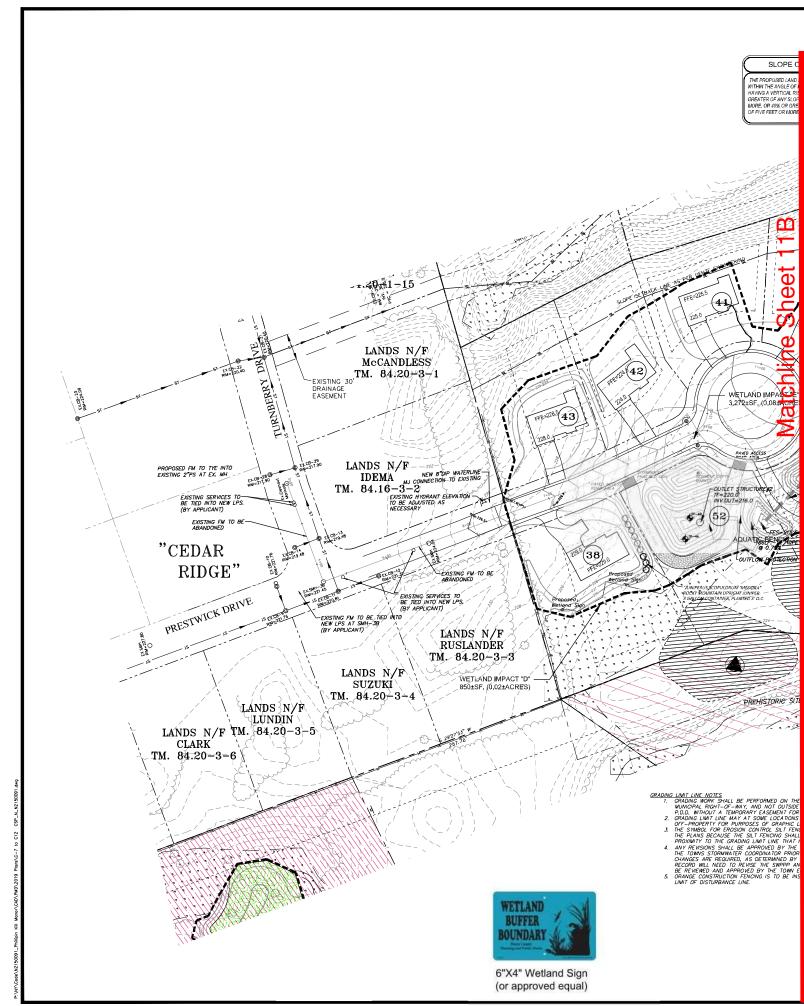MANOR MAJOR **SUBDIVISION** PHASE - 1

TOWN OF BETHLEHEM ALBANY COUNTY NEW YORK

> APPLICANT: WILLIAM J. CADE

Weston & Sampson

Winners Circle, Suite 130, Albany, NY 1220 518.463.4400 800.SAMPSON www.westonandsampson.com

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MARCH 30, 2018


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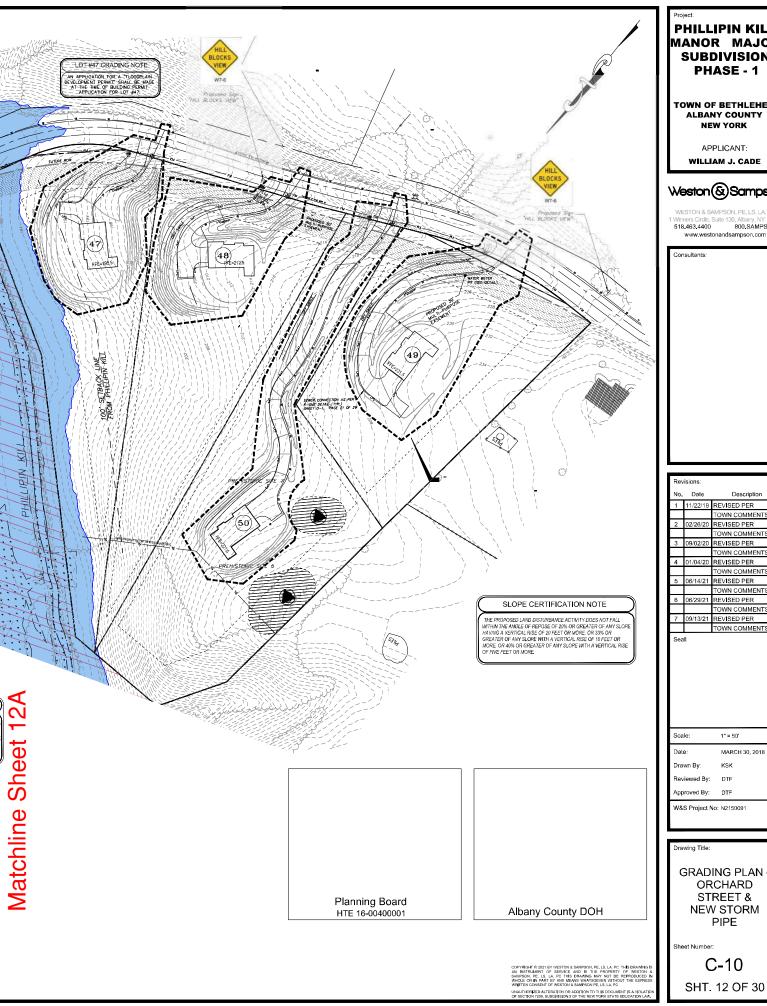
GRADING PLAN -PRESTWICK DRIVE

Sheet Number:

C-9

SHT. 11 OF 30



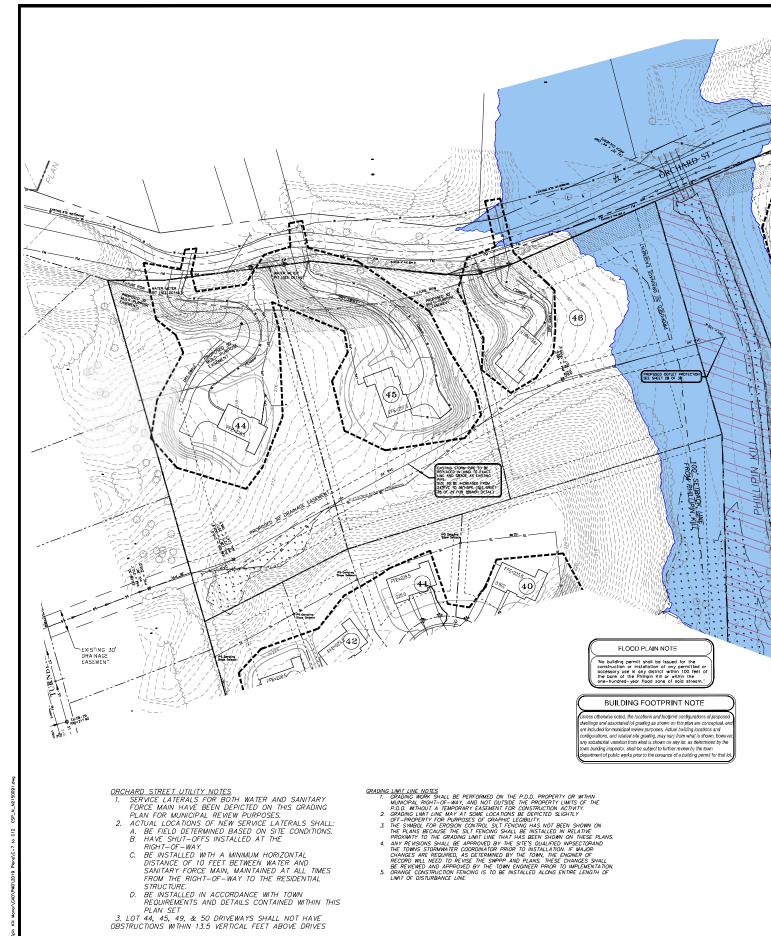

PHILLIPIN KILL MANOR MAJOR **SUBDIVISION**

> TOWN OF BETHLEHEM **ALBANY COUNTY NEW YORK**

> > WILLIAM J. CADE

Weston & Sampson


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GRADING PLAN -ORCHARD STREET & NEW STORM **PIPE**

C-10



PHILLIPIN KILL MANOR MAJOR SUBDIVISION PHASE - 1

> TOWN OF BETHLEHEM ALBANY COUNTY NEW YORK
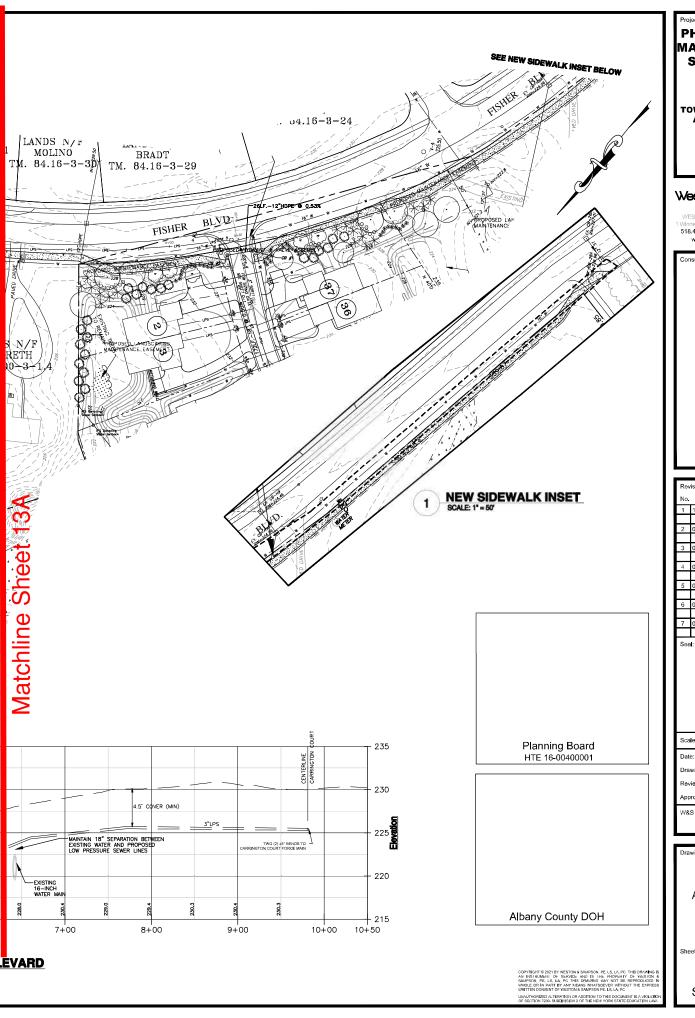
> > APPLICANT: WILLIAM J. CADE

Weston & Sampson

WESTON & SAMPSON, PE, LS, LA, PC 1 Winners Circle, Suite 130, Albany, NY 1220 518.463.4400 800.SAMPSON www.westonandsampson.com

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| Reviewed By: | | DTF | |
| App | roved By: | DTF | |
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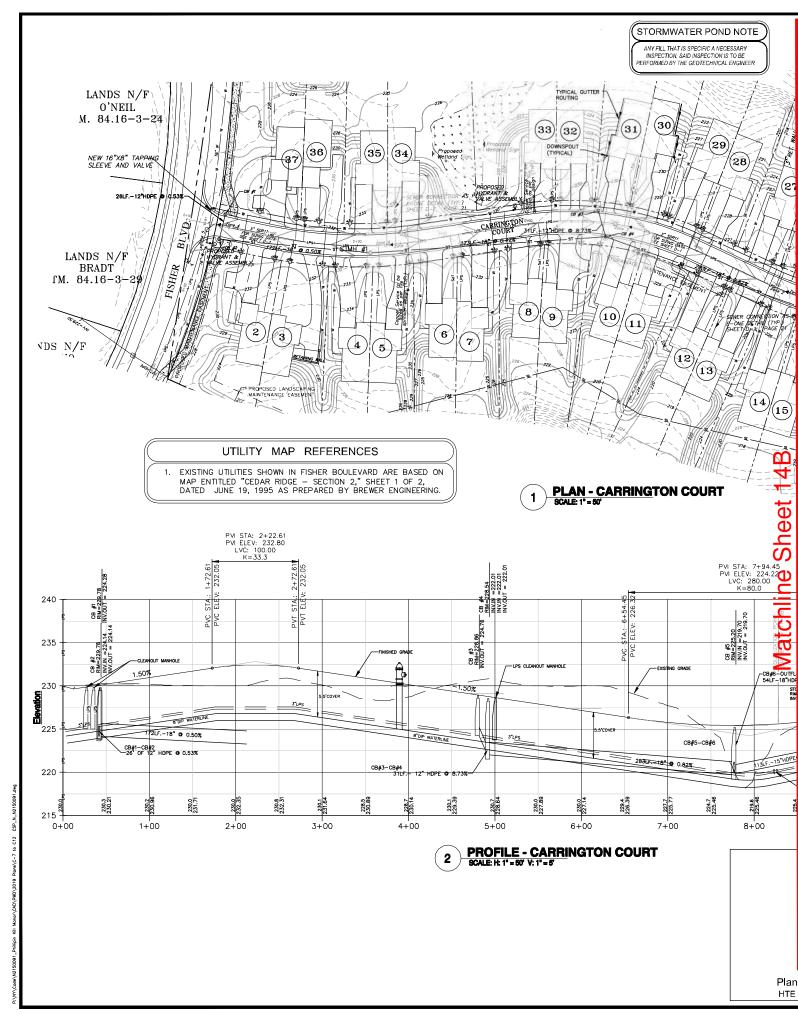
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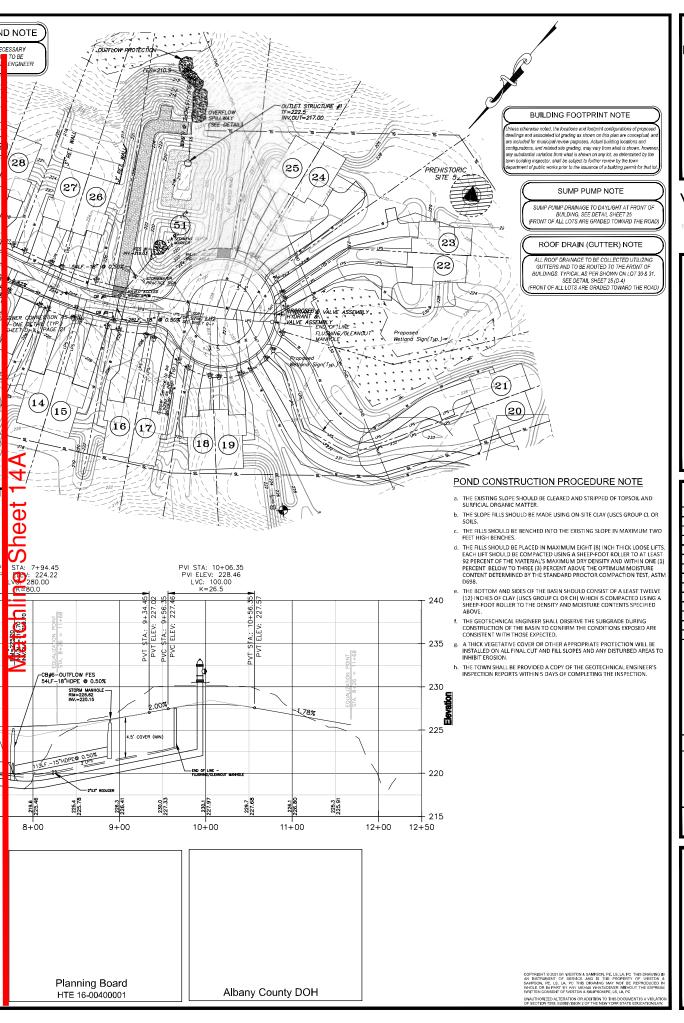
UTILITY PLAN AND PROFILE -FISHER BOULEVARD

Sheet Number:

C-11

SHT. 13 OF 30





PHILLIPIN KILL
MANOR MAJOR
SUBDIVISION

TOWN OF BETHLEHEM ALBANY COUNTY NEW YORK

PHASE - 1

APPLICANT: WILLIAM J. CADE

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1 Winners Circle, Suite 130, Albany, NY 1220 518.463.4400 800.SAMPSON

Consultants:

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 Drawn By:
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 Reviewed By:
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 Approved By:
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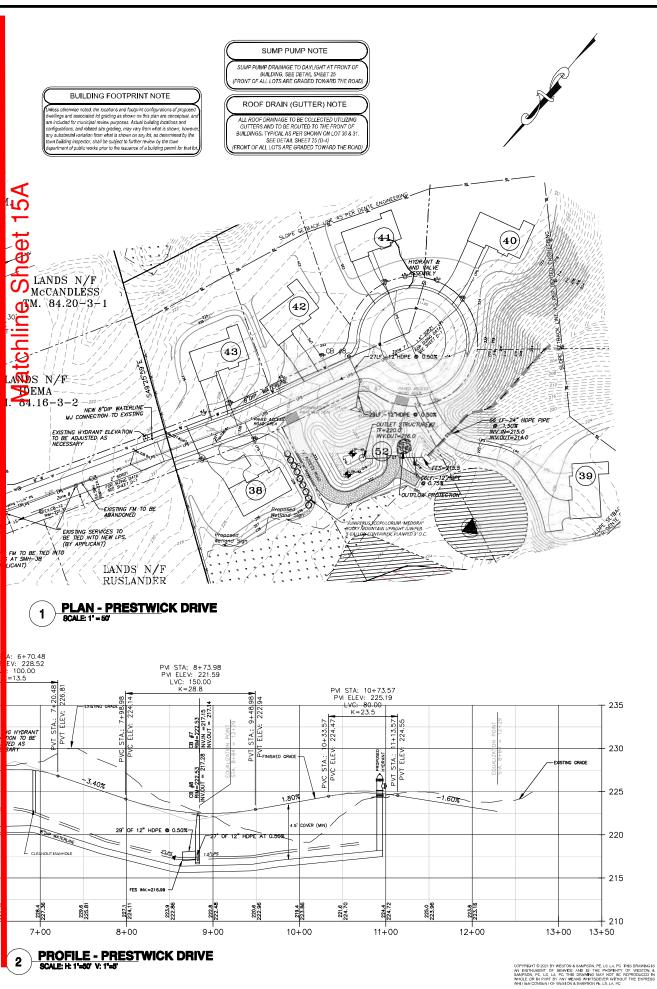
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 N2150091

Drawing Title:

UTILITY PLAN AND PROFILE -CARRINGTON COURT

Sheet Number:

C-12 SHT. 14 OF 30



PHILLIPIN KILL Manor Major Subdivision

> TOWN OF BETHLEHEM ALBANY COUNTY NEW YORK

PHASE - 1

APPLICANT: WILLIAM J. CADE

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 W&S Project No.
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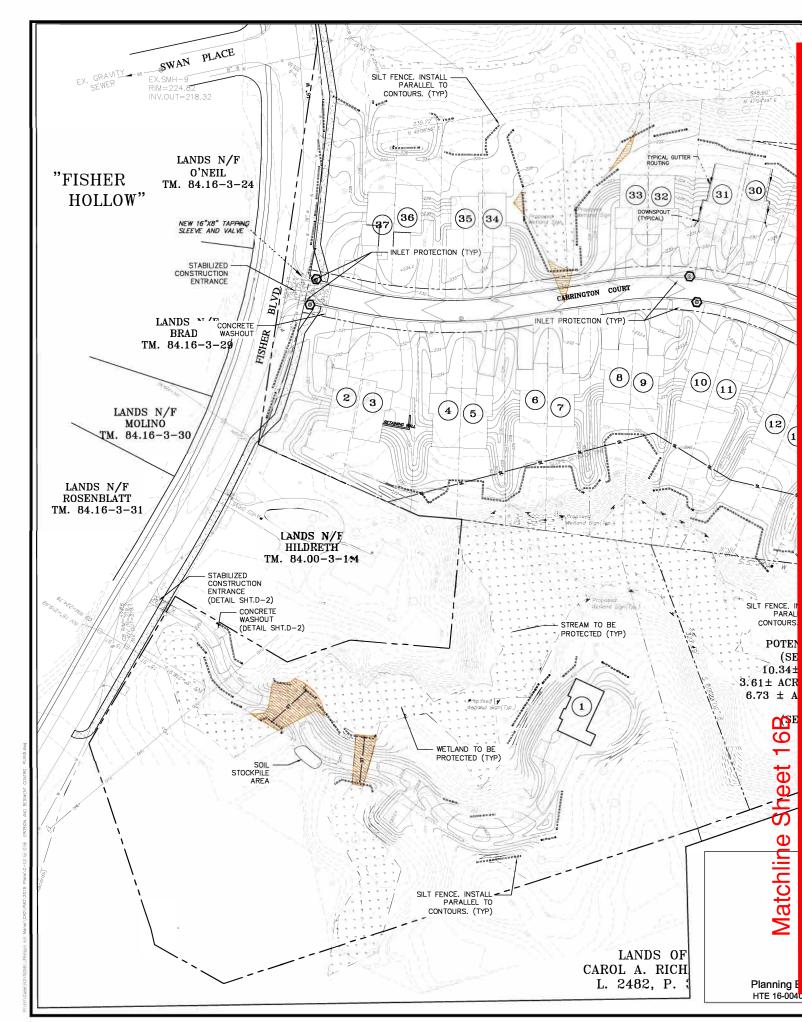
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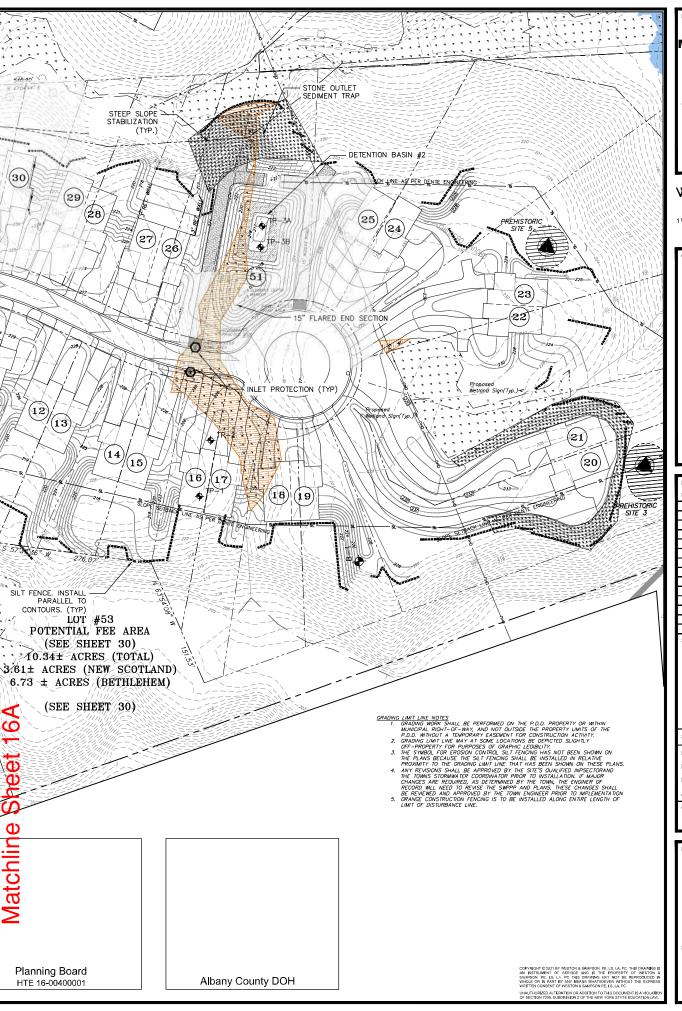
UTILITY PLAN AND PROFILE -PRESTWICK DRIVE

Sheet Number:

C-13

SHT. 15 OF 30





PHILLIPIN KILL MANOR MAJOR SUBDIVISION PHASE - 1

> TOWN OF BETHLEHEM ALBANY COUNTY NEW YORK

> > APPLICANT: WILLIAM J. CADE

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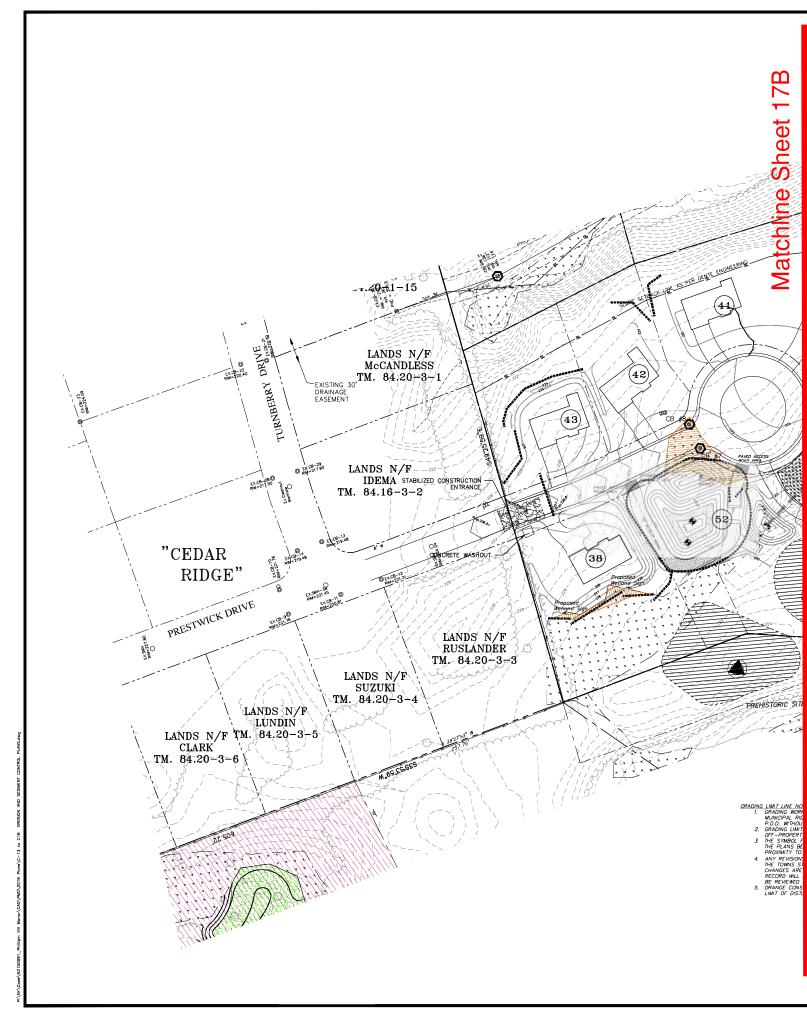
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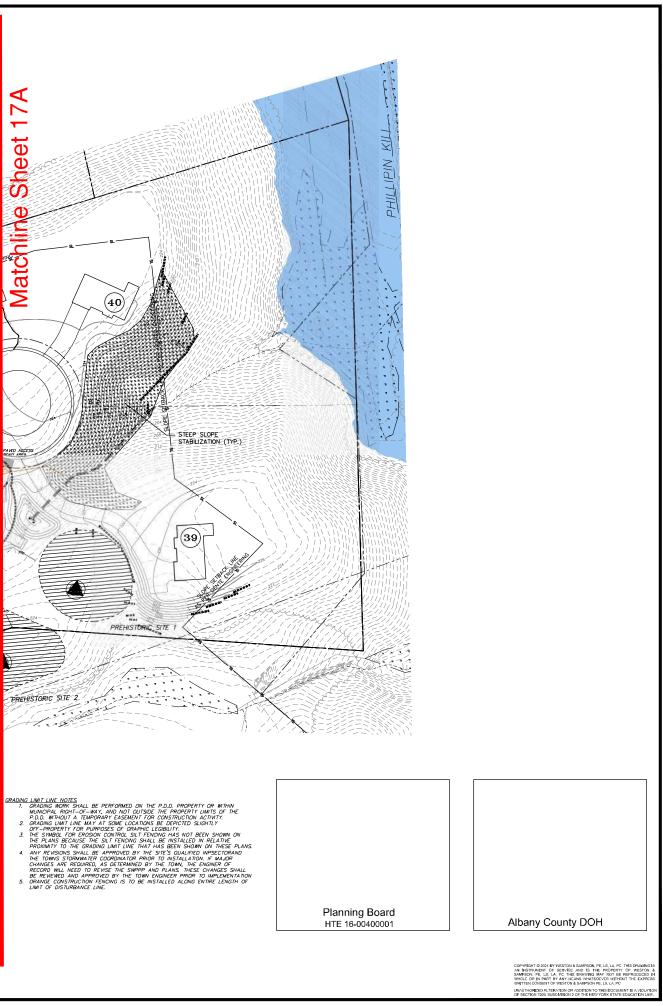
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EROSION AND SEDIMENT CONTROL PLAN -CARRINGTON COURT

Sheet Number:

C-14 SHT. 16 OF 30





Project:

PHILLIPIN KILL MANOR MAJOR SUBDIVISION PHASE - 1

TOWN OF BETHLEHEM ALBANY COUNTY NEW YORK

APPLICANT: WILLIAM J. CADE

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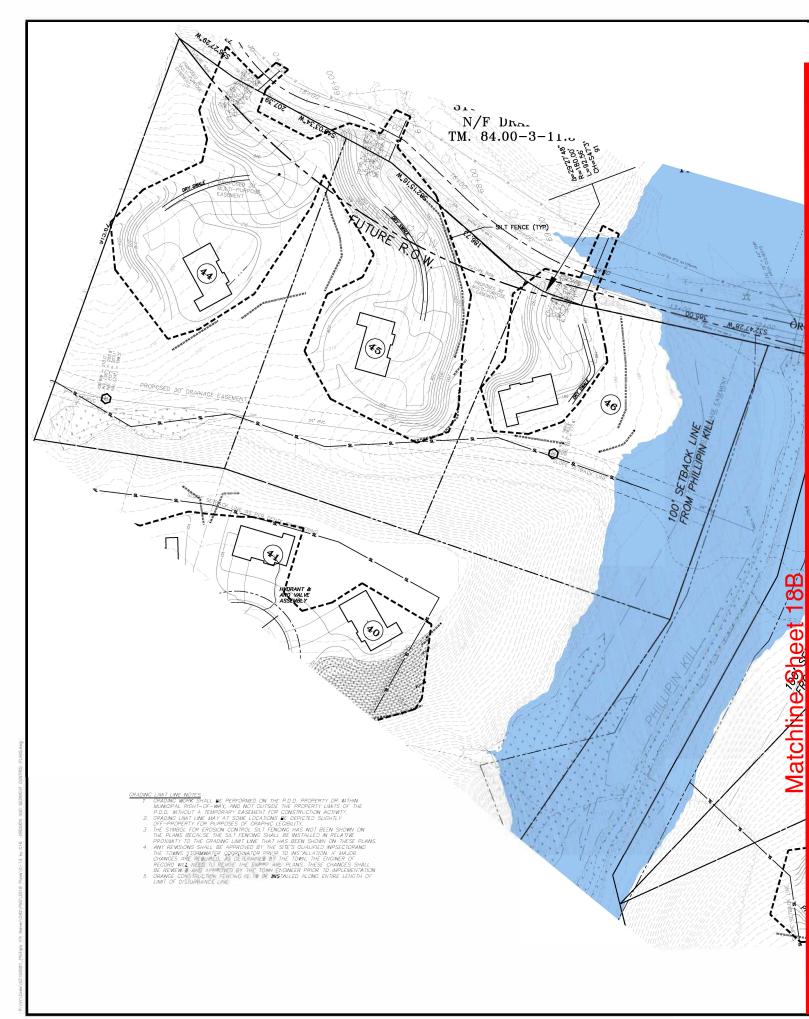
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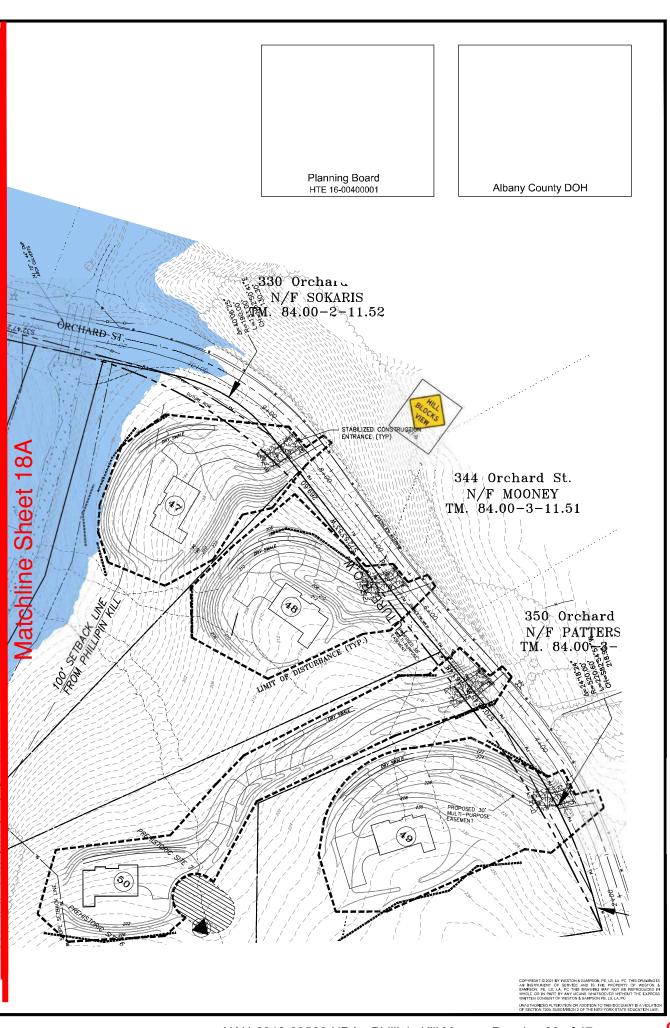
EROSION AND SEDIMENT CONTROL PLAN -PRESTWICK DRIVE

Sheet Number:

C-15

SHT. 17 OF 30





PHILLIPIN KILL MANOR MAJOR SUBDIVISION PHASE - 1

TOWN OF BETHLEHEM ALBANY COUNTY **NEW YORK**

APPLICANT:

WILLIAM J. CADE

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EROSION AND SEDIMENT CONTROL PLAN -**ORCHARD STREET**

Sheet Number:


C-16

SHT. 18 OF 30

HTE 16-0040

SCHEDULE QUANTITY SIZE -2.5" CAL. ·2.5" CAL SINGLE TRUNK, B&B, 20'+ O.C. HIGH BRANCHED, B&B, 25'+ O.C. –<u>11' HT.</u> 10 10' CLUMP FORM, B&B, 20'-25' O.C FULL BRANCHING TO BASE, B&B, 12' O.C. FULL BRANCHING TO BASE, B&B, 5' O.C. HIGH BRANCHED, B&B, 25'+ O.C. UNIFORMLY BRANCHED, B&B, 12'-15' O.C. 6'-7' TALL CEDAR :AR -8' HT B&B, CONTAINER, 8' O.C 24"-30' 24"-30' CONTAINER, UNIFORM BRANCHING, 5' O.C.

FISHER BOULEVARD

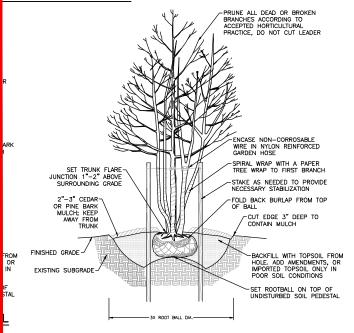

MULTI-STEMMED TREE PLANTING DETAIL

SCALE: NO SCALE

PROTECTION OF TREES:

PROTECT EXISTING TREES WHICH ARE TO REMAIN AND WHICH MAY BE INJURED, BRUISED, DEFACED, OR OTHERWISE DAMAGED BY CONSTRUCTION OPERATIONS, UTILIZING STANDARD TREE PROTECTION CRITERIA INCLUDING:

- A. INSTALLATION OF SAFETY O'RANGE PLASTIC FENCING (MINIMUM 4' IN HEIGHT) AROUND INDIVIDUAL TREES DESIGNED FOR PROTECTION, FENCING SHALL BE INSTALLED AT THE OUTWARD LIMIT OF THE TREES DIRILING OR EXTENT OF CANOPY COVER.

 B. INSTALLATION OF SAFETY O'RANGE PLASTIC FENCING (MINIMUM 4' IN HEIGHT) AROUND GROUPS OF TREES DESIGNATED FOR PROTECTION.


 C. TREE ANDIONS GHRUB BRANCHES IN THE WAY OF EQUIPMENT SHALL BE TRIMMED ACCORDING TO PROFESSIONAL HORTICULTURAL STANDARDS. UNDER NO CIRCUMSTANCES SHALL THE CONTRACTOR AND SUB-CONTRACTORS USE EQUIPMENT TO DEMOLISH BRANCHES AS WORK PROCEEDS.


REQUIRED FENCING SHALL BE INSTALLED PRIOR TO THE INITIATION OF LAND DISTURBING ACTIVITIES AND SHALL BE REMOVED AT THE CONCLUSION OF CONSTRUCTION, REMOVE DISPLACED ROCKS FROM UNCLEARED AREAS, BY APPROVED EXCAVATION, REMOVE TREES WITH 30 PERCENT OR MORE OF THEIR ROOT SYSTEMS DESTROYED, REMOVAL OF TREES AND THE PROCEDURE FOR REMOVAL REQUIRES APPROVAL OF THE CONTRACTING OFFICET, REES DESIGNATED FOR REMOVAL SHALL BE REMOVED IN A MANNER THAT WILL NOT IMPACT ADJACENT TREES.

LANDSCAPE REPLACEMENT:


REMOVE TREES AND OTHER LANDSCAPE FEATURES SCARRED OR DAMAGED BY EQUIPMENT OPERATIONS, AND REPLACE WITH EQUIPMENT, UNDAMAGED TREES AND LANDSCAPE FEATURES. OBTAIN CONTRACTING OFFICERS APPROVAL BEFORE REPLACEMENT, REPLACEMENT OF TREES SHALL OCCUR ON A ONE-TO-ONE BASIS, REGIONALLY NATIVE PLANTS AS SPECIFIED BY THE STATION "INTEGRATED NATURAL RESOURCES MANAGEMENT PLANT (INRMP) SHALL BE USED AS REPLACEMENT LANDSCAPE FEATURES.

PROTECTION OF TREES

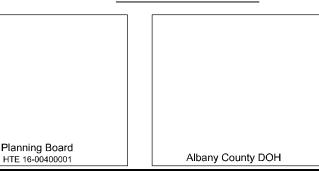

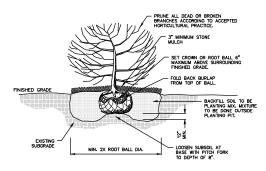


SHRUB PLANTING DETAIL

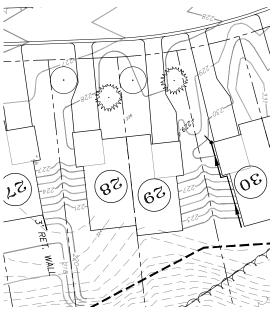

TYPICAL LOT PLANTING DETAIL

SCALE: 1"=30"

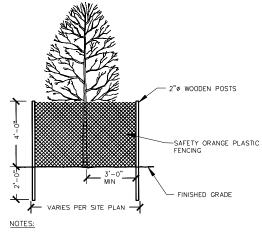

1. OUTSIDE EDGE OF GUARD SHOULD BE PLACED AT DRIPLINE. GUARDS MAY BE PLACED AROUND SINGLE TREES OR GROUPS OF TREES.

TREE PROTECTION DETAIL

SCALE: NO SCALE

Project:


PHILLIPIN KILL MANOR MAJOR **SUBDIVISION** PHASE - 1

TOWN OF BETHLEHEM ALBANY COUNTY **NEW YORK**

> APPLICANT: WILLIAM J. CADE

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Drawing Title LANDSCAPING **PLAN** Sheet Number: C-19 SHT. 21 OF 30

Reviewed By: CGC

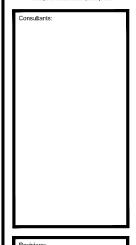
W&S Project No:N2150091

CONSTRUCTION SPECIFICATIONS

- AREA UNDER EMBANKMENT SHALL BE CLEARED, GRUBBED AND STRIPPED OF ANY VEGETATION AND ROOT MAT. THE POOL AREA SHALL BE CLEARED.
- THE FILL MATERIAL FOR THE EMBANKMENT SHALL BE FREE OF ROOTS AND OTHER WOODY VEGETATION AS WELL AS OVER-SIZED STONES, ROCKS, ORCANIC, MATERIAL OR OTHER OBJECTIONABLE MATERIAL THE EMBANKMENT SHALL BE COMPACTED BY TRAVERSING WITH EQUIPMENT WHILE IT IS BEING CONSTRUCTED.
- ALL CUT AND FILL SLOPES SHALL BE 2:1 OR FLATTER.
 THE STONE USED IN THE OUTLET SHALL BE SMALL RIPRAP 4"-8" ALONG WITH A 1" THICKNESS OF 2" AGGREGATE PLACED ON THE UP-GRADE SIDE ON THE SMALL RIPRAP OR EMBEDDED FILTER CLOTH IN THE RIPRAP.
- SEDIMENT SHALL BE REMOVED AND TRAP RESTORED TO ITS ORIGINAL DIMEN-SIONS WHEN THE SEDIMENT HAS ACCUMULATED TO 1/2 THE DESIGN DEPTH OF THE TRAP. IT SHALL BE PLACED ON SITE AND STREILIZED.
- 6. THE STRUCTURE SHALL BE INSPECTED AFTER EACH RAIN AND REPAIRS MADE AS NEEDED.
- CONSTRUCTION OPERATIONS SHALL BE CARRIED OUT IN SUCH A MANNER THAT EROSION AND SEDIMENT ARE CONTROLLED.
- THE STRUCTURE SHALL BE REMOVED AND THE AREA STABILIZED WHEN THE DRAINAGE AREA HAS BEEN PROPERLY STABILIZED.

MAXIMUM DRAINAGE AREA 5 ACRES

STONE OUTLET SEDIMENT TRAP

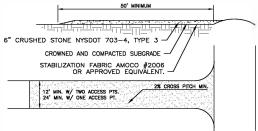


- 1. STABILIZATION FABRIC SHALL BE PLACED OVER THE ENTIRE ENTRANCE AREA PRIOR TO PLACING OF STONE.

 OVERLAP FABRIC PER MANUFACTURER'S SPECIFICATIONS.
- ALL SURFACE WATER FLOWING OR DIVERTED TOWARDS THE CONSTRUCTION ENTRANCE SHALL BE PIPED BENEATH THE ENTRANCE ROAD.
- WHEN EQUIPMENT WASHING IS REQUIRED IT SHALL BE DONE ON A SEPARATE AREA ADJACENT TO THE ENTRANCE ROAD AND STABILIZED WITH STONE, EQUIPMENT WASHING WILL BE REQUIRED IF ROAD RECEIVES SIGNIFICANT SOLLS OF DIBBROAD ACCEPTION. TO JUDICIANT BY OWNER BY SHREYS REPRESTATIVE.
- KEEP ROADS CLEAR OF STONES, MUD, AND OTHER CONSTRUCTION DEBRIS. CLEAN PAVEMENT AS ACCUMULATIONS WARRANT AND AS DRIBERED BY ENGINEER.
- REMOVE SILT ACQUINILATIONS ROUTINELY AND DESPOSE OF PROPERLY SUCH THAT WATER QUALITY IS NOT IMPAIRED, DO NOT INTRODUCE SILT INTO DRAINAGE SYSTEM OR TOPSCIL/RESTCRATION AREAS.

STABILIZED CONSTRUCTION ENTRANCE

SCALE: NO SCALE

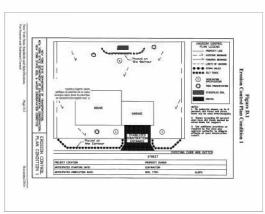

E&S CONTROL PLAN FOR SMALL HOMESITE CONSTRUCTION

USE METAL COUPLET POLE SECTION B CONDITIONS WHERE PRACTICE APPLIES MAXIMUM ALLOWABLE SLOPE LENGTHS CONTRIBUTING RUNOFF TO A SILT FENCE ARE: -SEE BACKFILL DETAIL FOR REQUIREMENTS MAXIMUM DRAINAGE AREA FOR OVERLAND FLOW TO A SILT FENCE SHALL NOT EXCEED 1/2 ACRE PER 100 FEET OF FENCE; AND

TEMPORARY SILT FENCE SOIL EROSION CONTROL

4. THERE IS NO CONCENTRATION OF WATER FLOWING TO THE BARRIER.

SCALE: NO SCALE

EROSION & SEDIMENT CONTROL NOTES

- CONTRACTOR SHALL REFER TO STORMWATER POLLUTION PREVENTION PLAN [SWPPP] THAT WAS PREPARED FOR THIS PROJECT.
- 2. ALL EROSION & SEDIMENT CONTROL MEASURES SHALL ADHERE TO THE PROJECT'S STORMWATER POLUTION PREVENTION PLAN (SWPPP). ALL APPROPRIATE STORMWATER CONTROL MEASURES DENTIFIED IN THE SWPPP SHALL BE IN PLACE BEFORE COMMENCING CONSTRUCTION OF ANY SEGMENT OF THE PROJECT THAT REQUIRES THESE MEASURES.
- INSPECTIONS: THE OPERATOR SHALL HAVE A QUALIFIED PROFESSIONAL CONDUCT AN ASSESSMENT OF THE SITE PRIOR TO THE COMMENCEMENT OF CONSTRUCTION & CERTIFY IN AN INSPECTION REPORT THAT THE APPROPRIATE EROSION & SEDIMENT CONTROLS DESCRIBED IN THE SWEPP HAVE BEEN ADEQUATELY INSTALLED OR IMPLEMENTED TO ENSURE OVERALL PREPAREDNESS OF THE SITE FOR THE COMMENCEMENT OF CONSTRUCTION, STEIN ENSPECTIONS SHALL BE CONDUCTED BY THE QUALIFIED PROFESSIONAL AT LEAST EVERY 7 CALENDAR DAYS & WITHIN 24 HOURS OF THE END OF A STORM EVENT OF 0.5 NOHES OR REGEATER, INSPECTIONS SHALL DISCOVERY OF SITE OF A STORM EVENT OF 0.5 NOHES OR REGEATER, INSPECTIONS SHALL DISCOVERY OF SITE OF SIT
- SITE LOG/CERTIFICATION: THE OPERATOR MUST MAINTAIN A RECORD OF ALL INSPECTION REPORTS IN A SITE LOG BOOK. THE SITE LOG BOOK MUST BE MAINTAINED ON-SITE & BE MADE AVAILABLE TO THE PERMITTING AUTHORITY UPON REQUEST.
- STABILIZATION: THE OPERATOR SHALL INITIATE STABILIZATION MEASURES AS SOON AS PRACTICABLE ON PORTIONS OF THE SITE WHERE CONSTRUCTION ACTIVITIES HAVE TEMPORARILY OR PERMANENTLY CEASED.
- MAINTENANCE: SEDIMENT SHALL BE REMOVED FROM TEMPORARY SEDIMENT TRAPS OR PONDS WHENEVER THEIR CAPACITY HAS BEEN REDUCED BY 50% OF THE DESIGN CAPACITY. INSTALL ADDITIONAL SEDIMENT TRAPS & BARRIERS AS NECEDED DURING CONSTRUCTION.
- 7. CONTRACTOR SHALL ESTABLISH A TEMPORARY STABLIZED CONSTRUCTION ENTRANCE TO CAPTURE MUD & DEBRIS FROM CONSTRUCTION VEHICLES BEFORE THEY ENTER A PUBLIC ROADWAY, AS DETAILED. SEDIMENT OF THE ROWNER SHALL BE REMOVED OR LEANED ON A PAILY SHASS. ALL BARE AREAS, E.G., EVAN SES, ONSTRUCTION ROUTES, & EQUIPMENT PARKING AREA, SHALL BE STABILIZED IMMEDIATELY AS CONSTRUCTION TAKES PLACE GRAVEL ON THESE AREAS OR MAINTAIN THE EXISTING VEGETATIVE COVER.
- 8. TEMPORARY CONSTRUCTION SILT FENCES, STRAW BALE DIKES, OR TRIANGULAR SILT DIKES SHALL BE PLACED ON OR PARALLEL TO CONTOURS WHERE THERE IS NO CONCENTRATION OF STORMWATER RUNOF FLOWING TO THEM & WHERE EROSION OCCURS IN THE FORM OF SHEET EROSION, AS DETAILED. THE AREA BELOW THESE TEMPORARY STRUCTURAL MEASURES SHOULD BE UNDISTURBED/UNEXCAVATED EARTH.
- DIVERT OFFSITE OR CLEAN STORMWATER RUNOFF FROM DISTURBED AREAS, CONVEY RUNOFF FROM HIGHLY EROBBLE SOLIS & SIETE SLOPES TO MORE SUITABLE STABLE AREAS, INSTALL TRIANGULAR SILT BIKES TO REDUCE THE VELOCITY OF CONCENTRATED RUNOFF.
- LIMIT ALL CLEARING & EXCAVATION ACTIVITIES TO MAINTAIN EXISTING VEGETATIVE COVER AS MUCH AS PRACTICABLE, TOPSOLI SHALL BE STOCKPILED, PROTECTED, & STABILIZED IN AN AREA LOCATED AWAY FROM DRAINAGE CHANNELS.
- 11. WHEN ACTIVITIES TEMPORARILY CEASE DURING CONSTRUCTION, SOIL STOCKPILES & EXPOSED SOIL SHALL BE STABILIZED BY SEED, MULCH, OR OTHER APPROPRIATE MEASURES AS SOON AS POSSIBLE, BUT IN NO CASE MORE THAN 14 DAYS AFTER CONSTRUCTION ACTIVITY HAS CEASED, PERMANENT VEGETATION & LANDSCAPING SHALL BE INSTALLED IMMEDIATELY FOLLOWING FINAL GRADING.
- 12. NO GRADING, FILLING, OR OTHER DISTURBANCE IS ALLOWED WITHIN EXISTING DRAINAGE SWALES, UNLESS INDICATED ON THE GRADING PLANS.
- 13. BACKFILL & STABILIZE ALL UTILITY TRENCHES DAILY.
- 14. SEDING:

 A. SOPE CRASS SEED BETWEEN APRIL 1 & MAY 15TH OR BETWEEN AUGUST 15TH & OCTOBER 15TH,
 ENCEPT AS DINERWISE APPROVED IN WRITING BY THE ENGINEER, NO SEEDING SHALL OCCUR ON FROZEN
 RHOUND, HIGHLY MUDDY SOILS, OR DURING EXTREME HEAT OR DROUGHT COMDITIONS.
 B. SEED MIXTURE: 40% FENWAY RED FESCUE, 30% ABBEY KENTUCKY BLUEGRASS BLEND, 20% DEVINE
 PRERNIAL RYE, & 10% ENCHANTED PERSINAL RYE. PROVIDE SEED MIXTURE EQUAL TO SCOTT'S PURE
 PRENIAL RYE, & 10% ENCHANTED PERSINAL RYE. PROVIDE SEED MIXTURE EQUAL TO SCOTT'S PURE
 PRENIAL SHALE NORTH GRASS SEED MIXTURE, OR APPROVED EQUIVALENT. VARIETY MAY BE
 ALTERED DEPENDING ON AVAILABILITY OF SEED FROM MANUFACTURER.

5. TOPSOIL: A. PROVIDE TOPSOIL FROM EXISTING STOCKPILES STRIPPED FROM THE PROJECT SITE & APPROVED BY THE ENGINEER. IF REQUIRED, PROVIDE ADDITIONAL TOPSOIL CONFORMING TO THE FOLLOWING. B. ORIGINAL LOAN TOPSOIL, WELL DRAINED HOMOGENEOUS TEXTURE & OF UNIFORM GRADE, WITHOUT THE ADMIXTURE OF SUBSOIL MATERIAL & ENTIRELY FREE OF DENSE MATERIAL, HARDPAN, SOD, OR ANY O'THER OSLECTIONABLE FOREIGN MATERIAL. C. CONTAINING NOT LESS THAN 45 NOR MORE THAN 20X ORGANIC MATTER IN THAT PORTION OF A SMALL AT ASING LESS THAN 152 NOR MORE THAN 20X ORGANIC MATTER IN THAT PORTION OF A SMALL AT ASING CALES OF THE SEVE WHEN DETERMINED BY THE WET COMBUSTION METHOD ON A SAMPLE D. CONTAINING APPLY VALUE WITHIN THE RANGE OF 4.5 TO 7 ON THAT PORTION OF THE SAMPLE THAT PRASSES A 14 MICH SIEVE

16. FERTILIZER:

4. MIXED COMMERCIAL FERTILIZERS SHALL CONTAIN TOTAL NITROGEN, AVAILABLE PHOSPHORIC ACID & SMLUBLE POTASH IN THE RATIO OF 10-6-4 (50% N/UF). 50% OF TOTAL NITROGEN SHALL BE DERIVED FROM UREA-FORM FURNISHING A MINIMUM OF 3.5% WATER INSCULDIBLE MITROGEN (3.5% WIN). THE BALAN BE THE INTROGEN SHALL BE PRESENT AS METHYLEN UREA, WATER-SOLUBLE UREA, INTRATE & AMMONIACAL COMPOUNDS. OTHER FERTILIZERS MEETING NYSDOT SPECIFICATION SECTION 713-03 FERTILIZER CAN BE USED.

17. MULCH:

A. DRY APPLICATION, STRAW: STALKS OF OATS, WHEAT, RYE OR OTHER APPROVED CROPS THAT ARE
FREE OF NOXIOUS WEED SEEDS. WEIGHT SHALL BE BASED ON A 15% MOISTURE CONTENT.

B. HYDRO APPLICATION: COLORED WOOD CELLULOSE FIBER PRODUCT SPECIFICALLY DESIGNED FOR USE AS
A HYDRO-MECHANICAL APPLIED MULCH, BY CONWED HYDRO MULCH, CONWED FIBERS, OR APPROVED
EQUIVALENT.

A. HEAVY JUTE EROSION CLOTH WITH 12 INCH LENGTHS OF NO. 11 GAGE WIRE BENT TO FORM A "U" WARE STAPLE, BY JUTE PRODUCTS, INC., OR APPROVED EQUIVALENT.

19. EROSION CONTROL BLANKETS:

A. FOR USE IN REPLACE OF MULCH ON SLOPES GREATER THAN 5% AS SHOWN ON THE PLANS.

CONSISTING OF LIGHTWEIGHT PHOTODEGRADABLE POLYPROPYLENE NETS WITH AN APPROXIMATE WEIGHT OF 1.64 LBS/1,000 SQUARE FEET, DEGRADABLE THREAD, STRAW FIBER WITH AN APPROXIMATE WEIGHT OF 0.5 LBS/SQUARE YARD, WITH MANUFACTURET'S DOT STAPLE SYSTEM & 6 INCH BIOSTAKE'S BIODEGRADABLE BLANKET PIN FASTENERS. USE DEGRADABLE DUBLE NET STRAW BLANKET, PRODUCT NO. ST50 BY NORTH AMERICAN FREEN, OR APPROVED EQUIVALENT.

GRAS DITCHES/W

- 1. ALL SOIL EPOSION
 TO BE INSTALLED
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ANCHORING METHOD

1. PEG & TWINE

HAYERS! 3. WOOD CELLULOSE FIBER

4. MULCH ANCHORING TOOL

FOR SLOPES GREATER THAN OR EQUAL TO

WINTER STAE

- PREPARE A SNOW MANAGEMENT PLAN WIT WATER, REQUIRING CLEARED SNOW TO BE ACTIVITIES.
- 2. ENLARGE AND STABILIZE ACCESS POINTS MANAGEMENT ACTIVITIES MUST NOT DESTR PRACTICES.
- 3. A MINIMUM 25 FOOT BUFFER SHALL BE MA FENCE. MARK SILT FENCE WITH TALL STAKE
- DRAINAGE STRUCTURES MUST BE KEPT OP DAMS, OR DEBRIS FROM PLOWING OPERATIONS SHALL BE REMOVED.
- 6. SEDIMENT BARRIERS MUST BE INSTALLED A SILT FENCE AND OTHER PRACTICES REQUIR GROUND FREEZES.
- SOIL STOCKPILES MUST BE PROTECTED BY MULCH, ROLLED STABILIZATION MATTING, OI AT LEAST 15 FEET FROM THE TOE OF THE LOOSE SOIL.
- 8. IN AREAS WHERE SOIL DISTURBANCE ACTIVAPPLICATION OF SOIL STABILIZATION MEASU BUSINESS DAY AND COMPLETED WITHIN THUSED ON ALL SLOPES 3 HORIZONTAL TO

- 10. TO ENSURE ADEQUATE STABILIZATION OF DISTURBED SOIL SHOULD BE STABILIZED AT WORK WILL RESUME WITHIN 24 HOURS I
- B. THE WORK IS IN DISTURBED AREAS THAT TRENCHES, FOUNDATION EXCAVATIONS, O
- 11. USE STONE PATHS TO STABILIZE ACCESS
 WHERE CONSTRUCTION VEHICLE TRAFFIC IS
 IN WIDTH BUT WIDER AS NECESSARY TO A

GRASSED-LINED CHES/WATERWAY NOTES

- I. ALL SOIL EROSION AND SEDIMENT CONTROL PRACTICES
 TO BE INSTALLED PRIOR TO ANY MAJOR SOIL
 DISTURBANCE, OR IN THEIR PROPER SEQUENCE
 AND MAINTAINED UNTIL PERMANENT PROTECTION
 IS ESTABLISHED.
 IN THE SECOND OF THE SECOND OF SOODED ON ALL
 EXPOSED AREAS IMMEDIATELY AFTER FINAL GRADING;
 MULCH TO BE USED AS NECESSARY FOR PROTECTION UNTIL
 A PERMANENT VEGETATION TO BE SEEDED PROTECTION UNTIL
 A PERMANENT VEGETATIVE COVER CAN BE ESTABLISHED.
 A SUB-BASE COURSE WILL BE APPLIED INMEDIATELY FOLLOWING
 ROUGH GRADING AND INSTALLATION OF IMPROVEMENTS IN
 PARKING AREA LET STREATS, ROADS, DRIVENAYS, AND/OR
 PARKING AREA LET STREATS, ROADS, DRIVENAYS, AND/OR
 PARKING AREA LET STREATS, BROADS, DRIVENAYS, AND/OR
 PARKING AREA SEDIES OF COMMINIAND WILL RECEIVE A
 TEMPORARY SEDING IN COMMINIAND WILL RECEIVE A
 BE BACKFILLED AND STABILIZED DAILY, AS THE INSTALLATION
 PROCEEDS (G.S.OPES RECEIVEM PERMIC PROTECTION WILL BE INSECTION.)

 JALL REGISION AND SEDIMENT CONTROL PRACTICES WILL BE INSECTION.
- PHOLECUS (M.S.LUPES GREATER HAN 3:1)
 7. ALL EROSION AND SEDIMENT CONTROL PRACTICES WILL BE INSPECTED WEEKLY AND AFTER RAINFALL EVENTS NEEDED REPAIRS WILL BE MADE IMMEDIATELY.
 8. THE CONTRACTOR/OWNER SHALL BE RESPONSIBLE FOR MAINTAINING SOLL EROSION AND SEDIMENT CONTROL MEASURES UPON COMPLETION OF THE PROJECT.
- ALL ROADWAY DITCHES SHALL BE GRASS LINED TO PREVENT EROSION. THE TYPE OF VEGETATION PROTECTION USED WILL BE AS FOLLOWS:

| CHANNEL SLOPE 0-5% | LINING REED CANARY GRASS TALL FESCUE KENTUCKY BLUEGRASS | PERMISSABLE VELOCITY (FT/SEC) 5 |
|--------------------------|--|---------------------------------------|
| 0-5% | GRASS-LEGUME MIXTURE | 4 |
| 5-10% | REED CANARY GRASS TALL FESCUE KENTUCKY BLUEGRASS | 4 |
| 4 | GRASS-LEGUME MIXTURE | 3 |

SLOPE STABILIZATION

| TO BE ANCHORED | |
|----------------|---|
| HAY OR STRAW | AFTER MULCHING, DIVIDE AREAS INTO BLOCKS APPROXIMATELY, 19 in SIZE DRIVE 4-6 FEGS PER BLOCK TO WHITH 2 7 3 FF SOIL SURFACE. SECURE MUCHES-CROSS PATTERN ON EACH BLOCK. STOLING THE STATES OF SOIL SURFACE SECURE WHITE ACQUIDE DEFORM TO EACH BLOCK. STOLING TWINE ACQUIDE DEFORM TO EACH BLOCK. STOLING PEOS FLUSH WITH SOIL DRIVING STAKES INTO GROUND TIGHTENS THE TIMBLE. |

STABLE THE LIGHT-WEIGHT PAPER, JUTE, WOOD FIBER OR PLASTIC NETTINGS TO SOIL SURFACE ACCORDING TO MANUFACTURER'S RECOMMENDATIONS. SHOULD BE BIODEGRADABILE. MOST PRODUCTS ARE NOT SUITABLE FOR HAY OR STRAW

HAY OR STRAW

MIX AND APPLY POLYMERIC AND GUM TACKIFIERS ACCORDING TO MANUFACTURER'S INSTRUCTIONS. AVOID APPLICATION DURING RAIN. A 24-HOUR CURING PERIOD AND A SOIL TEMPERATURE HIGHER THAN 45' FAHRENHEIT ARE REQUIRED. HAY OR STRAW

ITER THAN OR EQUAL TO 3:1 USE ROLLED EROSION CONTROL PRODUCT FACTURED BY NORTH AMERICAN GREEN OR APPROVED EQUAL

HAY OR STRAW

ER STABILIZATION NOTES

MANAGEMENT PLAN WITH ADEQUATE STORAGE FOR SNOW AND CONTROL OF MELT CLEARED SNOW TO BE STORED IN A MANNER NOT AFFECTING ONGOING CONSTRUCTION

BILIZE ACCESS POINTS TO PROVIDE FOR SNOW MANAGEMENT AND STOCKPILING. SNOW ITIES MUST NOT DESTROY OR DEGRADE INSTALLED EROSION AND SEDIMENT CONTROL

T BUFFER SHALL BE MAINTAINED FROM ALL PERIMETER CONTROLS SUCH AS SILT FENCE WITH TALL STAKES THAT ARE VISIBLE ABOVE THE SNOW PACK.

ED AREAS THAT DRAIN TO A WATERBODY WITHIN 100 FEET WILL HAVE 2 ROWS OF I APART, INSTALLED ON THE CONTOUR.

RES MUST BE KEPT OPEN AND FREE OF SNOW AND ICE DAMS, ALL DEBRIS, ICE FROM PLOWING OPERATIONS, THAT RESTRICT THE FLOW OF RUNOFF AND MELTWATER,

S MUST BE INSTALLED AT ALL APPROPRIATE PERIMETER AND SENSITIVE LOCATIONS THER PRACTICES REQUIRING EARTH DISTURBANCE MUST BE INSTALLED BEFORE THE

UST BE PROTECTED BY THE USE OF ESTABLISHED VEGETATION, ANCHORED STRAW ABILIZATION MATTING, OR OTHER DURABLE COVERING. A BARRIER MUST BE INSTALLED FROM THE TOE OF THE STOCKPILE TO PREVENT SOIL MIGRATION AND TO CAPTURE

OIL DISTURBANCE ACTIVITY HAS TEMPORARILY OR PERMANENTLY CEASED, THE IL STABILIZATION MEASURES SHOULD BE INITIATED BY THE END OF THE NEXT COMPLETED WITHIN THREE (3) DAYS. ROLLED EROSION CONTROL BLANKETS MUST BE ES 3 HORZONTAL TO I VERTICAL OR STEEPER.


LONE IS USED FOR TEMPORARY STABILIZATION, IT SHALL BE APPLIED AT DOUBLE THE F 2 TONES PER ACRE, MAKING THE APPLICATION RATE 4 TONS PER ACRE, OTHER LCHES SHOULD BE APPLIED AT DOUBLE THE MANUFACTURER'S RECOMMENDED RATE.

JATE STABILIZATION OF DISTURBED SOIL IN ADVANCE OF A MELT EVENT, AREAS OF OULD BE STABILIZED AT THE END OF EACH WORK DAY UNLESS:

ME WITHIN 24 HOURS IN THE SAME AREA AND NO PRECIPITATION IS FORECAST OR;

DISTURBED AREAS THAT COLLECT AND RETAIN RUNOFF, SUCH AS OPEN UTILITY DATION EXCAVATIONS, OR WATER MANAGEMENT AREAS.

TO STABILIZE ACCESS PERIMETERS OF BUILDINGS UNDER CONSTRUCTION AND AREAS ON VEHICLE TRAFFIC IS ANTICHATED, STONE PATHS SHOULD BE A MINIMUM 10 FEET R AS NECESSARY TO ACCOMMODATE EQUIPMENT.

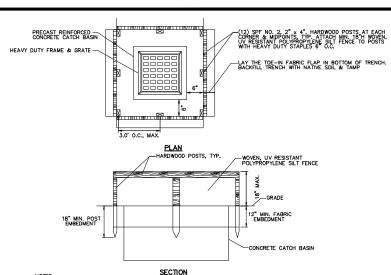

- CUT FABRIC FROM A CONTINUOUS ROLL TO ELIMINATE JOINTS. IF JOINTS ARE NEEDED THEY MUST BE OVERLAPPED TO THE NEXT STAKE.

 1 AGRE MASHIMU PRAINAGE AREA PER PROTECTION DEVICE.

 LAND AREA SLOPE IMMEDIATELY SURROUNDING THE PROTECTION DEVICE SHOULD NOT EXCEED 1%.

 REMOVE SEDIMENT FROM THE POOL AREA AS RECESSARY WITH CARE TO PREVENT UNDERCUTTING OR DAMAGING THE FILTER FABRIC.

 DAMAGING THE FILTER FABRIC.

TEMPORARY FILTER FABRIC CATCH BASIN PROTECTION DETAIL

CONSTRUCTION SPECIFICATIONS

- ALL GRADED OR DISTURBED AREAS INCLUDING SLOPES SHALL BE PROTECTED DURING CLEARING AND CONSTRUCTION IN ACCORDANCE WITH THE APPROVED SEDIMENT CONTROL PLAN UNTIL THEY ARE PERMANENTLY STABILIZED.
- ALL SEDIMENT CONTROL PRACTICES AND MEASURES SHALL BE CONSTRUCTED, APPLIED AND MAINTAINED IN ACCORDANCE WITH THE APPROVED SEDIMENT CONTROL PLAN AND THE "STANDARDS AND SPECIFICATIONS FOR SOIL EROSION AND SEDIMENT CONTROL IN DEVELOPING AREAS".
- TOPSOIL REQUIRED FOR THE ESTABLISHMENT OF VEGETATION SHALL BE STOCKPILED IN AMOUNT NECESSARY TO COMPLETE FINISHED GRADING OF ALL EXPOSED AREAS
- AREAS TO BE FILLED SHALL BE CLEARED, GRUBBED, AND STRIPPED OF TOPSOIL TO REMOVE TREES, VEGETATION, ROOTS OR OTHER OBJECTIONABLE MATERIAL SATISFACTORY FILLS.
- AREAS WHICH ARE TO BE TOPSOILED SHALL BE SCARIFIED TO A MINIMUM DEPTH OF FOUR INCHES PRIOR TO PLACEMENT OF TOPSOIL.
- ALL FILLS SHALL BE COMPACTED AS REQUIRED TO REDUCE EROSION, SLIPPAGE, SETTLEMENT, SUBSIDENCE OR OTHER RELATED PROBLEMS, FILL INTENDED TO SUPPORT BUILDINGS, STRUCTURES AND CONDUITS, ETC. SHALL BE COMPACTED IN ACCORDANCE WITH LOCAL REQUIREMENTS OR CODES.
- ALL FILL TO BE PLACED AND COMPACTED IN LAYERS NOT TO EXCEED 9 INCHES IN THICKNESS.
- EXCEPT FOR APPROVED LANDFILLS, FILL MATERIAL SHALL BE FREE OF FROZEN PARTICLES, BRUSH, ROOTS, SOD, OR OTHER FOREIGN OR OTHER OBJECTIONABLE MATERIALS THAT WOULD INTERFERE WITH OR PREVENT CONSTRUCTION OF FINISHED GRADING.
- FROZEN MATERIALS OR SOFT, MUCKY OR HIGHLY COMPRESSIBLE MATERIALS SHALL NOT BE INCORPORATED IN FILLS.
- FILL SHALL NOT BE PLACED ON SATURATED OR FROZEN SURFACES.
- ALL BENCHES SHALL BE KEPT FREE OF SEDIMENT DURING ALL PHASES OF DEVELOPMENT.
- SEEPS OR SPRINGS ENCOUNTERED DURING CONSTRUCTION SHALL BE HANDLED IN ACCORDANCE WITH THE STANDARD AND SPECIFICATION FOR SUBSURFACE DRAIN OR OTHER APPROVED METHOD.
- ALL GRADED AREAS SHALL BE PERMANENTLY STABILIZED IMMEDIATELY FOLLOWING FINISHED GRADING.
- STOCKPILES, BORROW AREAS AND SPOIL AREAS SHALL BE SHOWN ON THE PLANS AND SHALL BE SUBJECT TO THE PROVISIONS OF THIS STANDARD AND SPECIFICATION.

Planning Board HTE 16-00400001

Albany County DOH

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Project:

PHILLIPIN KILL MANOR MAJOR **SUBDIVISION** PHASE - 1

TOWN OF BETHLEHEM **ALBANY COUNTY** NEW YORK

> APPLICANT: WILLIAM J. CADE

Weston & Sampsoñ

WESTON & SAMPSON, PE. LS. LA. PC 1 Winners Circle, Suite 130, Albany, NY 12205 518 463 4400 800 SAMPSON westonandsampson.com

Consultants:

Nο Date Description REVISED PER 11/22/19 TOWN COMMENTS REV**I**SED PER REVISED PER TOWN COMMENT: REVISED PER TOWN COMMENTS REVISED PER TOWN COMMENTS 06/29/21 REVISED PER TOWN COMMENTS REVISED PER TOWN COMMENTS


AS SHOWN Date: MARCH 30, 2018 Drawn By CGC Reviewed By:

W&S Project No: N2150091

EROSION AND SEDIMENT CONTROL **NOTES AND DETAILS**


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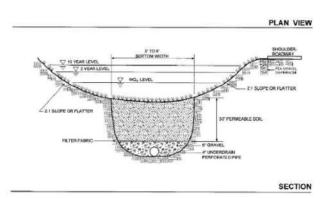
SHT. 23 OF 30

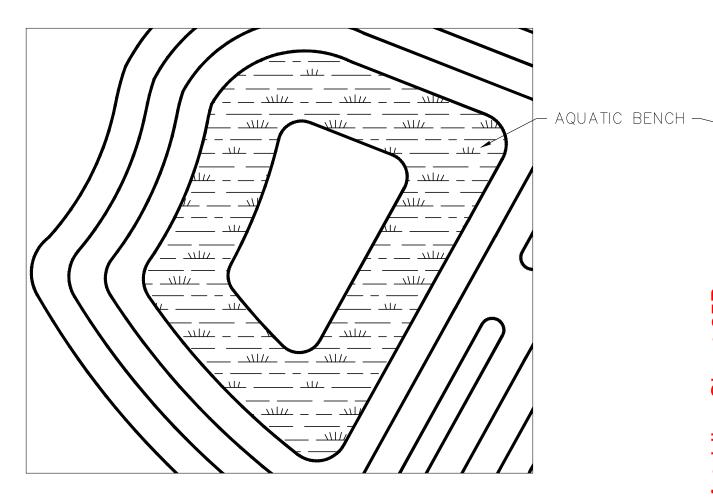

PRESTWICK POND AQUATIC BENCH

SCALE: NO SCALE



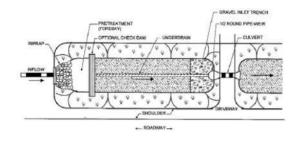

DRY SWALE DETAIL

SCALE: NO SCALE

- PLANT SPECIES SHALL BE GROUPED TOGETHER IN MASSES TO MIMIC NATURAL OCCURANCE. NATIVE PLANT SPECIES SHOULD BE USED, RATHER THAN FOREIGN
- SPECIES.
 PLANTING SHOULD BE BASED UPON ZONE OF HYDRIC TOLERANCE.
 SPECIES LAYOUT SHOULD GENERALLY BE RANDOM AND NATURAL —
 WHILE OVERALL AESTHETICS AND VISUAL CHARACTER SHOULD BE PRIME
- VISIDERATION.

 NOXIOUS WEEDS SHALL BE INCORPORATED IN PLANTING.

 RRANTEE ALL PLANT MATERIALS FOR ONE YEAR AS OUTLINED IN
 FIERD PLANTS SEPCIFICATIONS.

- PLANTS SHALL BE PLACED IN RANDOM PATTERNS, 18" O.C. MAX. (0.445 PLANTS PER SQUARE FOOT)
 HERBACEOUS PLANT MATERIALS SHALL BE 4" POTS OR PLUGS. SEEDING PLANT SPECIES SHALL NOT BE ACCEPTABLE.

PLANT AVAILABILITY VARIES: TO PROVIDE SOME FLEXIBILITY, CONTRACTOR SHALL SUBMIT LISTING OF PLANT SPECIES, QUANTITIES, AND SIZES FOR REVIEW AND APPROVAL BY ENGINEER PRICE TO INSTALLATION.


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|-------|-----|---|------|---------|-------|--|--|---|
| KEY | QTY | Herbacron Plants Plant Norse | Zore | Sam | Andre | brandstire Telerance | Water Vote | Nes |
| AB-01 | | Principal Park Princip (Regular to Anthritis) | n | Hegel | 710 | quit. | Minimum. Talansi padi esade astas for danta. | Approxima |
| AB-02 | | Canal (Tarks as) | 13 | Hagar | ye. | we/fi | Low Emopt second | Approvers. May alternate obser- species. Voluntur. High pollosed |
| AB-03 | | Contract Theory Square (8-Aprel paragrap) | 9 | Sour | ye. | MATERIA. | Tigh fresh. partic National and State | High restal precinal. |
| AB-04 | | State March District model | 2 | House | yes / | 16035 | High Cover. End tailures. Outcome darks, poss. material. Ed. Heating for Heating and | Quest to contribut, fixed to transition. Given for reclasions and abbilitations and are communitied. |
| AB-05 | | (Gast Entered) (Symptotic (september) | 33 | linger | | Require to provide the provide to th | High Food (stack, plant) status(sw), better it offer measures. Come for measures. | Stand speading Telephon purple ion, closel for shorther stabilization balledy 10.7 gps |
| AB-06 | | Secretarian | 1 | Times | yes | 1607.6 | Tors, maps wood-bads | Sapidarretti Olah Masel |
| AB-07 | | Parkentered President conduct | 131 | Neget | 900 | 9605 | Abstract Dada Note: for betarilise | Followin parks Jude |
| AB-08 | | Selpre (Carre ggs.) | 13 | Steamer | 900 | 407= | High materiors, employers | Mars without and refuel spales. |
| AB-09 | | Soft-man Palmath Strepar radials | 13 |)(mgn | 900 | 9906 | Mathematic Great Great and Seed | Pullinas. Aggresseri andresseri High polluture septemb |
| AB-10 | | Reserved chargement pp.) | 134 | Heaper | yes : | (MOV.) (5) | High Vistoritori, englants Sincti unit const | Fair releases: Arrial worky altern tech to F perfolimen |
| AB-11 | | Spatiations, (Asplice School) | 9 | Bagat. | 100 | wicht. | Modests for Southerings dir sous | Fait untinger. Tobacast of Swinning Halos lands. |
| AB-12 | | Work lates (harper operated | 13 | Brigar | yes | (tegulal); to especially introduced | Shelands, Crime, Front. | Rapping All our Cart bistorie unitie selfs, drought Colorano disturbed gross, medicult, go et di |

STORMWATER POND AQUATIC BENCH PLANTING **SCHEDULE**

SCALE: NO SCALE


CARRINGTON POND AQUATIC BENCH


SCALE: NO SCALE

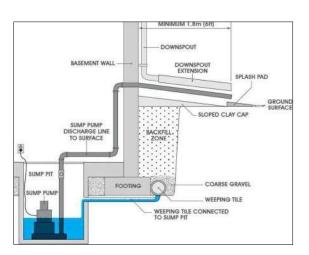

SUMP - ROOF DRAIN ROUTING

SCALE: NO SCALE

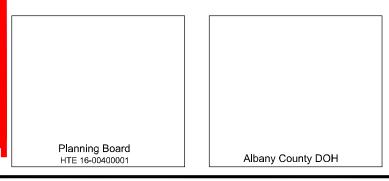

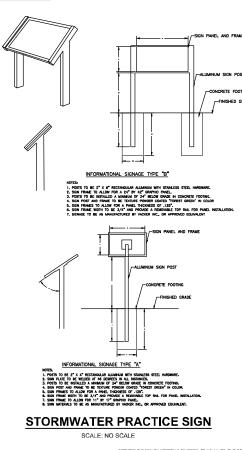

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PHILLIPIN KILL Manor Major Subdivision


> TOWN OF BETHLEHEM ALBANY COUNTY NEW YORK

PHASE - 1

APPLICANT: WILLIAM J. CADE

Weston & Sampson

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| No. | Date | Description | |
|--------------|----------|----------------|--|
| 1 | 11/22/19 | REVISED PER | |
| | | TOWN COMMENTS | |
| 2 | 02/26/20 | REVISED PER | |
| | | TOWN COMMENTS | |
| 3 | 09/02/20 | REVISED PER | |
| | | TOWN COMMENTS | |
| 4 | 01/04/20 | REVISED PER | |
| | | TOWN COMMENTS | |
| 5 | 06/14/21 | REVISED PER | |
| | | TOWN COMMENTS | |
| 6 | 06/29/21 | REVISED PER | |
| | | TOWN COMMENTS | |
| 7 | 09/13/21 | REVISED PER | |
| | | TOWN COMMENTS | |
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| Date | e: | MARCH 30, 2018 | |
| Dra | wn By: | CGC | |
| Reviewed By: | | DTF | |

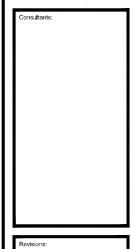
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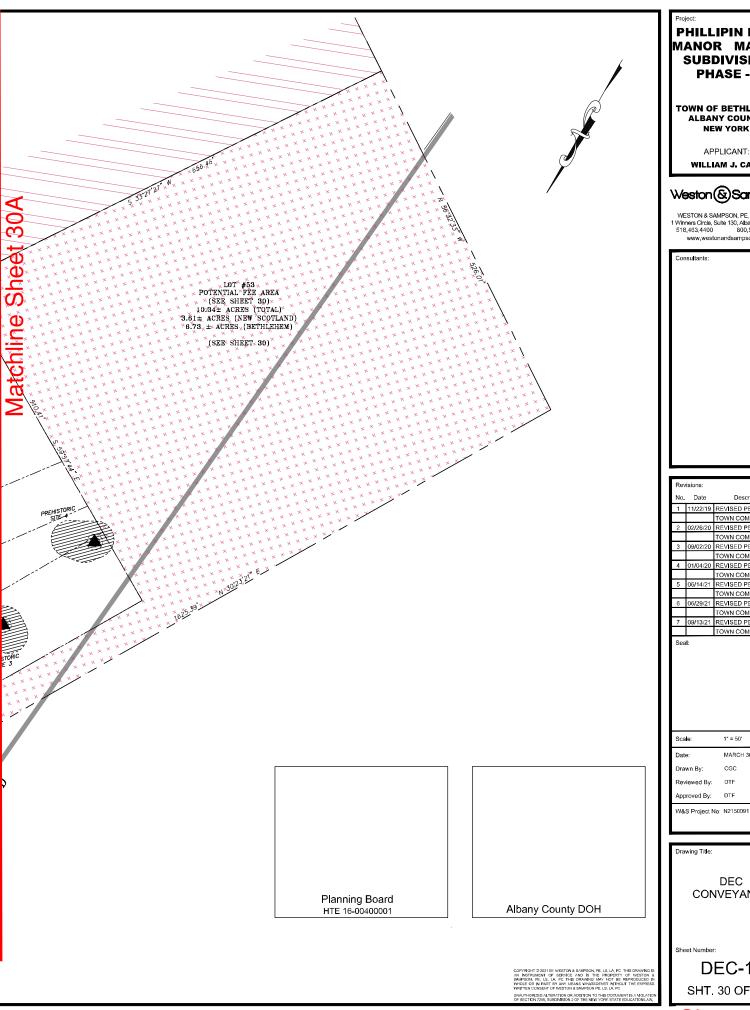
MISCELLANEOUS
DETAILS

Approved By:

W&S Project No: N2150091

D-4 SHT. 25 OF 30



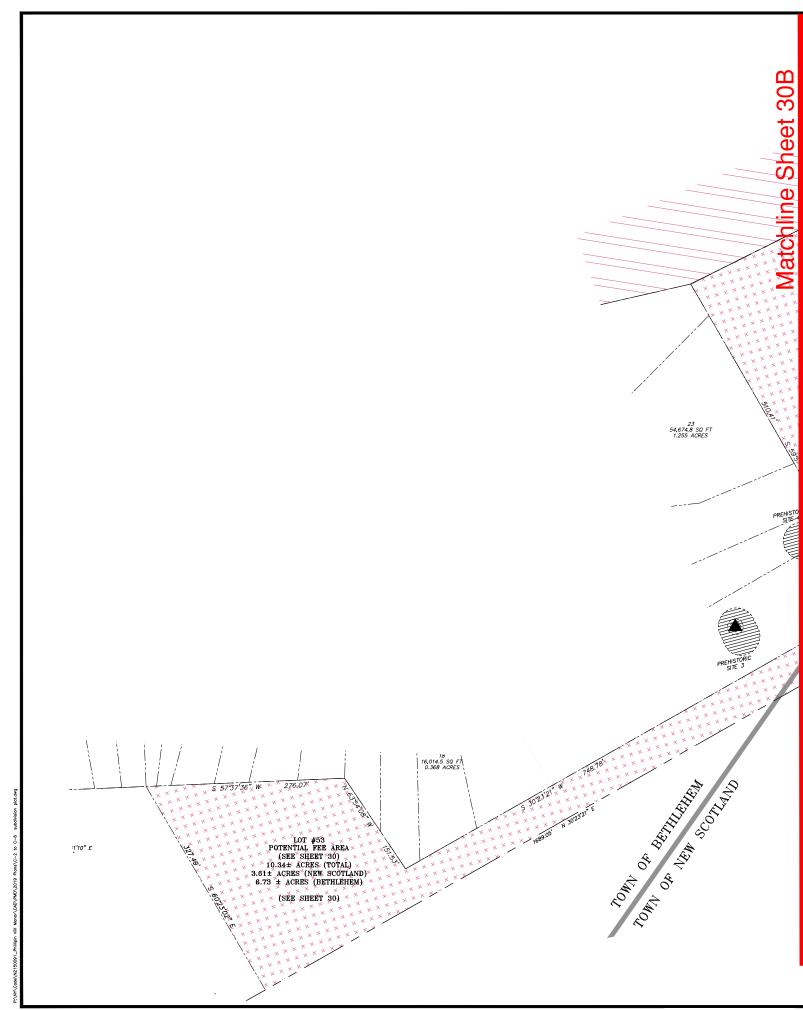

PHILLIPIN KILL

MANOR MAJOR **SUBDIVISION** PHASE - 1

TOWN OF BETHLEHEM ALBANY COUNTY NEW YORK

APPLICANT: WILLIAM J. CADE

Weston & Sampson

WESTON & SAMPSON, PE, LS, LA, PC 1 Winners Circle, Suite 130, Albany, NY 12205 518.463.4400 800 SAMPSON www.westonandsampson.com

| Consultants: |
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| NO. | Date | Description |
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| 1 | 11/22/19 | REVISED PER |
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| | | TOWN COMMENTS |
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| | | TOWN COMMENTS |
| 6 | 06/29/21 | REVISED PER |
| | | TOWN COMMENTS |
| 7 | 09/13/21 | REVISED PER |
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| Sca | ale: | 1" = 50" |
| Sca | | 1" = 50" MARCH 30, 2018 |

Drawing Title:

DEC CONVEYANCE

DEC-1

SHT. 30 OF 30